
HARRIMAN UTILITY BOARD 2017 HARRIMAN CDBG WATER SYSTEM IMPROVEMENTS PROJECT - PHASE II STATE CONTRACT NO. 12079

DRAWING INDEX


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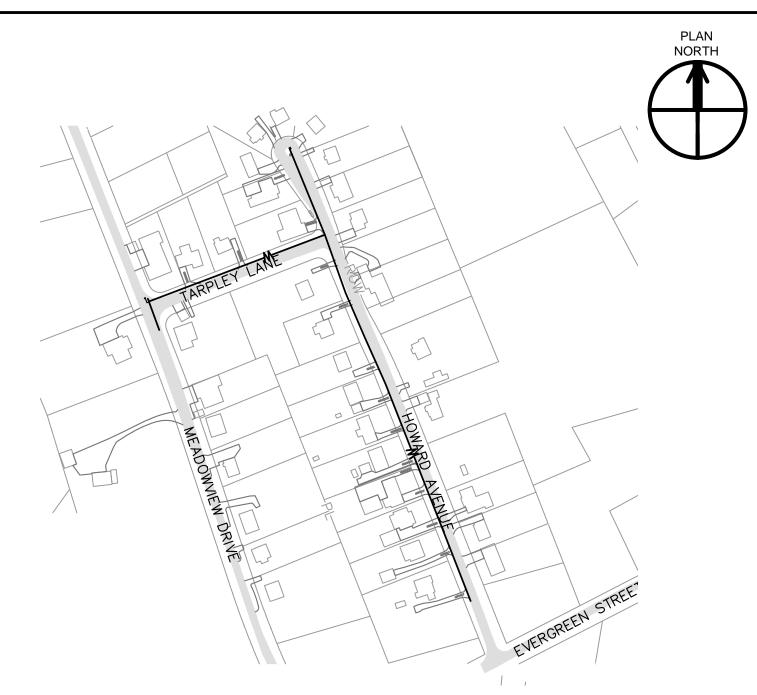


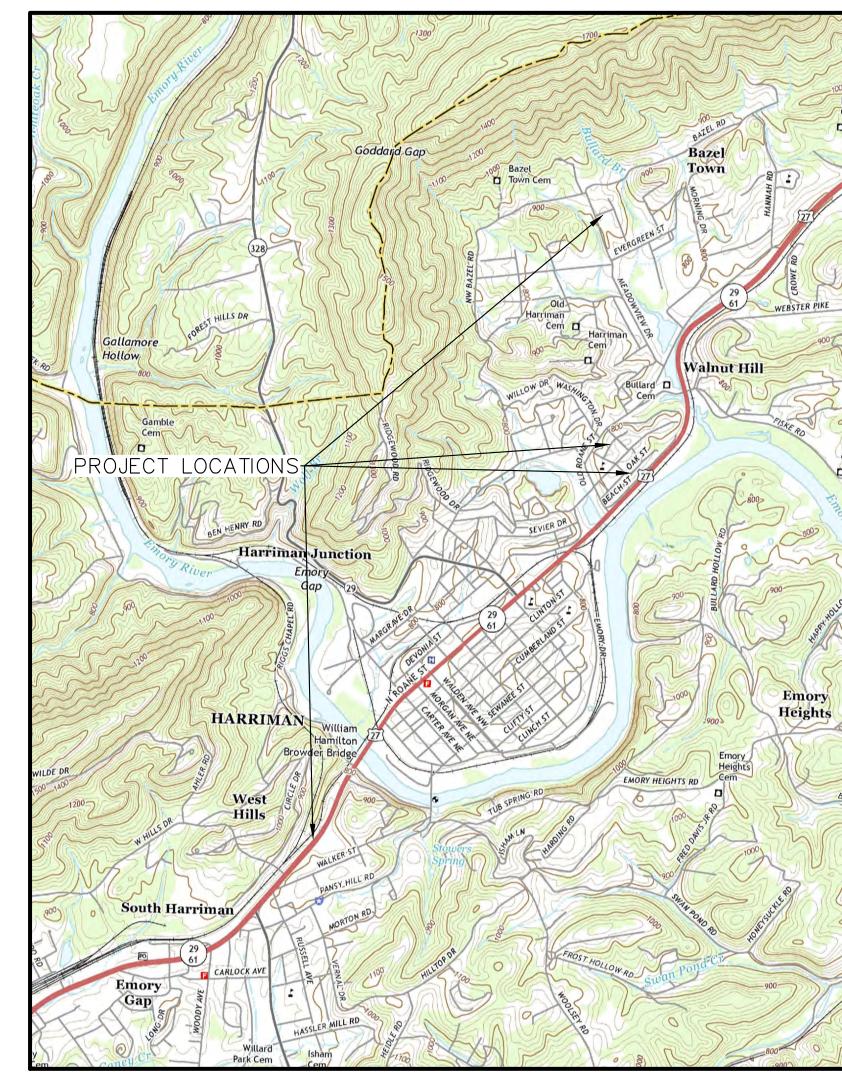

I CERTIFY THAT THESE PLANS HAVE BEEN REVIEWED AND APPROVED BY THE HARRIMAN UTILITY BOARD

CANDACE VANNASDALE, PE DATE MANAGER OF GWS ADMINISTRATION & ENGINEERING

JOHN KING, PE TENNESSEE LICENSE NO. 103702

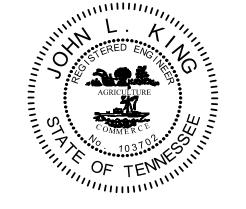

HOWARD AVENUE & TARPLEY LANE GENERAL PLAN

SCALE: 1" = 200'

GENERAL NOTES

GRADING AND EXCAVATION

- 1. WHEN SPECIFIC GRADING REQUIREMENTS ARE NOT SHOWN ON THE DRAWINGS, THE CONTRACTOR SHALL GRADE ALL AREAS WITHIN THE LIMITS OF CONSTRUCTION, OR OTHERWISE DISTURBED BY CONSTRUCTION, TO DRAIN AND TO MATCH THE EXISTING, ADJACENT GROUND.
- 2. THE CONTRACTOR SHALL PERFORM ALL NECESSARY STRIPPING OF EXISTING TOPSOIL ON THE JOBSITE.
- 3. ON THE PROJECT, NEWLY GRADED, EARTH AREAS NOT TO BE PAVED, RIP—RAPPED, OR STABILIZED, SHALL BE SEEDED IN ACCORDANCE WITH THE SPECIFICATIONS. PRIOR TO SEEDING, A FOUR INCH LAYER OF TOPSOIL SHALL BE PLACED ON THESE AREAS IN ACCORDANCE WITH SAID SPECIFICATIONS.
- 4. THE CONTRACTOR SHALL DISPOSE OF, AT HIS OWN EXPENSE, ALL UNSUITABLE AND/OR SURPLUS, EXCAVATED MATERIAL.
- 5. EXCAVATION ADJACENT TO EXISTING PAVEMENT SHALL BE MADE TO A NEAT LINE.
- 6. ALL TREES THAT ARE CUT OR KNOCKED DOWN WITHIN THE LIMITS OF CONSTRUCTION SHALL BE REMOVED AND DISPOSED OF OFF-SITE AT THE CONTRACTOR'S EXPENSE. BURNING SHALL NOT BE PERMITTED.
- 7. BACKFILLING, COMPACTING, GRADING, AND SITE-CLEANUP SHALL OCCUR DAILY AS PIPE INSTALLATION

EROSION/POLLUTION CONTROL

- 8. ALL LOCAL, STATE, AND FEDERAL EROSION CONTROL REQUIREMENTS SHALL BE FOLLOWED DURING CONSTRUCTION. THE CONTRACTOR SHALL TAKE ALL NECESSARY MEASURES TO CONTROL EROSION AND WATER POLLUTION THROUGH THE CONSTRUCTION PERIOD. ALL TEMPORARY EROSION CONTROL MEASURES SHALL BE IN PLACE BEFORE EXCAVATION OPERATIONS BEGIN. CLEARING AND GRUBBING SHALL BE HELD TO A MINIMUM WIDTH NECESSARY TO ACCOMMODATE CONSTRUCTION SLOPES. EMBANKMENTS AND EXCAVATED AREAS SHALL BE PROMPTLY STABILIZED TO MINIMIZE EROSION. BALED STRAW EROSION CHECKS AND SILT FENCE SHALL BE USED ALONG THE TOE OF FILL SLOPES, IN DITCHES, AND IN OTHER AREAS WHERE EROSION IS A PROBLEM AND SILT—LADEN RUNOFF MAY ENTER A DRAINAGE DITCH, STREAM OR ADJACENT
- 9. ANY STOCKPILED SOIL OR FILL MATERIAL SHALL BE LOCATED AND TREATED IN A MANNER TO PREVENT SILT ENTERING STREAMS. NO EXCAVATED MATERIAL SHALL BE DISCHARGED INTO DITCHES. THE CONTRACTOR SHALL DISPOSE OF ALL EXCAVATED MATERIAL IN A LOCATION, APPROVED BY THE ENGINEER, ABOVE THE NORMAL HIGH WATER ELEVATION.
- 10. THE CONTRACTOR IS RESPONSIBLE FOR ADHERING TO ALL EROSION CONTROL PROVISIONS AS SET FORTH IN THE EROSION & SEDIMENT CONTROL HANDBOOK AVAILABLE FROM THE TENNESSEE DEPARTMENT OF ENVIRONMENT AND CONSERVATION.
- 11. THE CONTRACTOR SHALL IMPLEMENT EROSION CONTROL MEASURES AS SHOWN ON THE EROSION CONTROL PLAN AND SHALL MAINTAIN THE EROSION CONTROL MEASURES THROUGHOUT THE LENGTH OF THE CONTRACT AS REQUIRED.
- 12. THE CONTRACTOR SHALL PROVIDE TEMPORARY EROSION AND WATER CONTROL MEASURES (SUCH AS WATTLES, CHECK DAMS, WASHOUTS, AND SILT FENCES, ETC.) AS SHOWN ON THE EROSION CONTROL PLAN AND AS DIRECTED BY THE ENGINEER. THESE TEMPORARY MEASURES SHALL BE COORDINATED WITH THE PERMANENT EROSION CONTROL FEATURES TO ASSURE ECONOMICAL, EFFECTIVE, AND CONTINUOUS EROSION CONTROL THROUGHOUT THE PROJECT.

UTILITIES

- 13. LOCATIONS OF UTILITIES, PUBLIC AND/OR PRIVATE, ARE APPROXIMATE ONLY, AND THE EXACT LOCATIONS SHALL BE DETERMINED IN THE FIELD. IT IS POSSIBLE THAT SOME EXISTING FACILITIES ARE NOT SHOWN ON THESE DRAWINGS. THE CONTRACTOR SHALL BE RESPONSIBLE FOR HAVING ALL UNDERGROUND UTILITY FACILITIES LOCATED AND MARKED PRIOR TO THE BEGINNING OF CONSTRUCTION.
- 14. THE CONTRACTOR SHALL NOTIFY ALL AFFECTED UTILITY OWNERS PRIOR TO INTERRUPTING ANY ELECTRICAL, COMMUNICATIONS, GAS, WATER, OR SEWER SERVICES. THE CONTRACTOR SHALL ALSO NOTIFY AFFECTED UTILITY CUSTOMERS AT LEAST 24 HOURS BEFORE INTERRUPTING THE CUSTOMERS' SERVICE. WHERE INDIVIDUAL SERVICES ARE TO BE DISCONTINUED FOR MORE THAN 4 HOURS, THE CONTRACTOR SHALL MAKE ARRANGEMENTS FOR PROVIDING TEMPORARY SERVICE SATISFACTORY TO THE AFFECTED CUSTOMER. THE REPAIR OR REPLACEMENT OF UTILITY COMPONENTS SHALL CONFORM TO ALL APPLICABLE REQUIREMENTS OF THE UTILITY OWNER. NO SEPARATE PAYMENT SHALL BE MADE FOR THESE ACTIVITIES, AND COMPENSATION, THEREFORE, SHALL BE INCLUDED IN THE CONTRACT PRICES FOR OTHER ITEMS.
- 15. THE CONTRACTOR SHALL PROVIDE ALL NECESSARY PROTECTIVE MEASURES TO SAFEGUARD EXISTING UTILITIES FROM DAMAGE DURING CONSTRUCTION OF THIS PROJECT. SHOULD SPECIAL EQUIPMENT BE REQUIRED TO WORK OVER AND AROUND THE UTILITIES, THE CONTRACTOR SHALL BE REQUIRED TO FURNISH SUCH EQUIPMENT. THE COST OF PROTECTING UTILITIES FROM DAMAGE AND FOR FURNISHING SPECIAL EQUIPMENT SHALL BE INCLUDED IN THE PRICE BID FOR OTHER ITEMS OF CONSTRUCTION.



BIRCH
BEECH & WALNUT STREET GENERAL PLAN

SCALE: 1" = 200'

UTILITIES (CONTINUED)

- 16. IF ANY UTILITY IS DAMAGED DURING CONSTRUCTION, THE CONTRACTOR SHALL IMMEDIATELY NOTIFY THE UTILITY OWNER. REPAIR OF THE UTILITY SHALL THEN BE ACCORDING TO THE OWNER'S INSTRUCTIONS.
- 17. ALL CUTS AND FILLS SHALL BE IN PLACE, AND ALL FILLS COMPACTED, PRIOR TO THE INSTALLATION OF WATER LINES AND APPURTENANCES.
- 18. TRANSITION JOINTS ON PIPES OF DIFFERENT MATERIALS MUST BE APPROVED BY THE ENGINEER, AND CONSTRUCTION MUST BE DONE WITH APPROVED FITTINGS AND/OR ADAPTERS.
- 19. ALL PROPOSED PIPING AND MISCELLANEOUS APPURTENANCES SHALL BE INSTALLED IN ACCORDANCE WITH THE CONTRACT DOCUMENTS, CONTRACT DRAWINGS, AND SPECIFICATIONS.
- 20. WHERE WATER PIPE CROSSES THE SEWER MAIN, THE WATER PIPE WITHIN 10 FEET OF THE POINT OF CROSSING SHALL BE AT LEAST 18 INCHES ABOVE THE SEWER MAIN OR THE WATER PIPE SHALL BE ENCASED.
- 21. TOPS OF ALL BOXES SHALL BE RAISED FLUSH WITH FINISHED GRADES AND BE VISIBLE.
- 22. THE WATER LINES SHALL BE TESTED AND APPROVED PER THE REQUIREMENTS OF THE SPECIFICATIONS.
- 23. THE CROWN OF THE WATER LINES SHALL BE INSTALLED AT A MINIMUM DEPTH OF 36-INCHES BELOW THE EXISTING SURFACE WITHIN RIGHTS-OF-WAY AND 30-INCHES BELOW THE EXISTING SURFACE IN OTHER AREAS EXCEPT WHERE ADDITIONAL BURIAL IS NEEDED TO ACCOMMODATE INSTALLATION OF APPURTENANCES AND CROSSINGS.
- 24. THE CROWN OF THE WATER LINES SHALL BE INSTALLED AT A MINIMUM DEPTH OF 30—INCHES LOWER THAN THE SURFACE OF ADJACENT ROADWAYS SO AS TO ALLOW FUTURE DRIVEWAY CUTS THAT WILL NOT IMPACT OR DISTURB THE WATER LINE.

MISCELLANEOUS

- 25. THE ENGINEER SHALL HAVE THE AUTHORITY TO DESIGNATE AND/OR LIMIT AREAS OF CONSTRUCTION.
- 26. THE OWNER MAKES NO REPRESENTATIONS ABOUT SUBSURFACE CONDITIONS THAT MAY BE ENCOUNTERED WITHIN THE LIMITS OF THE PROJECT. THE CONTRACTOR SHOULD SATISFY HIMSELF BY ON SITE INSPECTIONS, CORE DRILLINGS, OR OTHER METHODS OF THE SUBSURFACE CONDITIONS THAT MAY BE ENCOUNTERED. THE RISK OF ENCOUNTERING AND CORRECTING UNFAVORABLE SUBSURFACE CONDITIONS SHALL BE BORNE SOLELY BY THE CONTRACTOR.
- 27. IT SHALL BE THE RESPONSIBILITY OF THE CONTRACTOR TO PROVIDE ALL FIELD LAYOUTS.
- 28. THE CONTRACTOR SHALL BE RESPONSIBLE FOR THE PAYMENT FOR TESTING. THE CONTRACTOR SHALL BE RESPONSIBLE FOR COORDINATING AND ORDERING APPROPRIATE TESTS AS REQUIRED.
- 29. THE CONTRACTOR SHALL PROVIDE RECORD DRAWINGS OF THE PROJECT WITHIN TEN (10) DAYS AFTER SUBSTANTIAL COMPLETION OF THE WORK.
- 30. SHOULD THERE BE A CONFLICT BETWEEN THESE GENERAL NOTES, CONTRACT DRAWINGS, AND/OR SPECIFICATIONS, THE MOST RESTRICTIVE INTERPRETATION IN FAVOR OF THE OWNER SHALL PREVAIL. THE CONTRACTOR SHALL BE RESPONSIBLE FOR OBTAINING ANY CLARIFICATION OR INTERPRETATION OF GENERAL NOTES, CONTRACT DRAWINGS, AND/OR SPECIFICATIONS, IN ADVANCE AND IN WRITING, FROM THE ENGINEER.
- 31. MAIN AND SERVICE LINE PIPING INCLUDING APPURTENANCES SHALL "PASS" PRESSURE TESTING PRIOR TO ANY PAYMENT BY THE OWNER FOR THOSE ITEMS.
- 32. ALL 2-INCH POLYETHYLENE PIPE SHALL BE CONTINUOUS WITH NO "BUTT FUSED" CONNECTIONS.



SOUTH ROANE STREET GENERAL PLAN
SCALE: 1" = 200'

UTILITY OWNERS

HARRIMAN UTILITY BOARD
300 NORTH ROANE STREET
HARRIMAN, TN 37748
ELECTRIC — HEATH LEWIS (865) 719—9248
GAS, WATER, AND SEWER — JEFF MIZE (865) 755—4173

AT&T TENNESSEE 9733 PARKSIDE DRIVE KNOXVILLE, TN 37922 DAVID OVERMAN (865) 539-8579

XFINITY/COMCAST 5720 ASHEVILLE HIGHWAY KNOXVILLE, TN 37924 JT POPE (865) 862-5060

RECORD DRAWING

THIS DRAWING WAS ORIGINALLY ISSUED BY CTI ENGINEERS, INC.

REVISIONS HAVE BEEN MADE BASED ON INFORMATION PROVIDED BY OTHERS. CTI ENGINEERS HAS REVIEWED THE INFORMATION AND BELIEVES IT REFLECTS THE WORK AS CONSTRUCTED. HOWEVER, ALL PERSONS SHALL VERIFY INFORMATION TAKEN FROM THIS DRAWING





MAPPING INFORMATION (CONTOURS, PROPERTY LINES, ETC.) PROVIDED BY HARRIMAN UTILITY BOARD.

DESCRIPTIONS DATE BY APP'D RECORD DRAWING 11/18 JLK JLK	DATE BY 11/18 JLK	DESCRIPTIONS DATE BY RECORD DRAWING 11/18 JLK
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ENGINEERS, INC.

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KNOXVILLE, TN 37922

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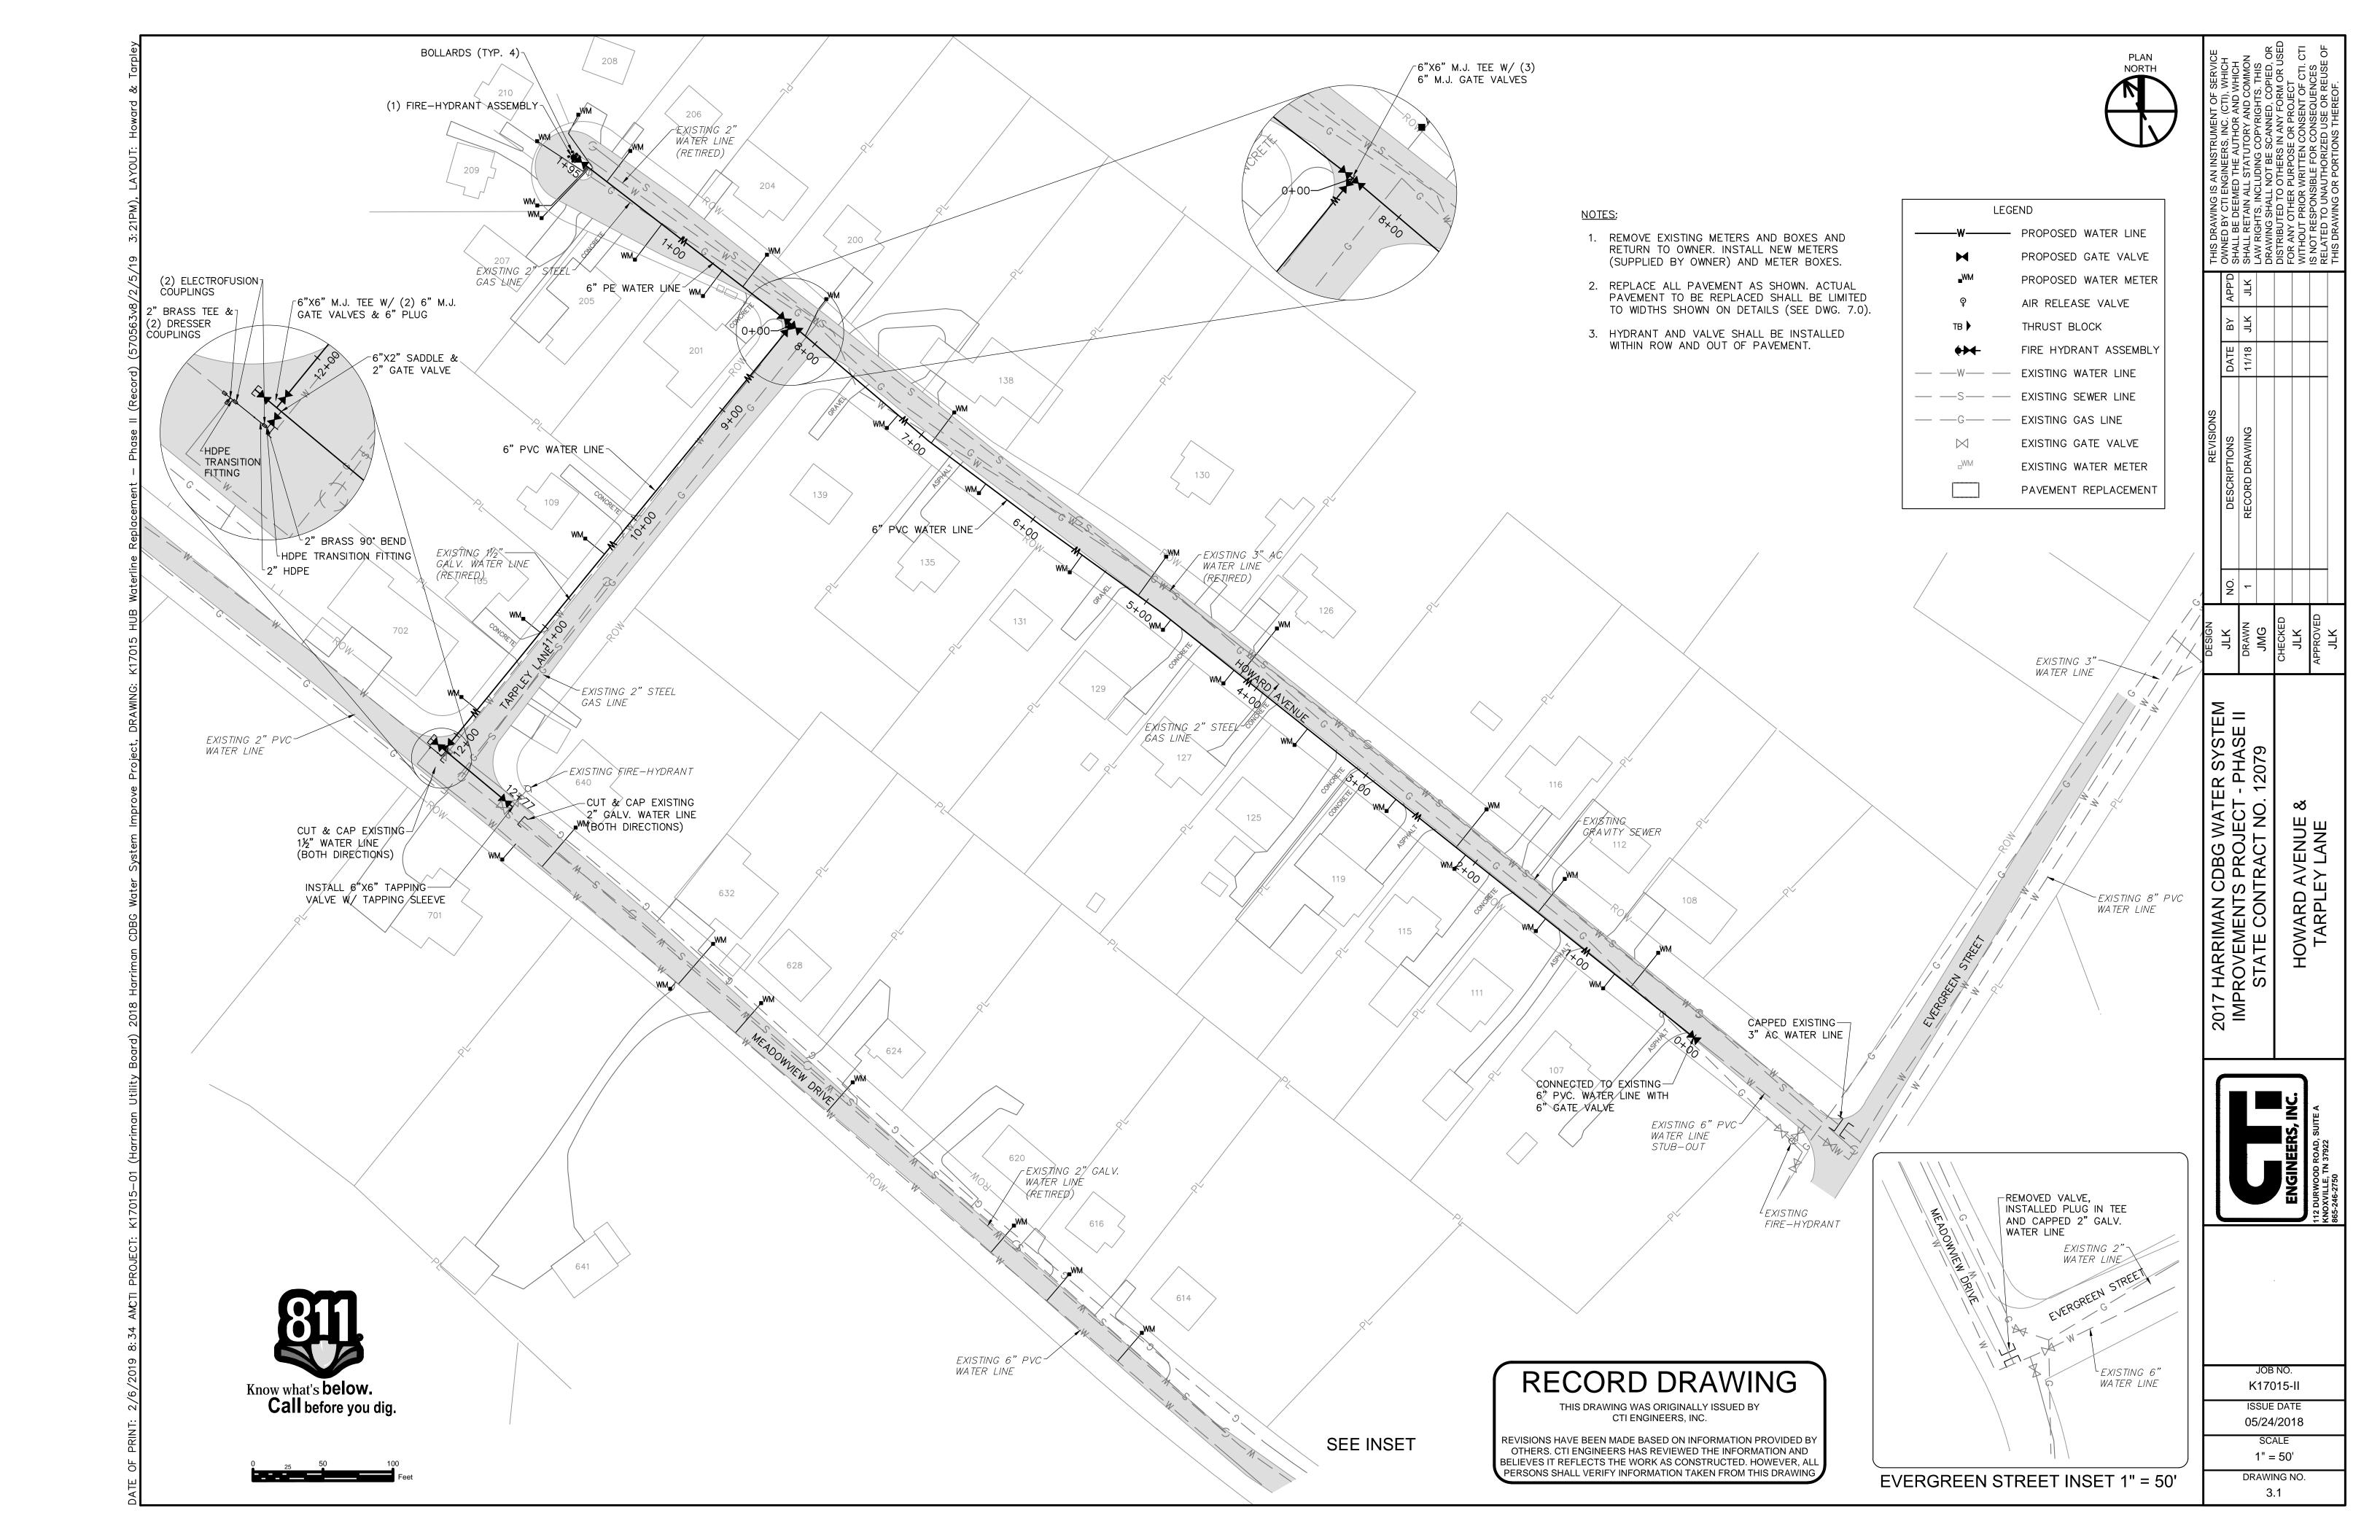
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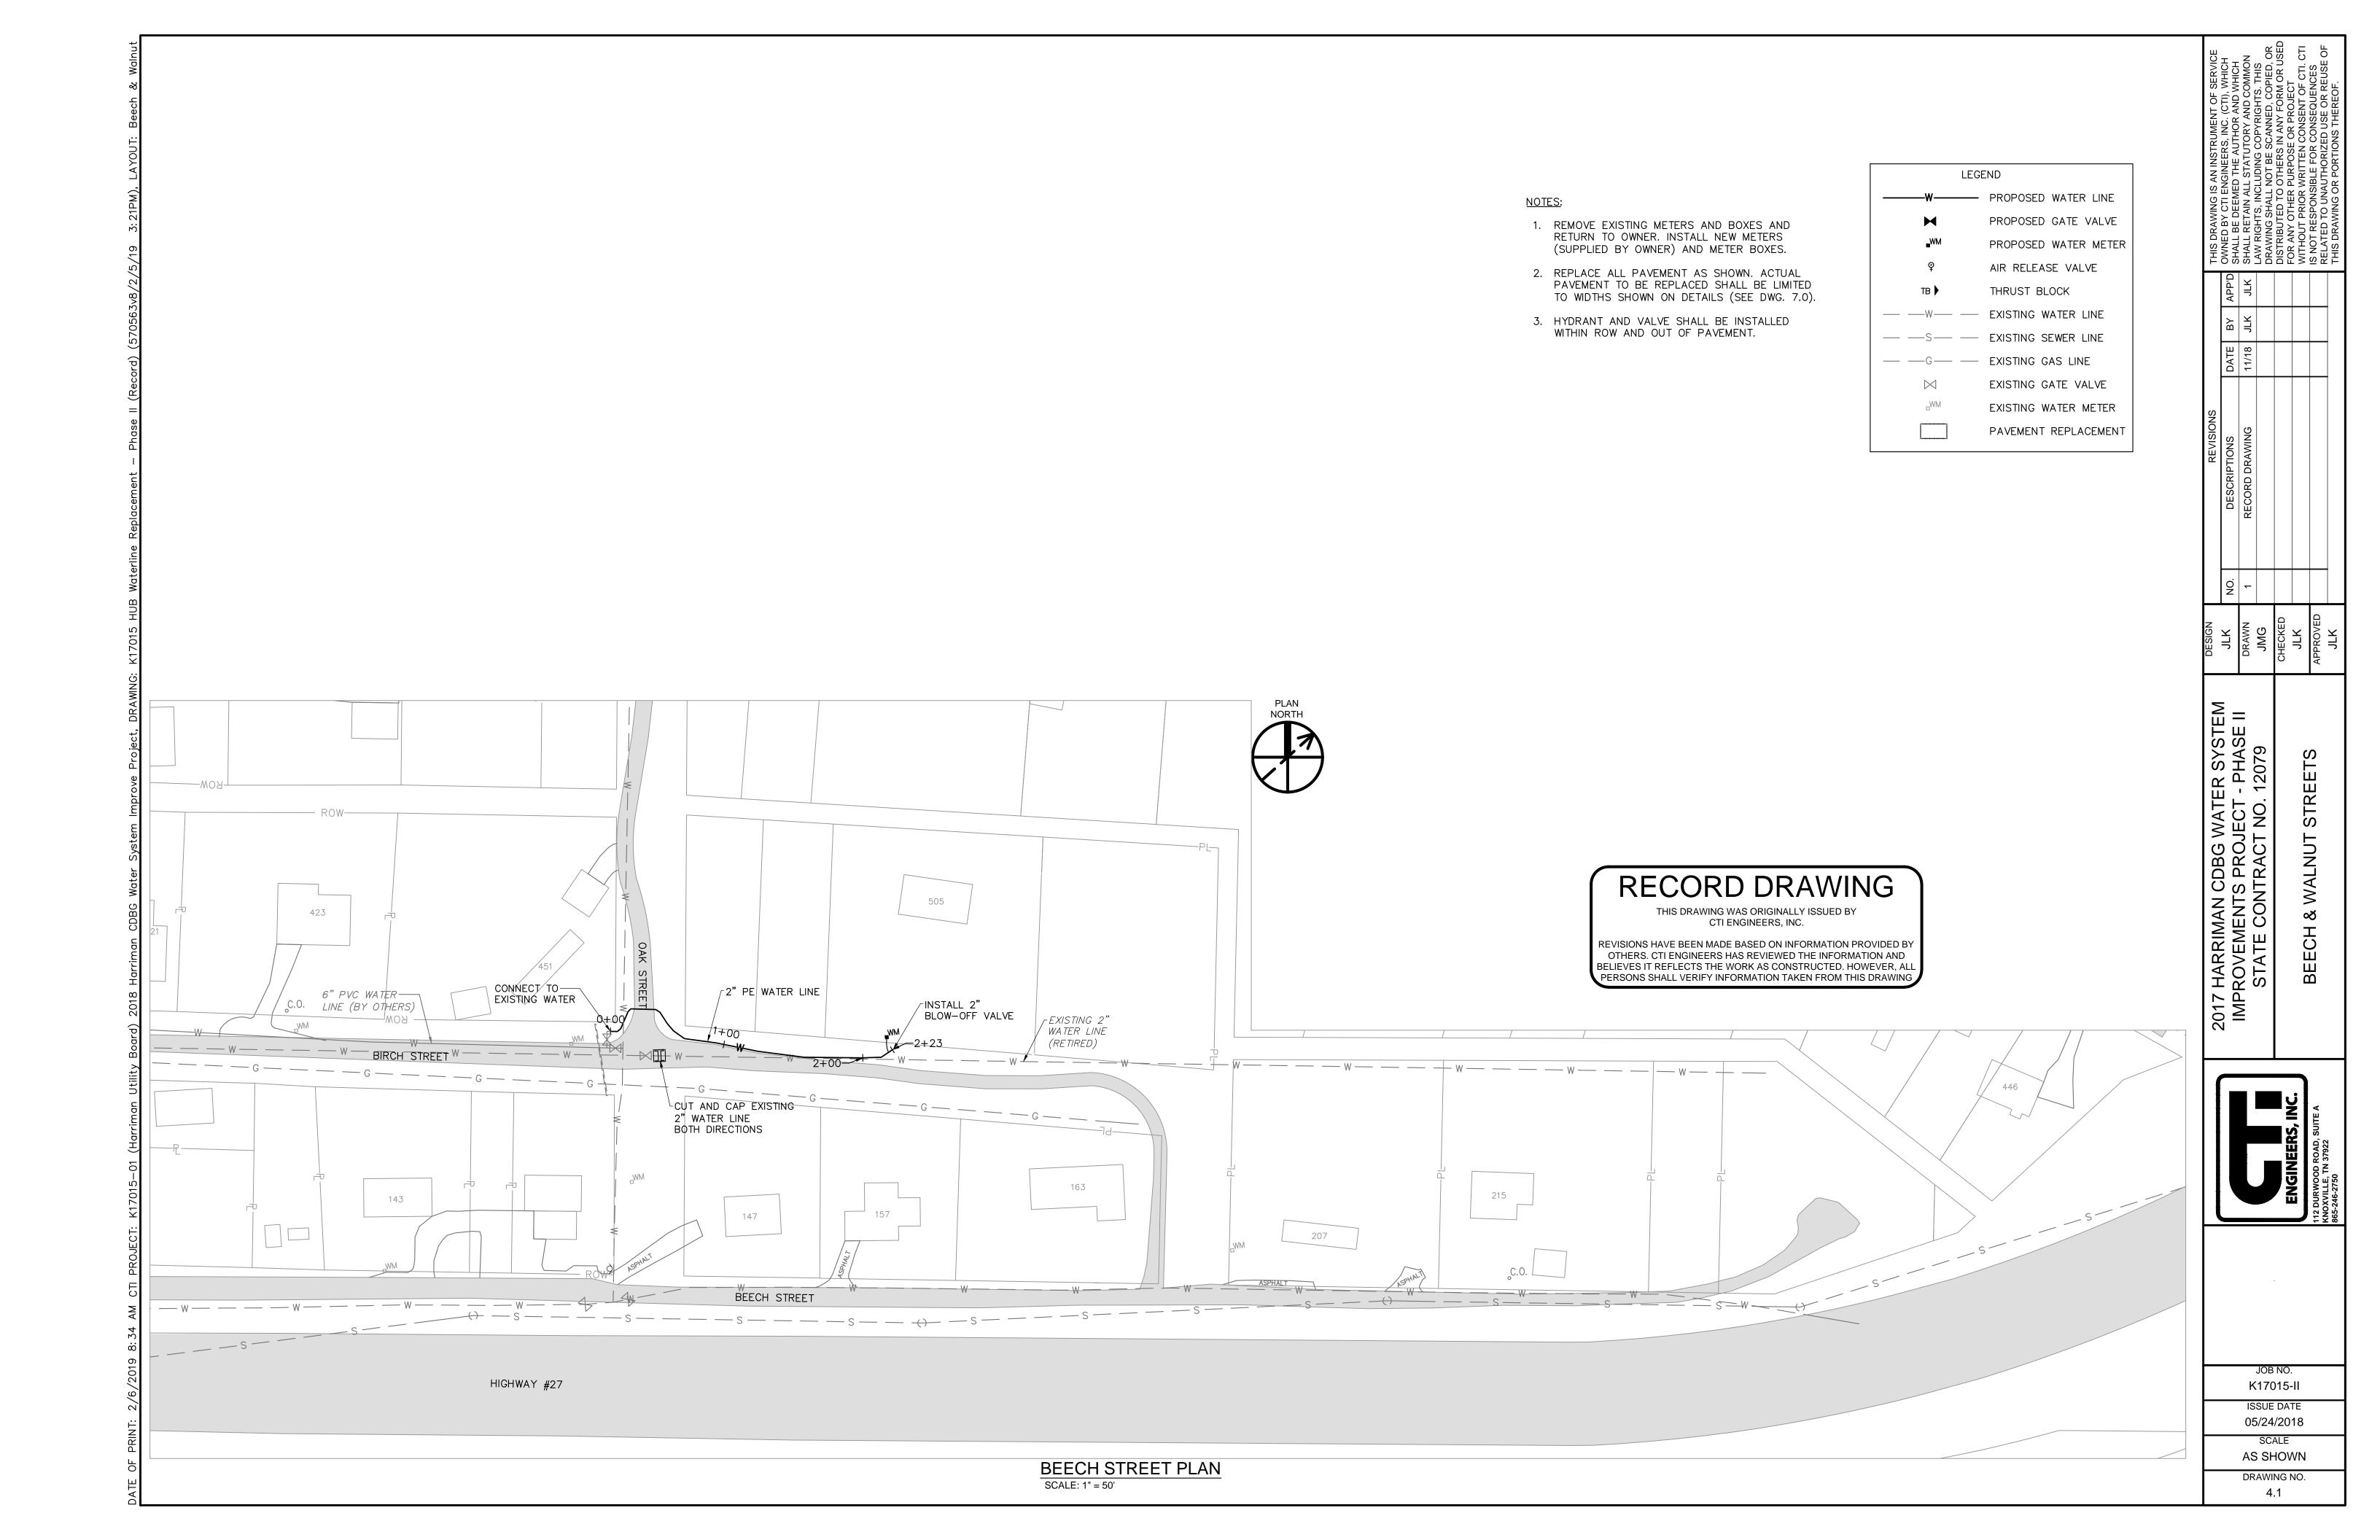
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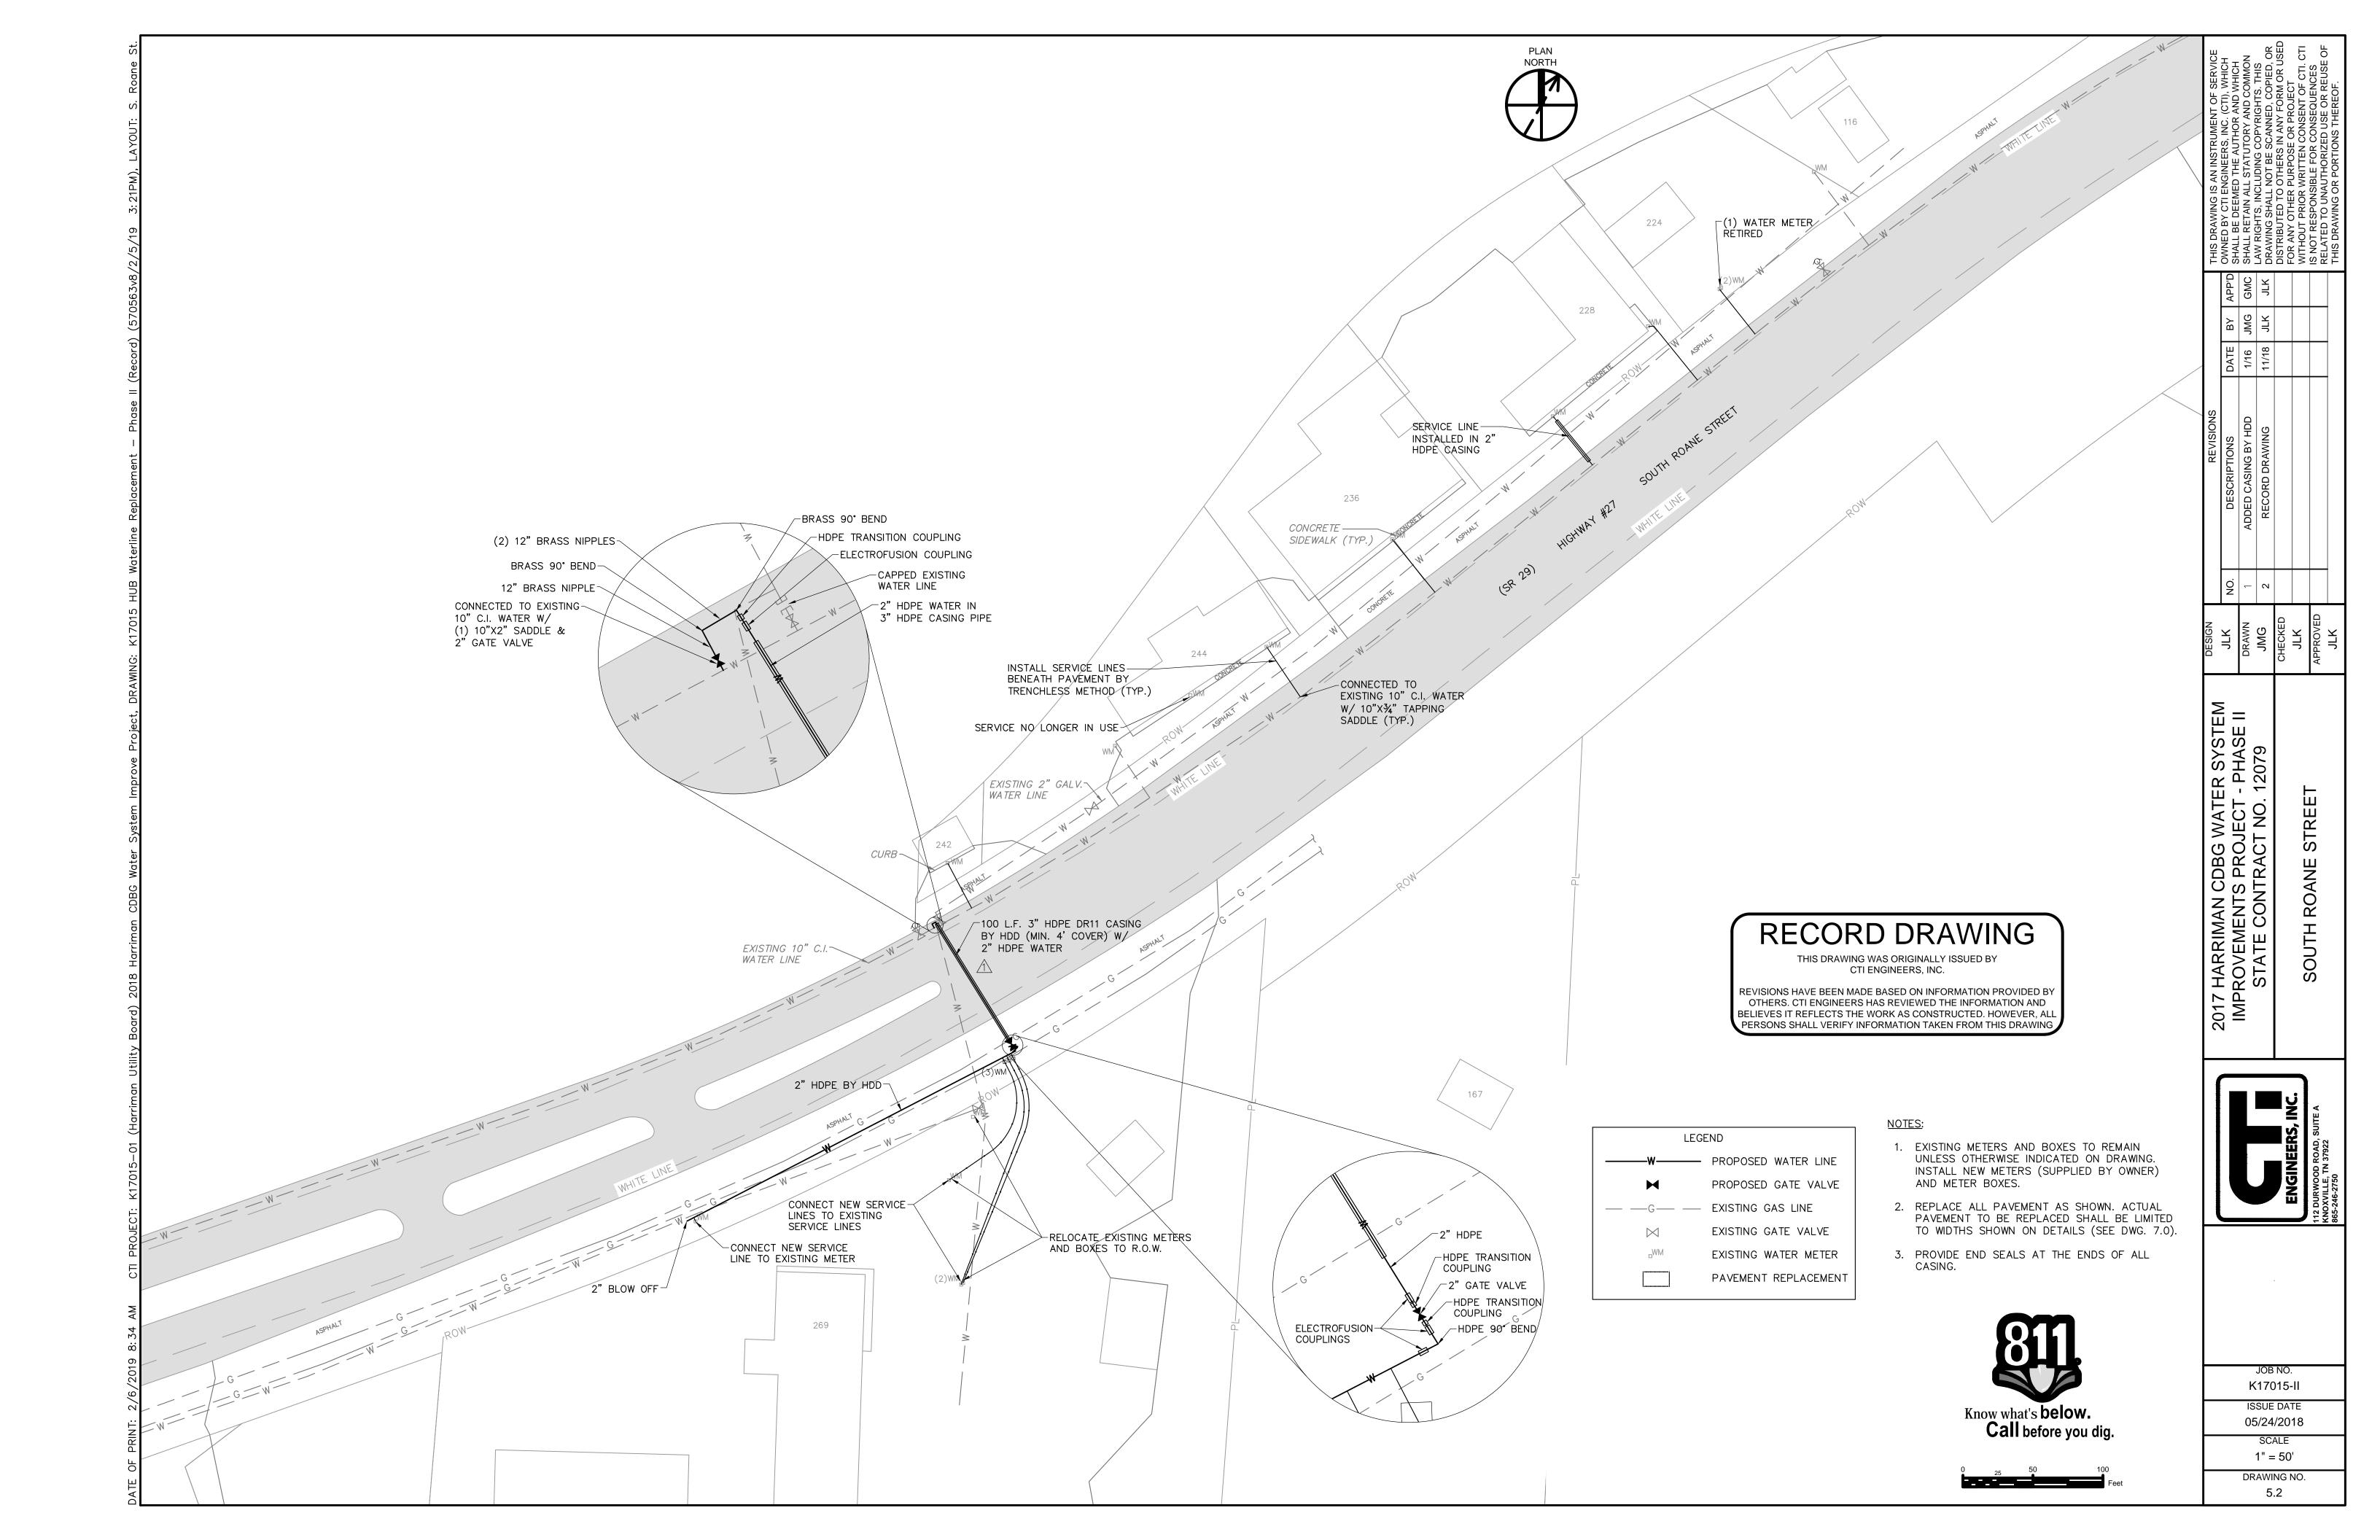
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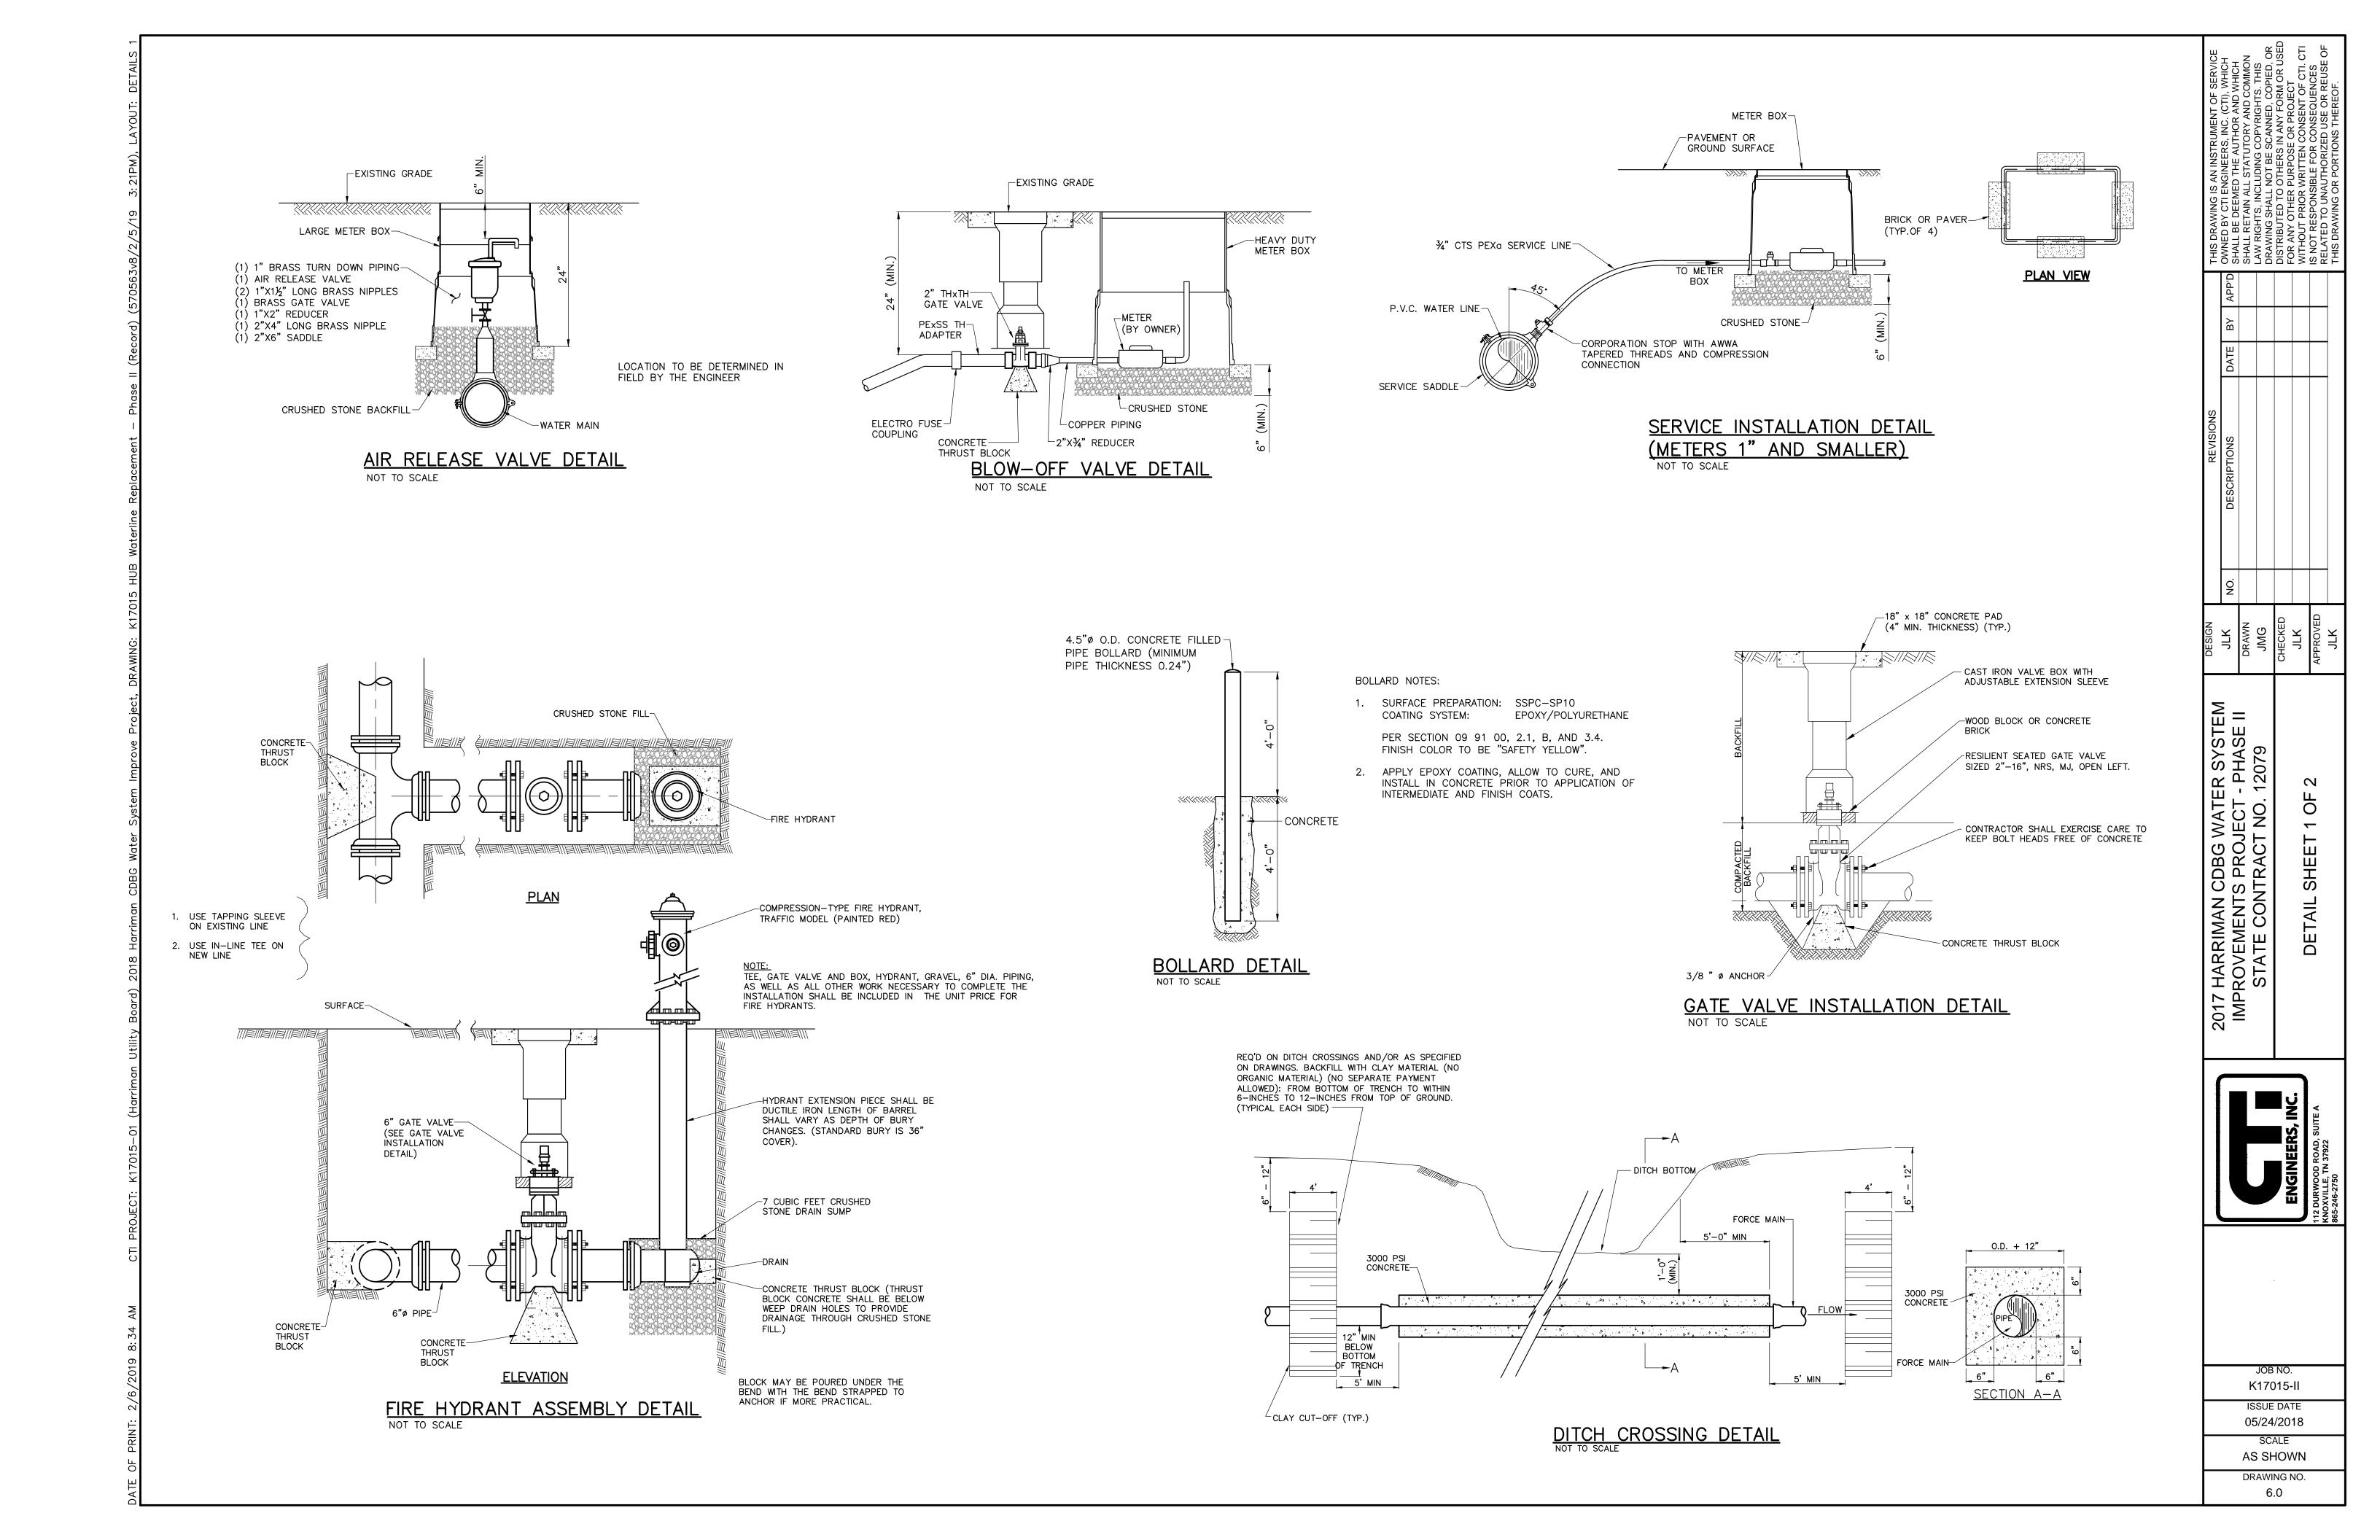
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K17015-II
ISSUE DATE
05/24/2018
SCALE
AS SHOWN


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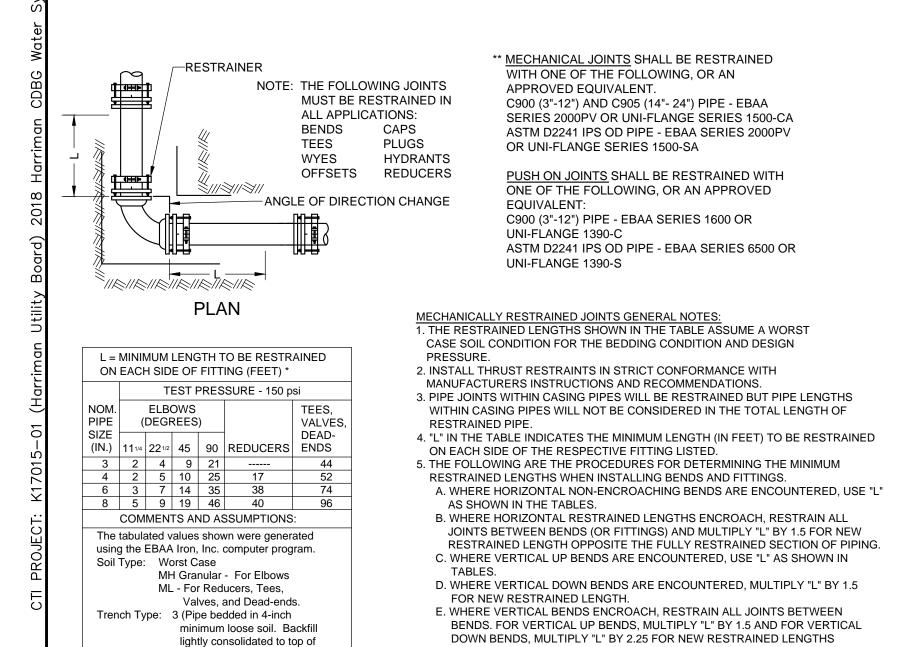








THRUST BLOCK DETAILS

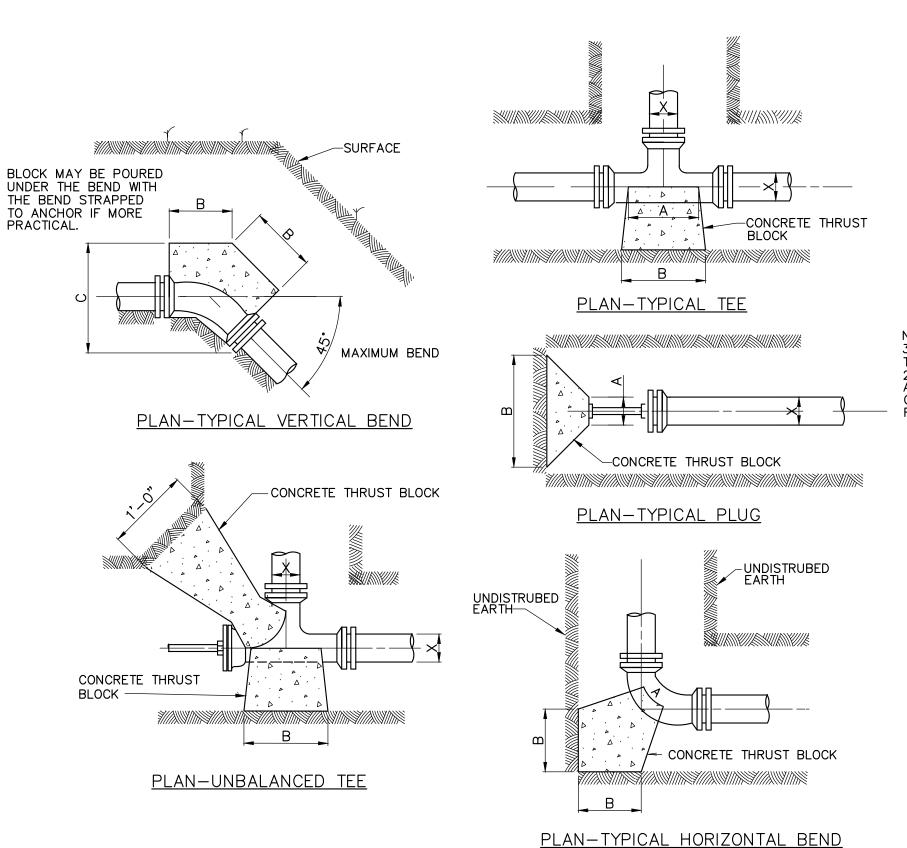

Depth of cover to top of pipe: 3 feet

* Restrain one joint beyond the minimum

size to a pipe one-size smaller.

length for all lengths over 10 feet.

The values shown for the Reducers were

based on a reduction from the nominal pipe

Safety Factor: 1.5

NON ENCROACHING: WHERE FITTINGS ARE INSTALLED AT LOCATIONS WHERE THE CALCULATED MINIMUM RESTRAINED LENGTHS DO NOT OVERLAP.

MECHANICALLY RESTRAINED JOINT DETAIL FOR PVC PIPE

OPPOSITE THE FULLY RESTRAINED SECTION OF PIPE.
6. THE RESTRAINED LENGTHS SHOWN FOR REDUCERS ARE BASED ON A


IF A REDUCTION GREATER THAN ONE SIZE DOWN IS NECESSARY,

ENCROACHING: WHERE FITTINGS ARE INSTALLED AT LOCATIONS CLOSE ENOUGH

TO ONE ANOTHER WHERE THE CALCULATED MINIMUM RESTRAINED LENGTHS

SEE THE ENGINEER FOR THE REQUIRED RESTRAINED LENGTH.


REDUCTION OF ONE SIZE DOWN (I.E. 8 TO 6, 4 TO 3, ETC.).

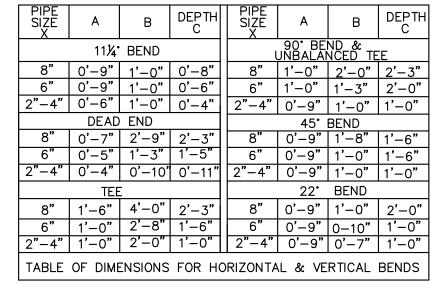


NOTE: ALL CONCRETE FOR THRUST BLOCKS SHALL BE READY—MIXED 3000 psi (MINIMUM) CLASS "B". MIX DESIGN SHALL BE SUBMITTED TO ENGINEER FOR APPROVAL PRIOR TO USE. THRUST BLOCKS BASED ON 225 psi & 2000lb/ft2 SOIL RESISTANCE TYPICAL FOR UNDISTURBED SAND AND GRAVEL CEMENTED WITH CLAY. FOR OTHER SOILS THE BEARING FACE OF THE THRUST BLOCKS SHOULD BE INCREASED BY THE FOLLOWING


SAND 2 SAND & GRAVEL 1.33 SHALE 0.4

SOFT CLAY, MUCK AND PEAT SHALL USE RESTRAINED JOINTS IN LIEU OF THRUST BLOCKS.

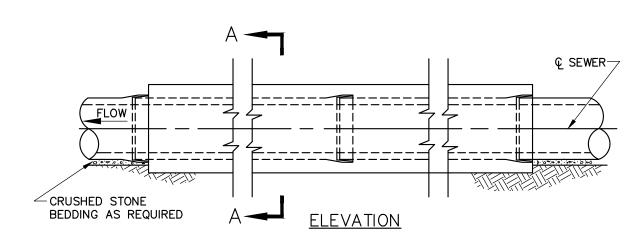


NOTE: CLAY CUT-OFFS SHALL BE CONSTRUCTED AT MINIMUM 500-FOOT INTERVALS ALONG PIPELINE WHERE CRUSHED ROCK EMBEDMENT AND/OR BACKFILL IS USED. SEE DITCH CROSSING DETAIL ABOVE.

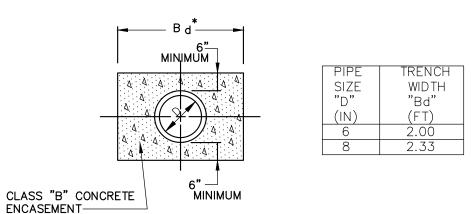


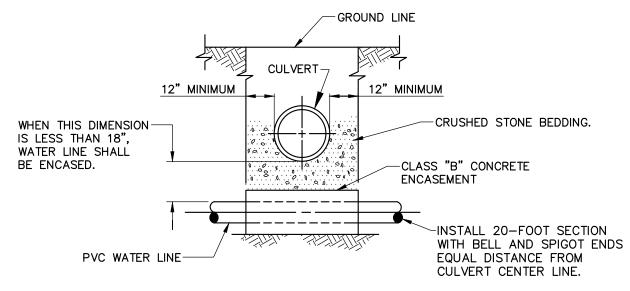

CONCRETE ENCASEMENT

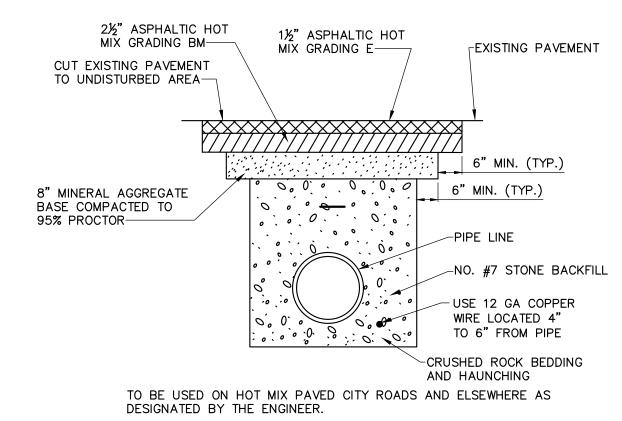

ASPHALT PAVEMENT REPLACEMENT DETAIL
NOT TO SCALE

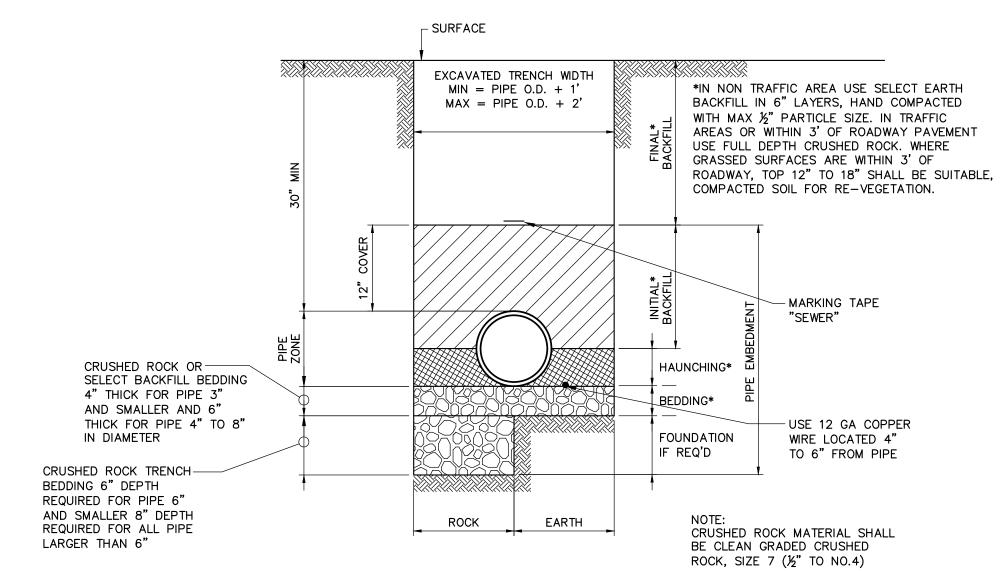


PIPE BEDDING

PAVING NOTES

1. COST OF SAW CUTTING, COMPACTING, MINERAL AGGREGATE, HOT MIX, ETC. TO BE INCLUDED IN THE UNIT PRICE FOR ASPHALT OR OTHER PAVEMENT REPLACEMENT IN THE BID SCHEDULE.

2. IT IS THE INTENTION OF THE OWNER TO INSTALL ALL LINES OUT OF PAVEMENT IF POSSIBLE, IN ROAD SHOULDERS OR DITCHES; IF LINE IS INSTALLED UNDER PAVEMENT FOR CONVENIENCE OF CONTRACTOR, NO SEPARATE PAYMENT WILL BE MADE FOR EXTRA PAVEMENT AND CRUSHED ROCK BACKFILL REQUIRED.

3. CONTRACTOR IS RESPONSIBLE FOR OBTAINING ROAD CUT PERMITS PRIOR TO CUTTING ROADWAY PAVEMENTS.

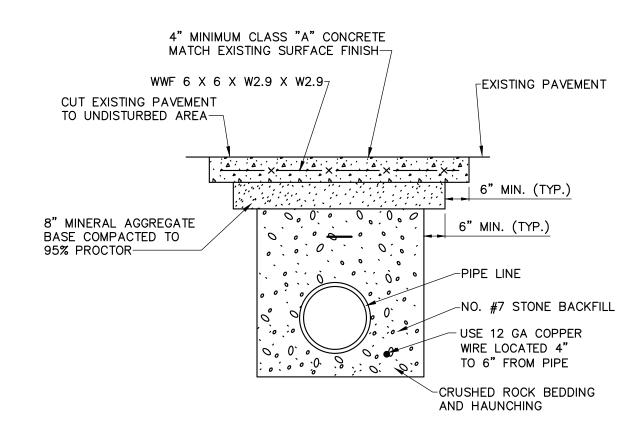

TO BE USED ON CONCRETE DRIVEWAYS AND ELSEWHERE AS DESIGNATED BY THE ENGINEER.

DESIGNATED BY THE ENGINEER.


CONCRETE PAVEMENT REPLACEMENT DETAIL


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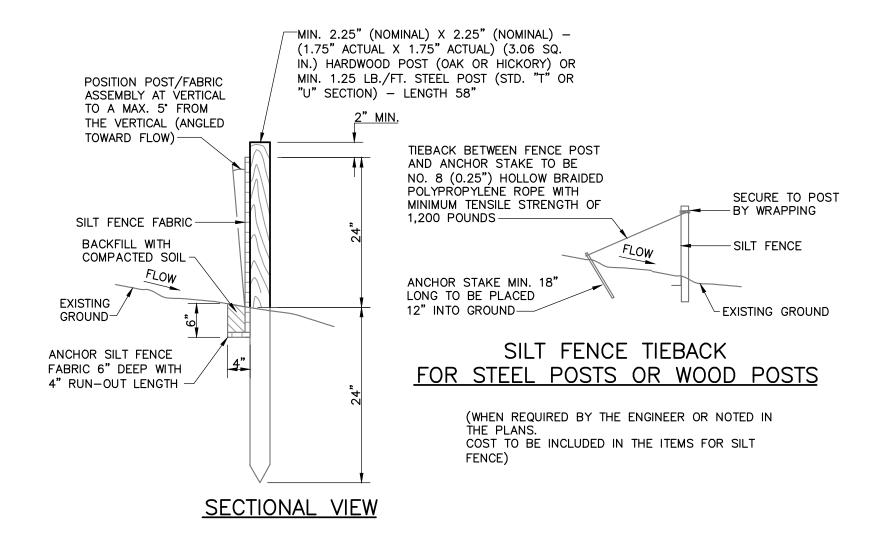
AS SHOWN

DRAWING NO. 7.0



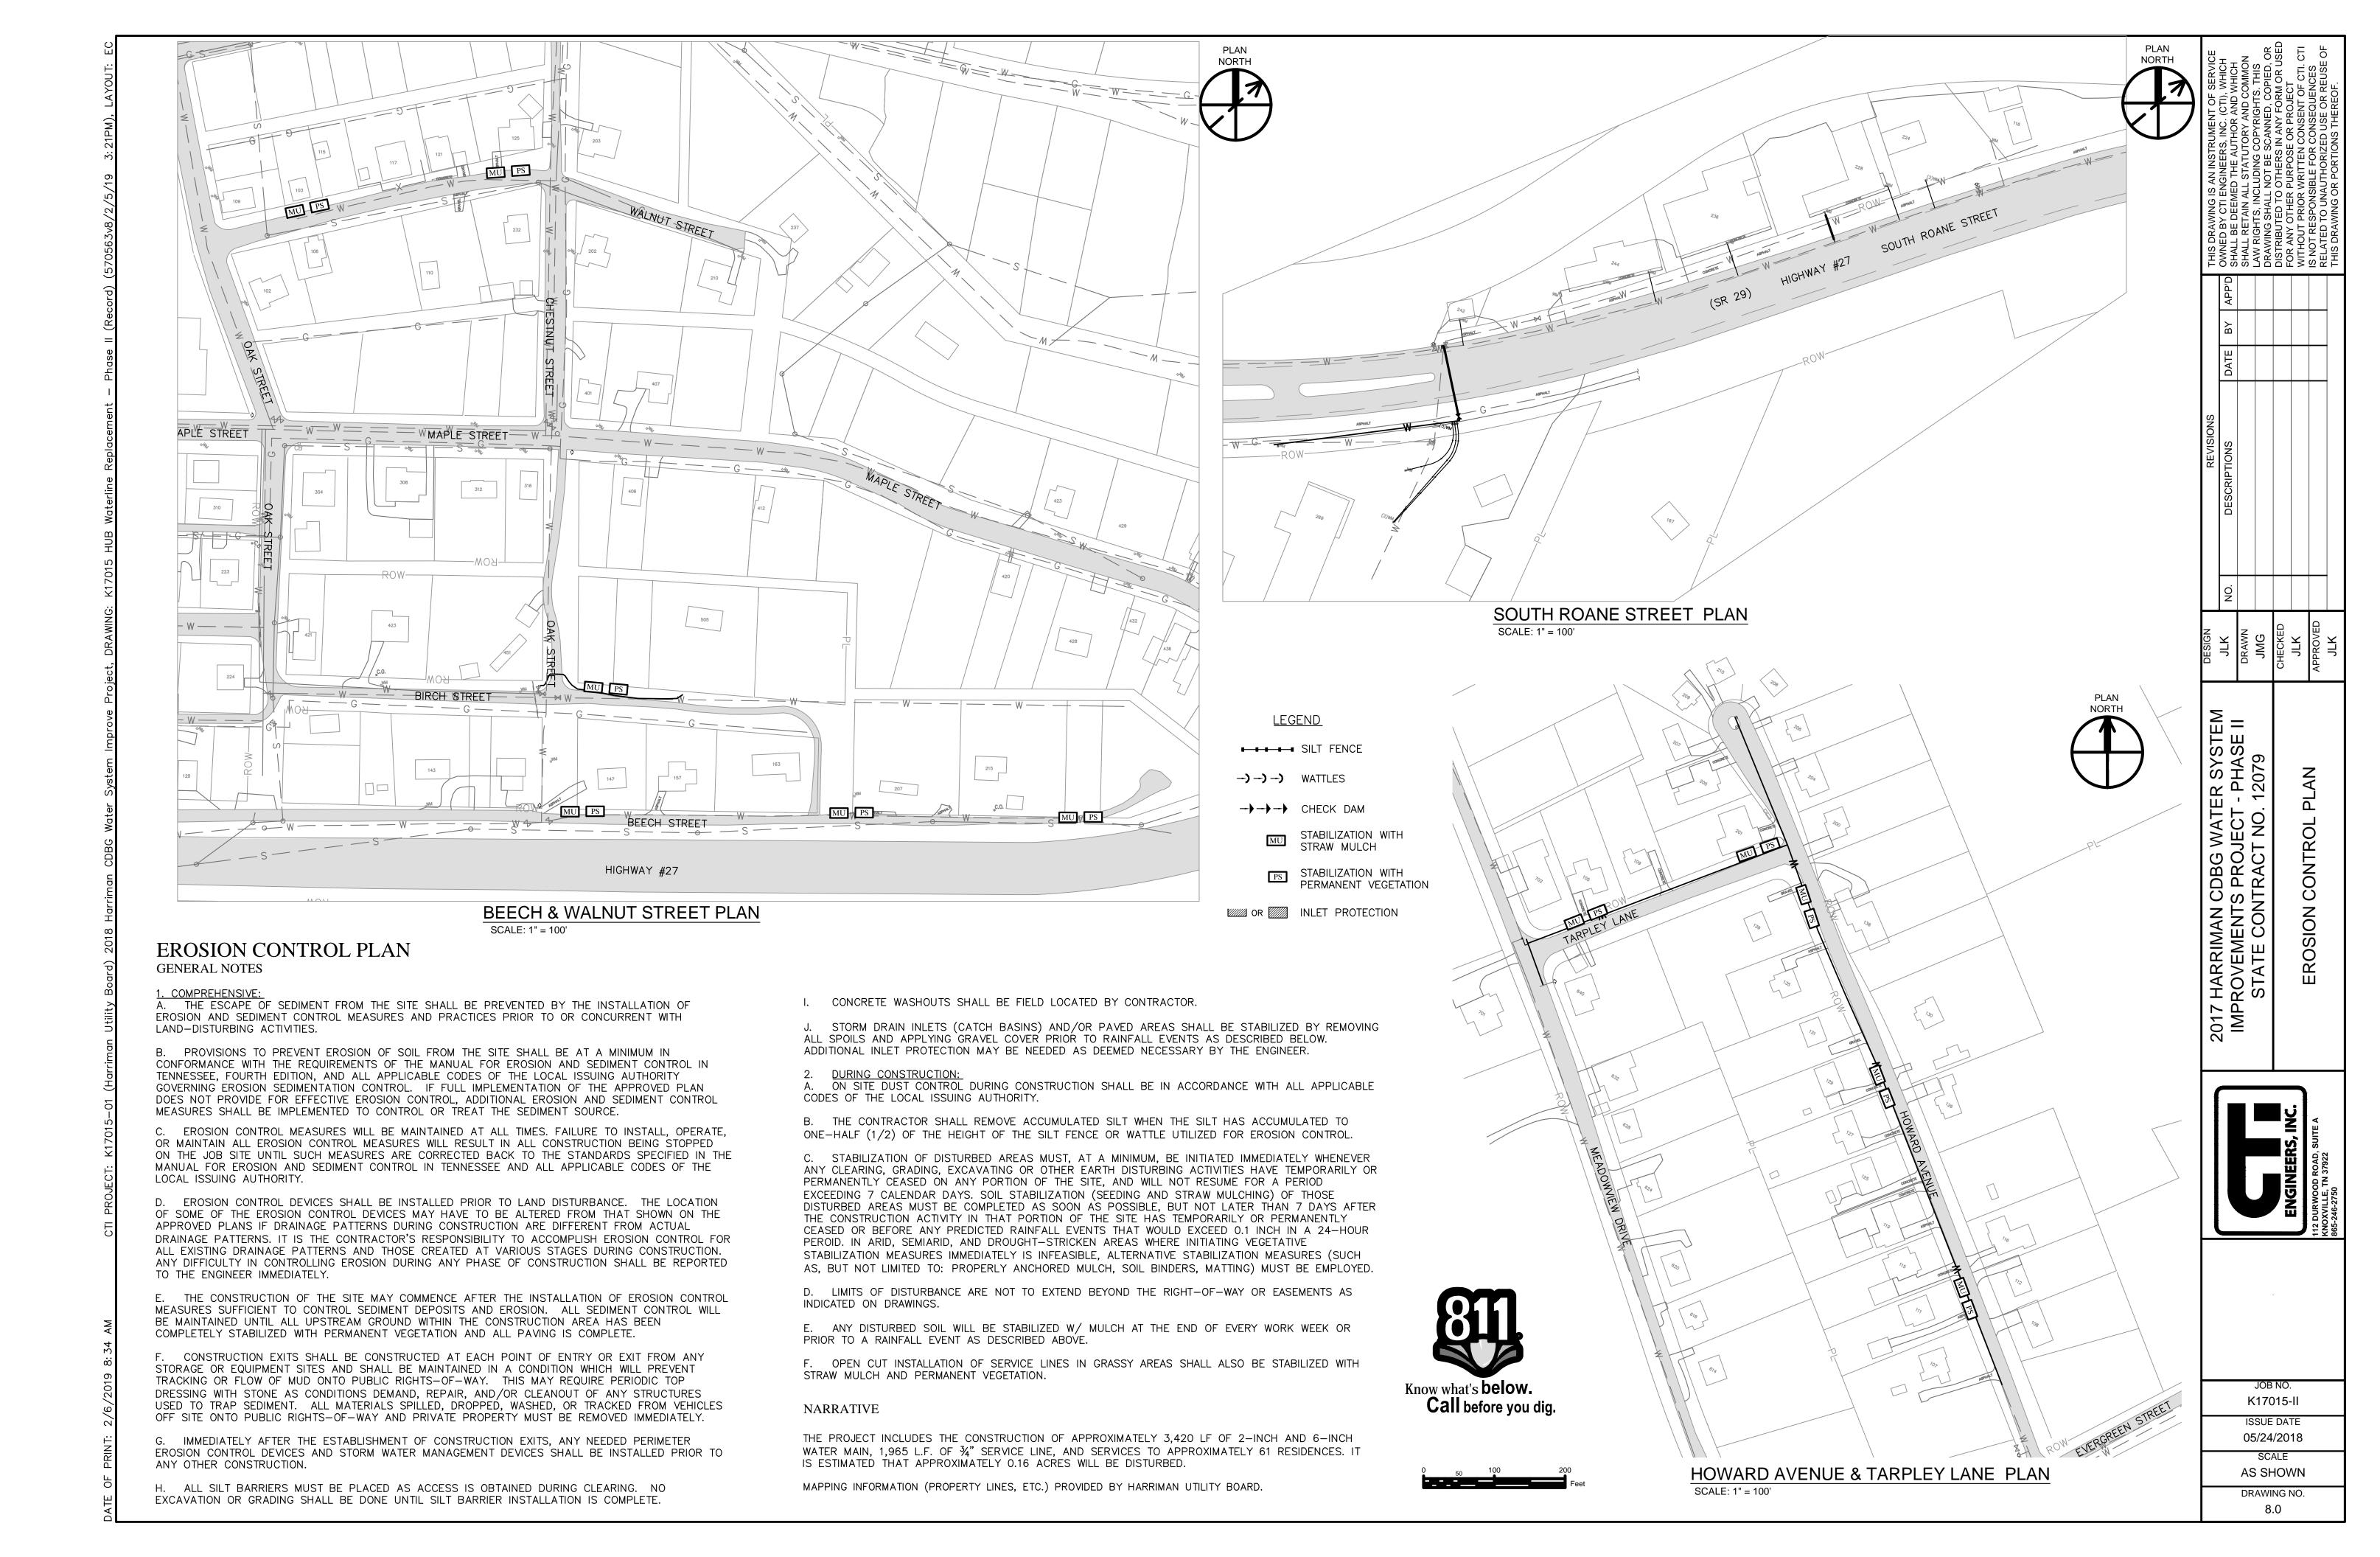

ELEVATION VIEW

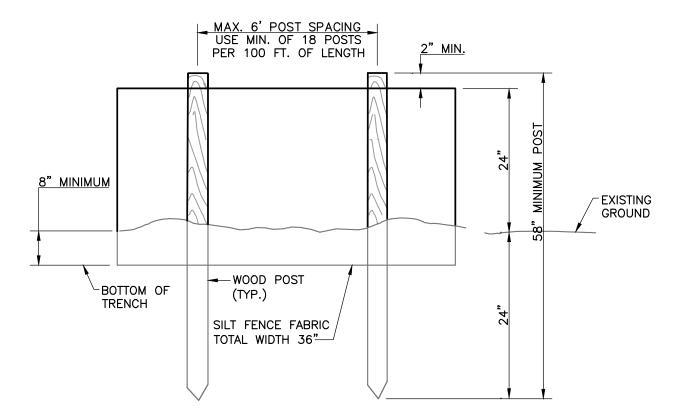

<u>LEGEND</u> SILT FENCE

			RATE (LB/ACRE)		
AREA	SOWING SEASON	SPECIES	SEED	FERTILIZER (10-10-10)	LIMESTONE
ALL	MAY 1 – AUG. 15	OATS BROWN TOP MILLET	60 30	750	2,000*
ALL	AUG. 15 – DEC. 30	OATS WINTER WHEAT	30 30	750	


NOTES: 1. APPLY 4,000 LB/ACRE STRAW. ANCHOR STRAW BY TACKING WITH ASPHALT, NETTING, OR A MULCH REFERTILIZE IF GROWTH IS NOT FULLY ADEQUATE. RESEED, REFERTILIZE AND MULCH IMMEDIATELY FOLLOWING EROSION OR OTHER DAMAGE.

			RATE (LB/ACRE)		
AREA	SOWING SEASON	SPECIES	SEED	FERTILIZER (6-12-12)	LIMESTONE
FLAT TO ROLLING	MAR. 1 – JUNE 1	KENTUCKY 31 FESCUE LADINO WHITE CLOVER*	200-400 10-20	1,350 [™]	4,300**
TERRAIN WITH SLOPES LESS THAN 3:1	AUG. 1 – NOV. 1	KENTUCKY 31 FESCUE LADINO WHITE CLOVER* ANNUAL RYEGRASS	200-400 10-20 100-160		
EMBANKMENTS WITH SLOPES GREATER THAN 3:1	MAR. 1 – JUNE 1	KENTUCKY 31 FESCUE WEEPING LOVEGRASS	140 15		
	AUG. 1 – NOV. 1	KENTUCKY 31 FESCUE ANNUAL RYEGRASS	140 90		


** OR FOLLOW RECOMMENDATIONS OF SOIL TEST(S). NOTES: 1. APPLY 4,000 LB/ACRE STRAW. ANCHOR STRAW BY TACKING WITH ASPHALT, NETTING, OR A MULCH


2. REFERTILIZE IF GROWTH IS NOT FULLY ADEQUATE. RESEED, REFERTILIZE AND MULCH IMMEDIATELY


FOLLOWING EROSION OR OTHER DAMAGE.

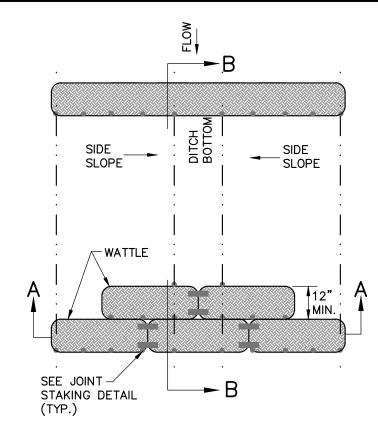

PLAN VIEW FOR DITCH APPLICATION

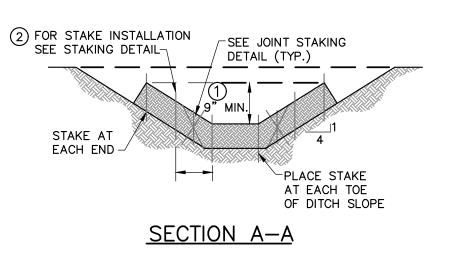


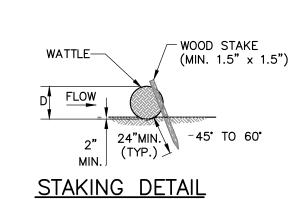

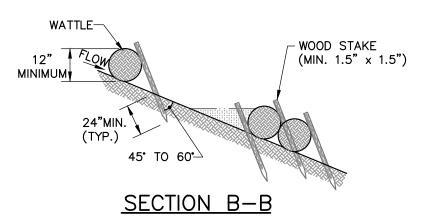


NOTES:

- 1) THE DEPTH AND WIDTH OF THE WEIR SECTION OF THE WATTLE SHALL BE DESIGNED TO PASS THE 2yr/24hr OR 5yr/24hr STORM EVENT WITHOUT OVERTOPPING THE CHANNEL.
- 2) STAKE PER MANUFACTURERS RECOMMENDATIONS

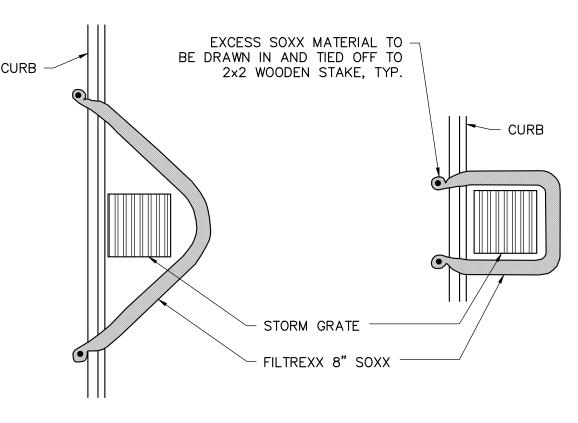


WATTLES

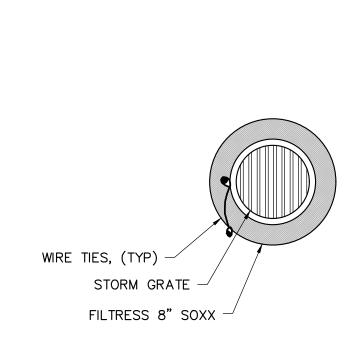

DRAIN INLET PLAN

CURBSIDE OPTION "A" PLAN

CURBSIDE OPTION "B" PLAN

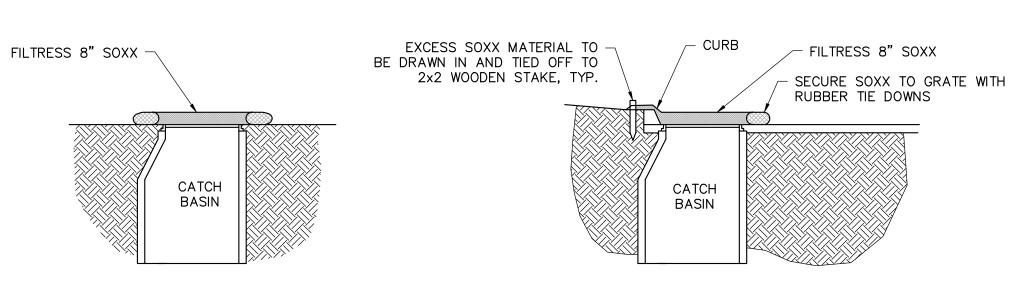

DRAIN INLET SECTION

CURBSIDE SECTION

NOTES:

1. ALL MATERIAL TO MEET FILTREXX SPECIFICATIONS.

2. FILTER MEDIA FILL TO MEET APPLICATION REQUIREMENTS. 3. COMPOST MATERIAL TO BE DISPERSED ON SITE, AS DETERMINED BY ENGINEER.







SYSTEM PHASE II WATER SYS JECT - PHAS T NO. 12079 DBG PRO RAC HARRIMAN CE PROVEMENTS F STATE CONTR 2017 IMPF K17015-II ISSUE DATE 05/24/2018 AS SHOWN DRAWING NO. 9.0