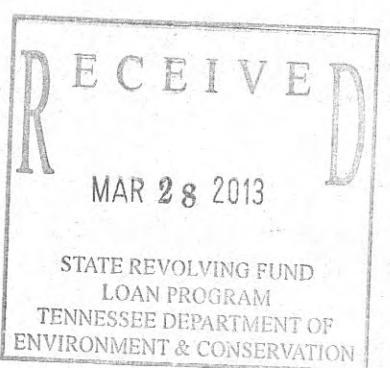


SEWER REHABILITATION CARDIFF, McDONALD AND LADD PUMP STATIONS FOR HARRIMAN UTILITY BOARD

ROANE COUNTY
HARRIMAN, TENNESSEE

CONTRACT NO. S12-01




PC13-0161

CG 02011-269

PRINTED: 3/11/2013 @ 11:22:46 AM

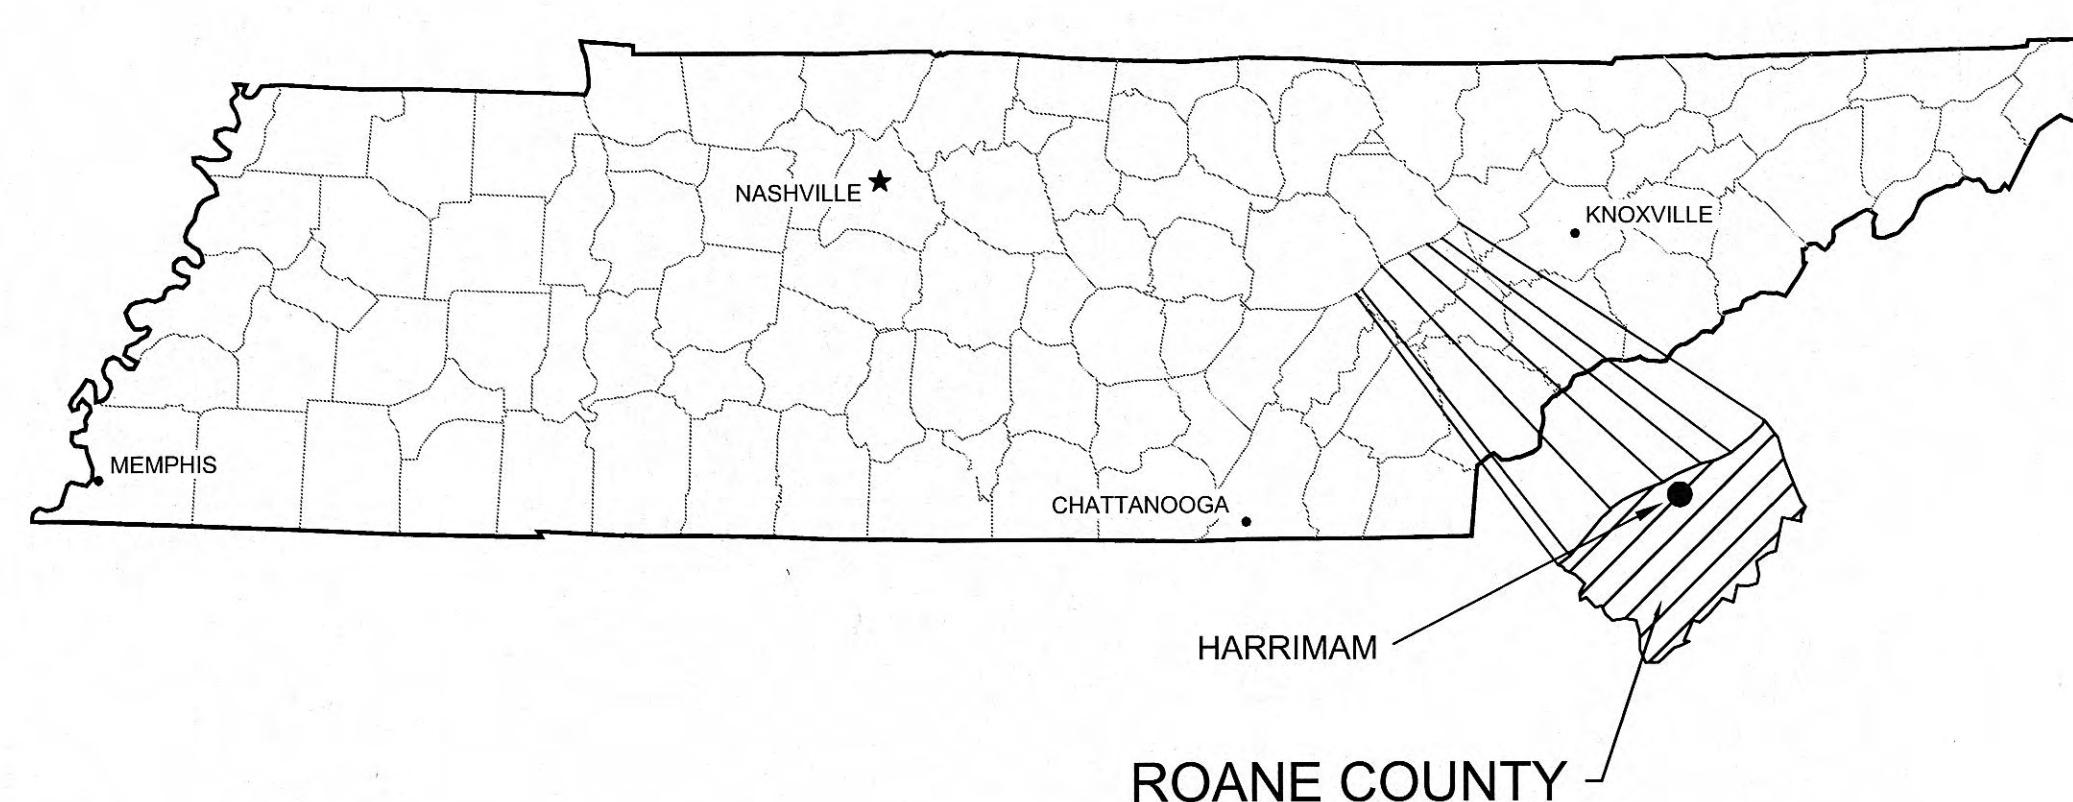FILE NAME: 113907-Harriman Utility 01-SRF Sewer Rehab Working Drawings\Design Drawings\Pump Station\3947-01-G-001.dwg



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www.grwinc.com




DECEMBER 2012

GRW PROJECT NO. 3947-01

DWG. No.	INDEX OF DRAWINGS
G-001	COVER SHEET
G-002	COUNTY MAP, LOCATION MAP AND GENERAL NOTES
G-003	STANDARD GRAVITY SEWER DETAILS
G-004	STANDARD PRESSURE PIPE DETAILS
G-005	STANDARD SITE DETAILS AND EROSION DETAILS
C-0-101	EXISTING CARDIFF PUMP STATION - DEMOLITION / NEW SITE PLAN, GRAVITY LINE PROFILE AND DETAILS
C-0-102	EXISTING McDONALD PUMP STATION - DEMOLITION / NEW SITE PLAN AND DETAILS
C-0-103	LADD PUMP STATION - EXISTING SITE PLAN LADD PUMP STATION - NEW SITE PLAN
C-1-101	NEW CARDIFF PUMP STATION - NEW EQUIPMENT, PLAN AND SECTIONS
C-1-102	NEW McDONALD PUMP STATION - NEW EQUIPMENT, PLAN AND SECTIONS
C-1-103	EXISTING LADD PUMP STATION - DEMOLITION PLAN AND SECTIONS
C-1-104	EXISTING LADD PUMP STATION - NEW EQUIPMENT, PLAN AND SECTIONS
A-0-001	GENERAL ARCHITECTURAL SHEET - NOTES AND SYMBOLS
A-1-101	EXISTING LADD PUMP STATION - DEMOLITION AND UPGRADE FLOOR PLANS I
A-1-102	EXISTING LADD PUMP STATION - DEMOLITION AND UPGRADE FLOOR PLANS II
A-1-201	EXISTING LADD PUMP STATION - DEMOLITION ELEVATIONS & SECTIONS
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A-1-301	EXISTING LADD PUMP STATION - DEMOLITION AND UPGRADE FLOOR PLANS
A-1-601	SCHEDULES
E-1	CARDIFF PUMP STATION SITE PLAN - ELECTRICAL
E-2	MCDONALD PUMP STATION SITE PLAN - ELECTRICAL
E-3	LADD PUMP STATION SITE PLAN - ELECTRICAL
E-4	LADD PUMP STATION FLOOR PLANS - ELECTRICAL
E-5	CARDIFF AND LADD PUMP STATION CONTROL DIAGRAMS
E-6	LEGEND SCHEDULES AND DETAILS
M-1	LADD PUMP STATION SECTIONS & SCHEDULES - HVAC
M-2	LADD PUMP STATION FLOOR PLANS - HVAC

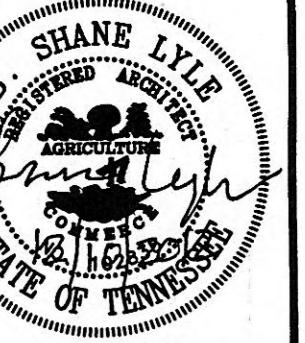SRF
Sewer
(PS Rehab)
TDEC-Approved
Set



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SCHEDULES
PUMP STATION REHABILITATION
CITY OF HARRIMAN, TENNESSEE

REVISIONS	DESIGNED	DATE	BY
001	TMCH		DRAWN
	TMCH		REVIEWED
	BSL		APPROVED
	BSL		

DATE:
DECEMBER 2012
SCALE:
1/4" = 1'-0"
SHEET NO.

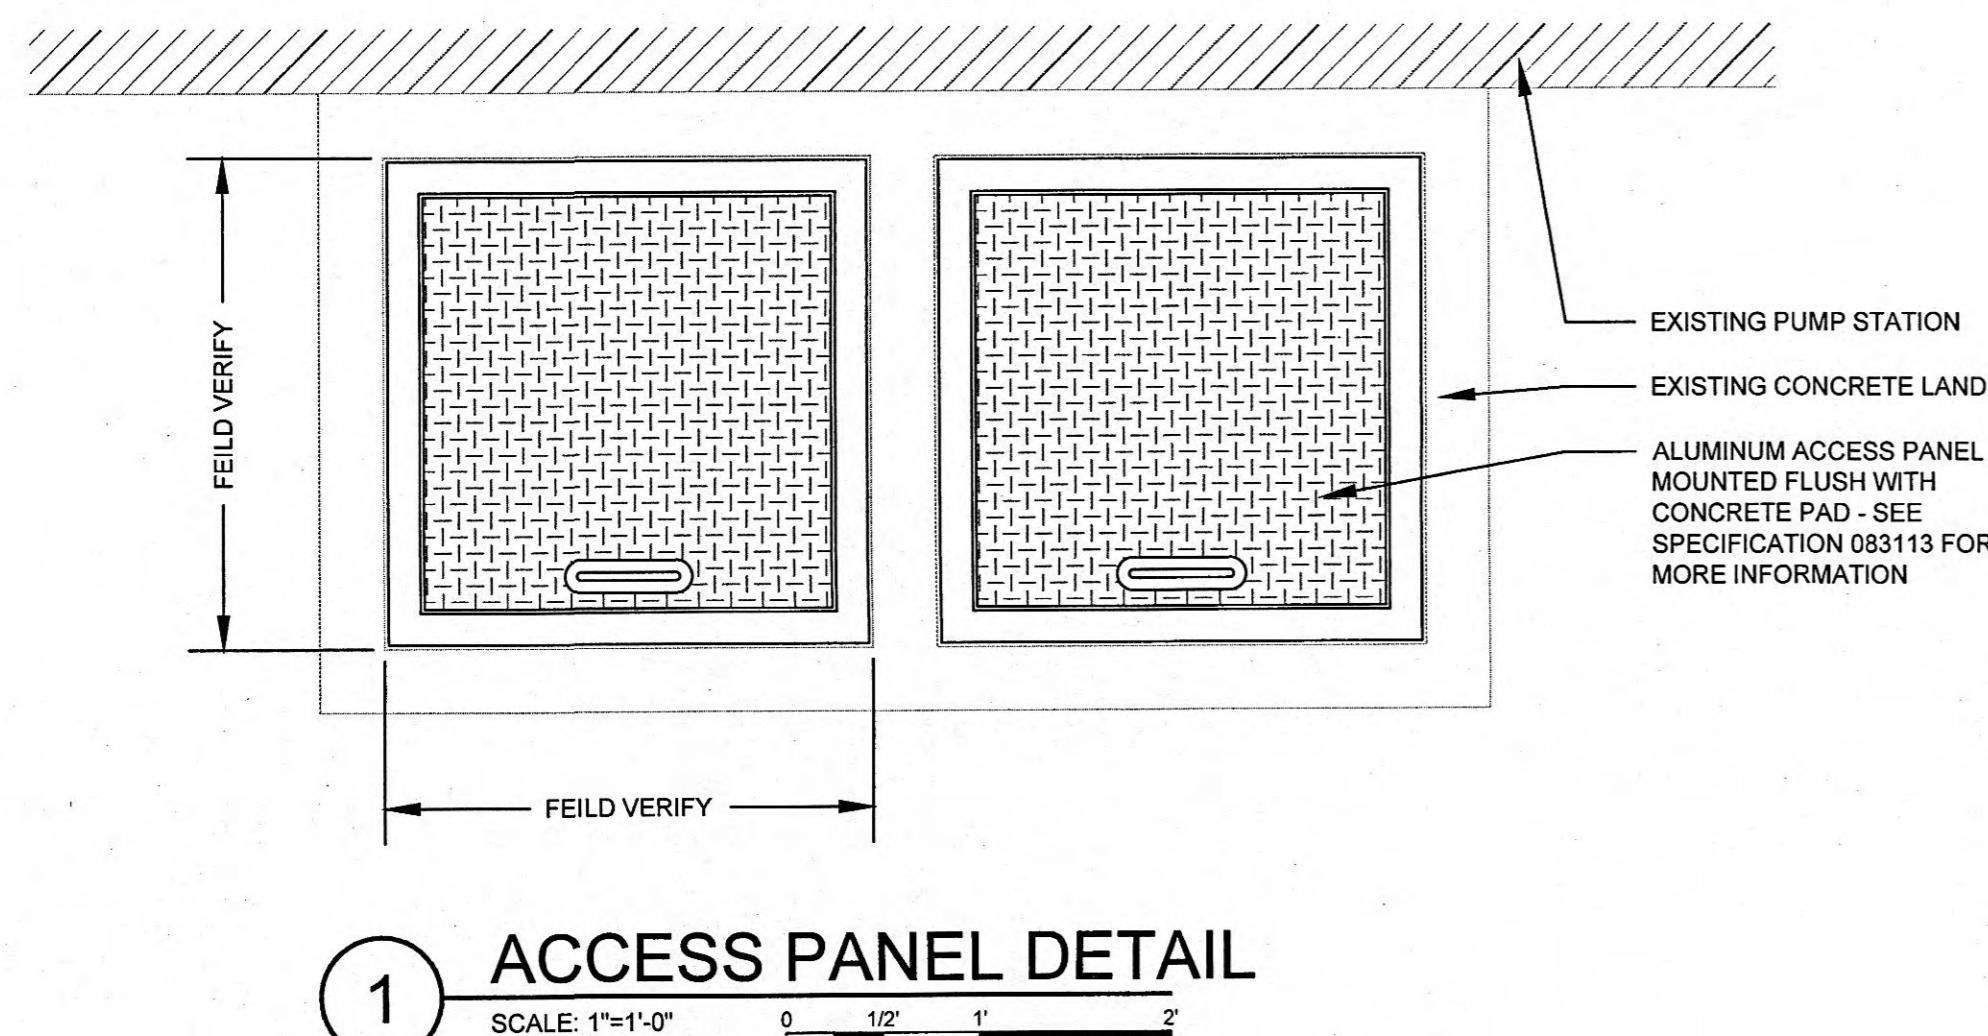
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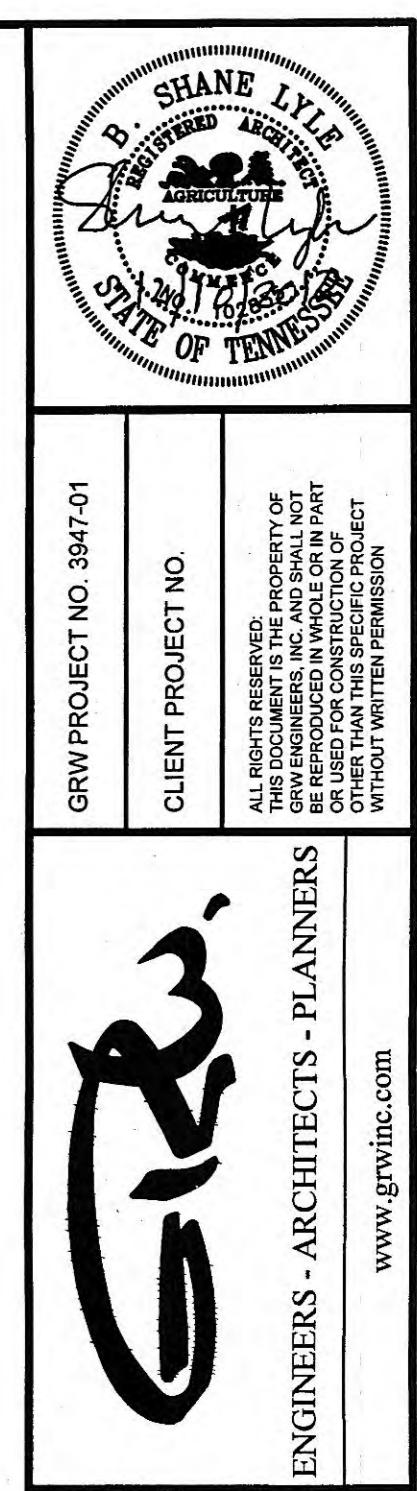
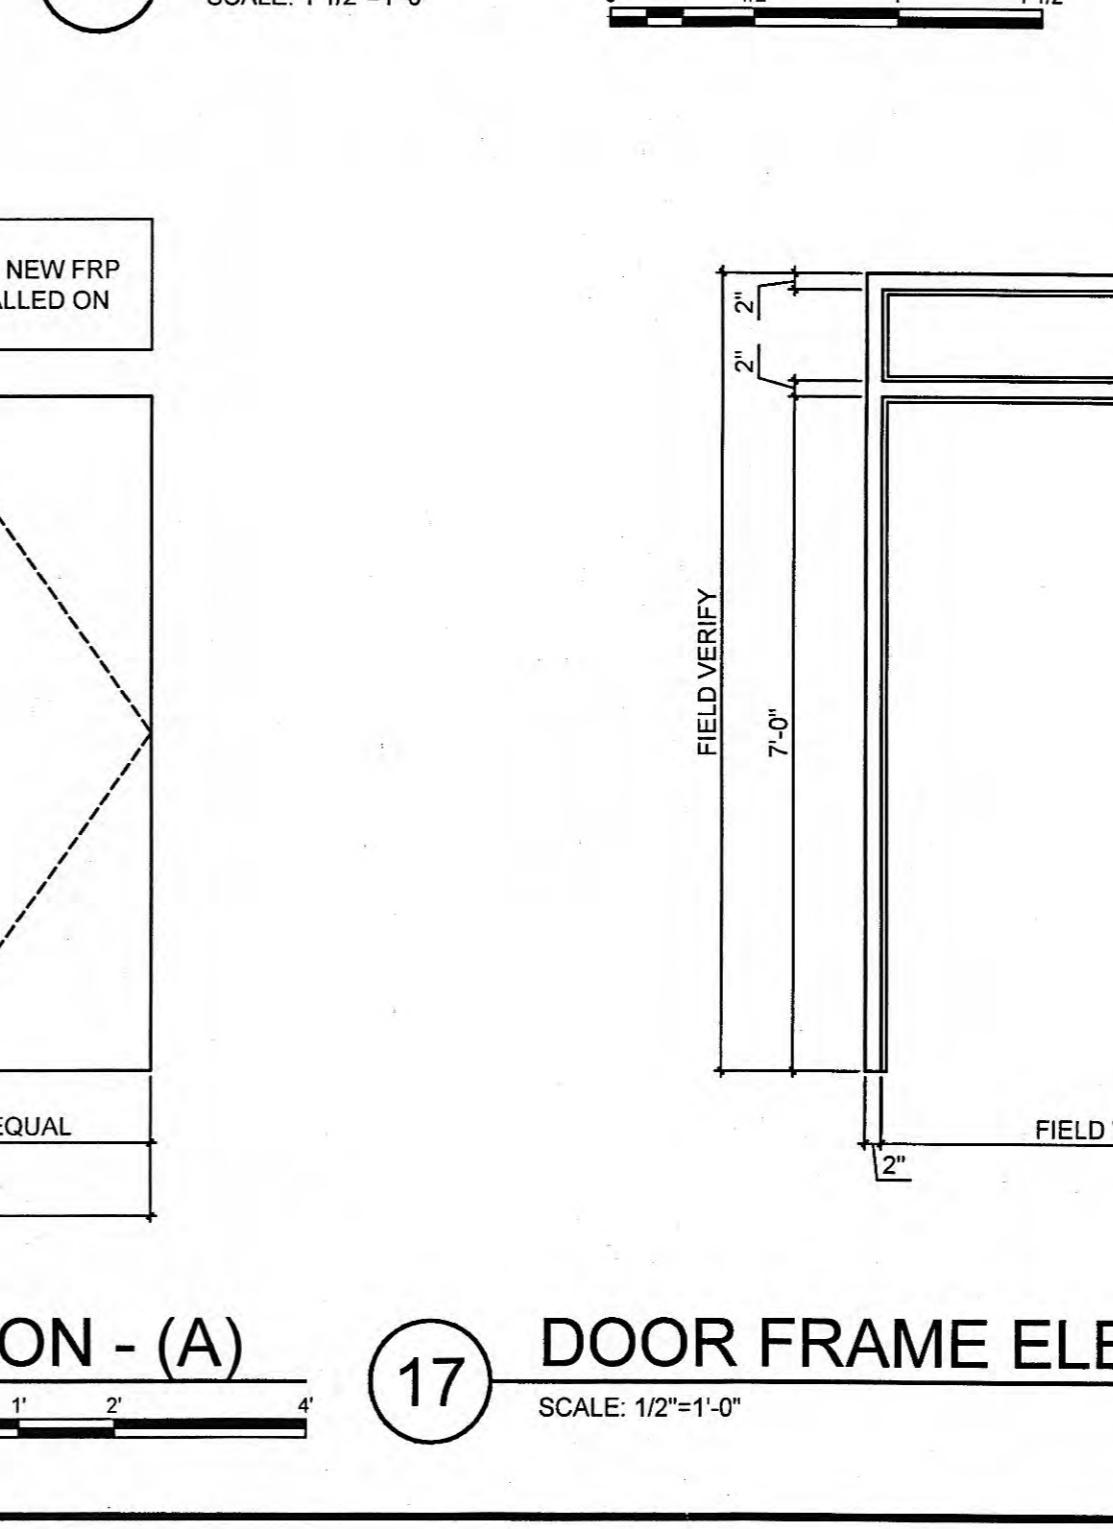
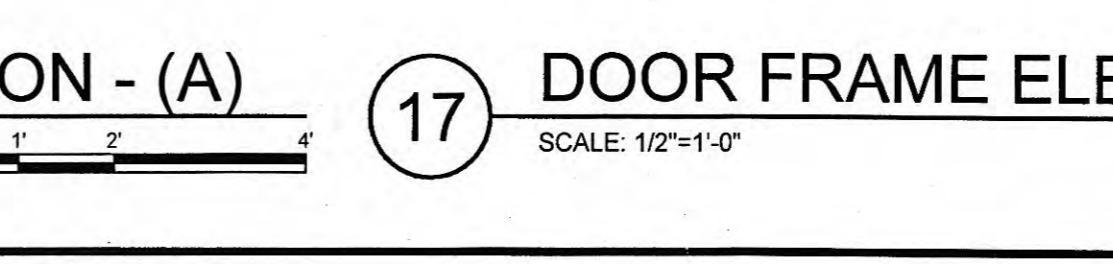
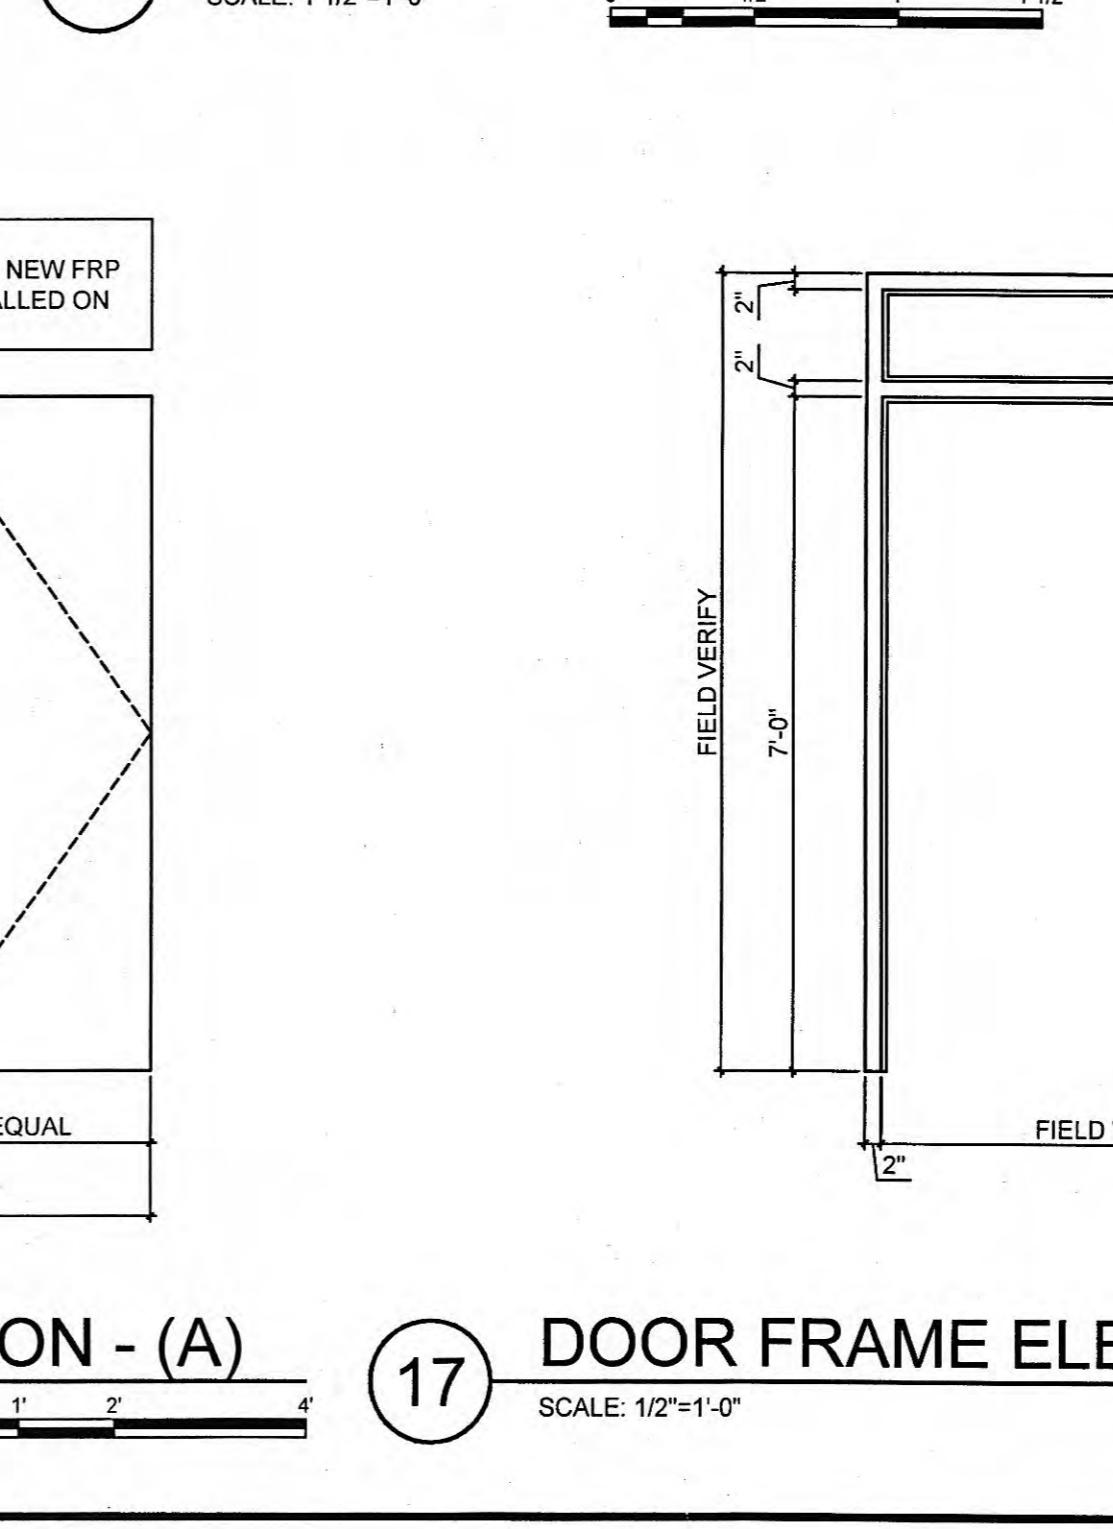
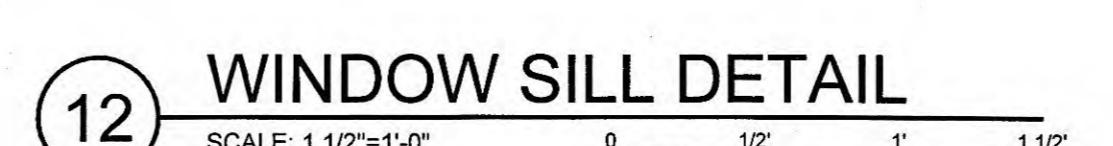
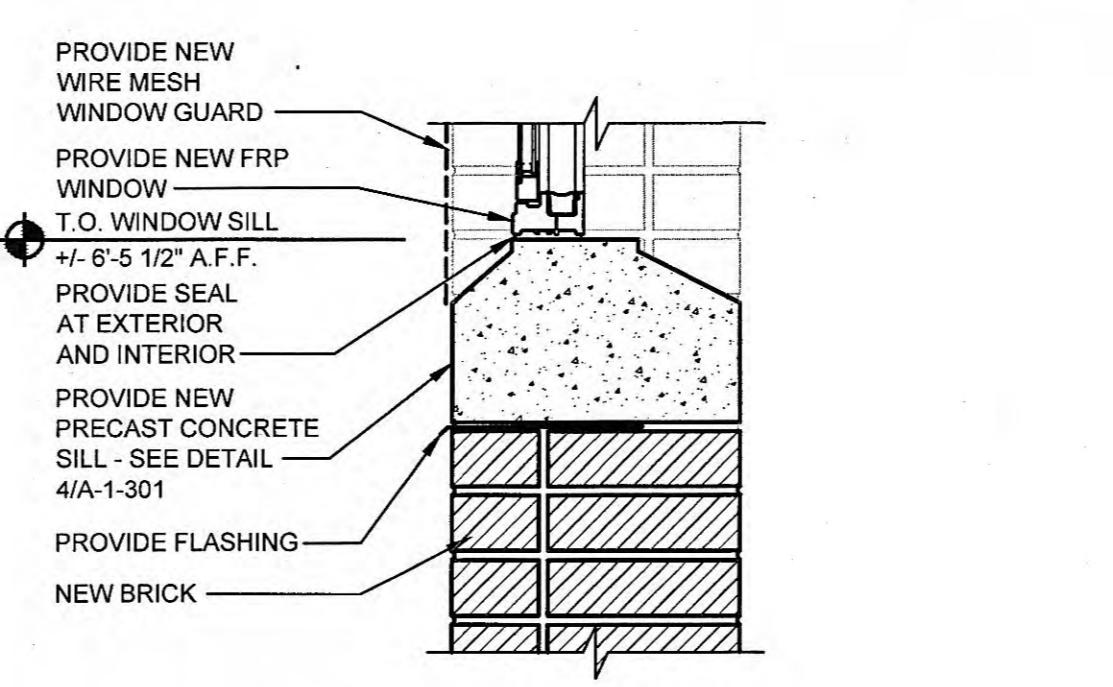
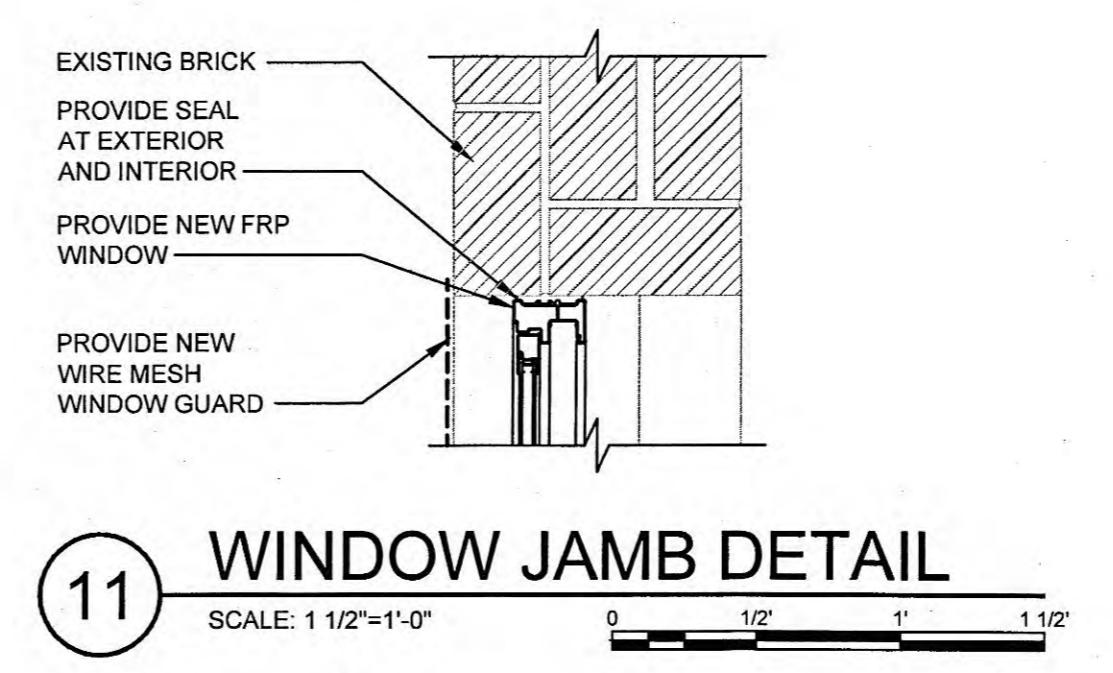
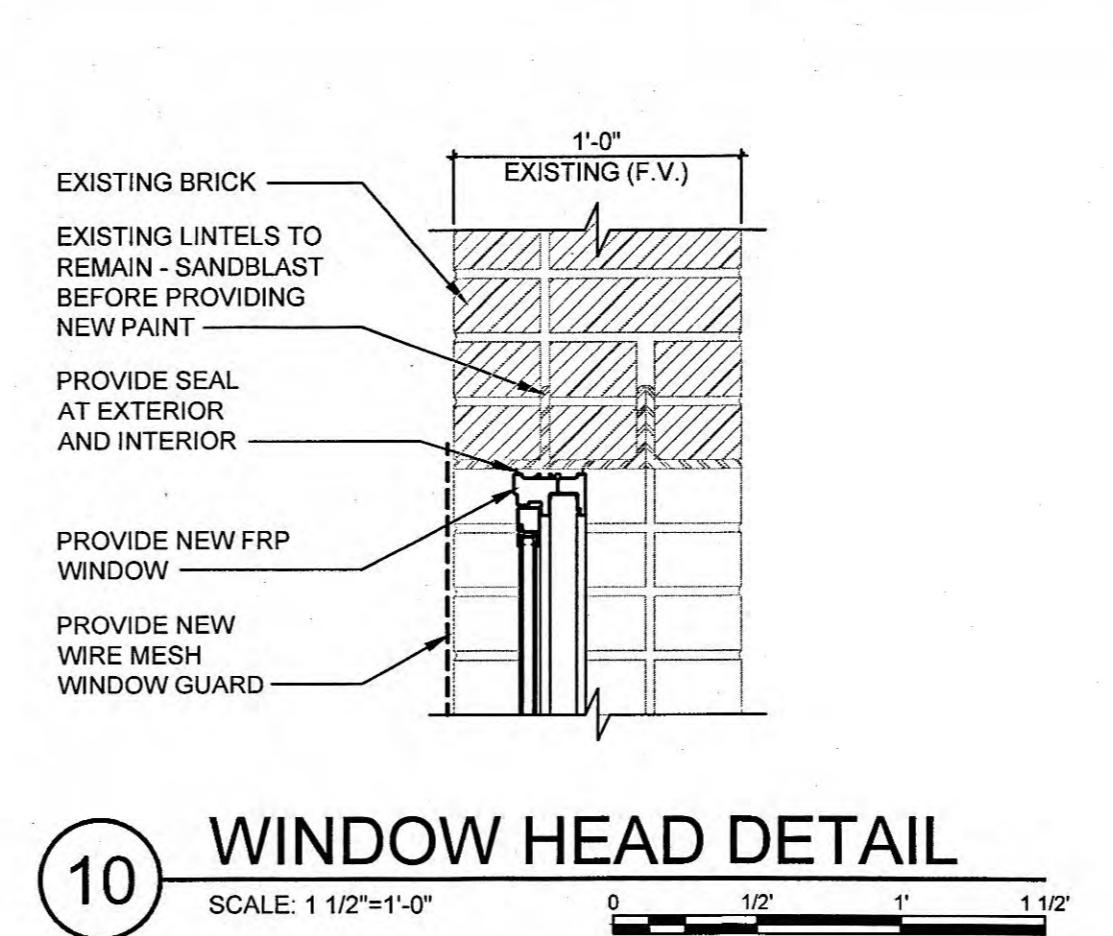
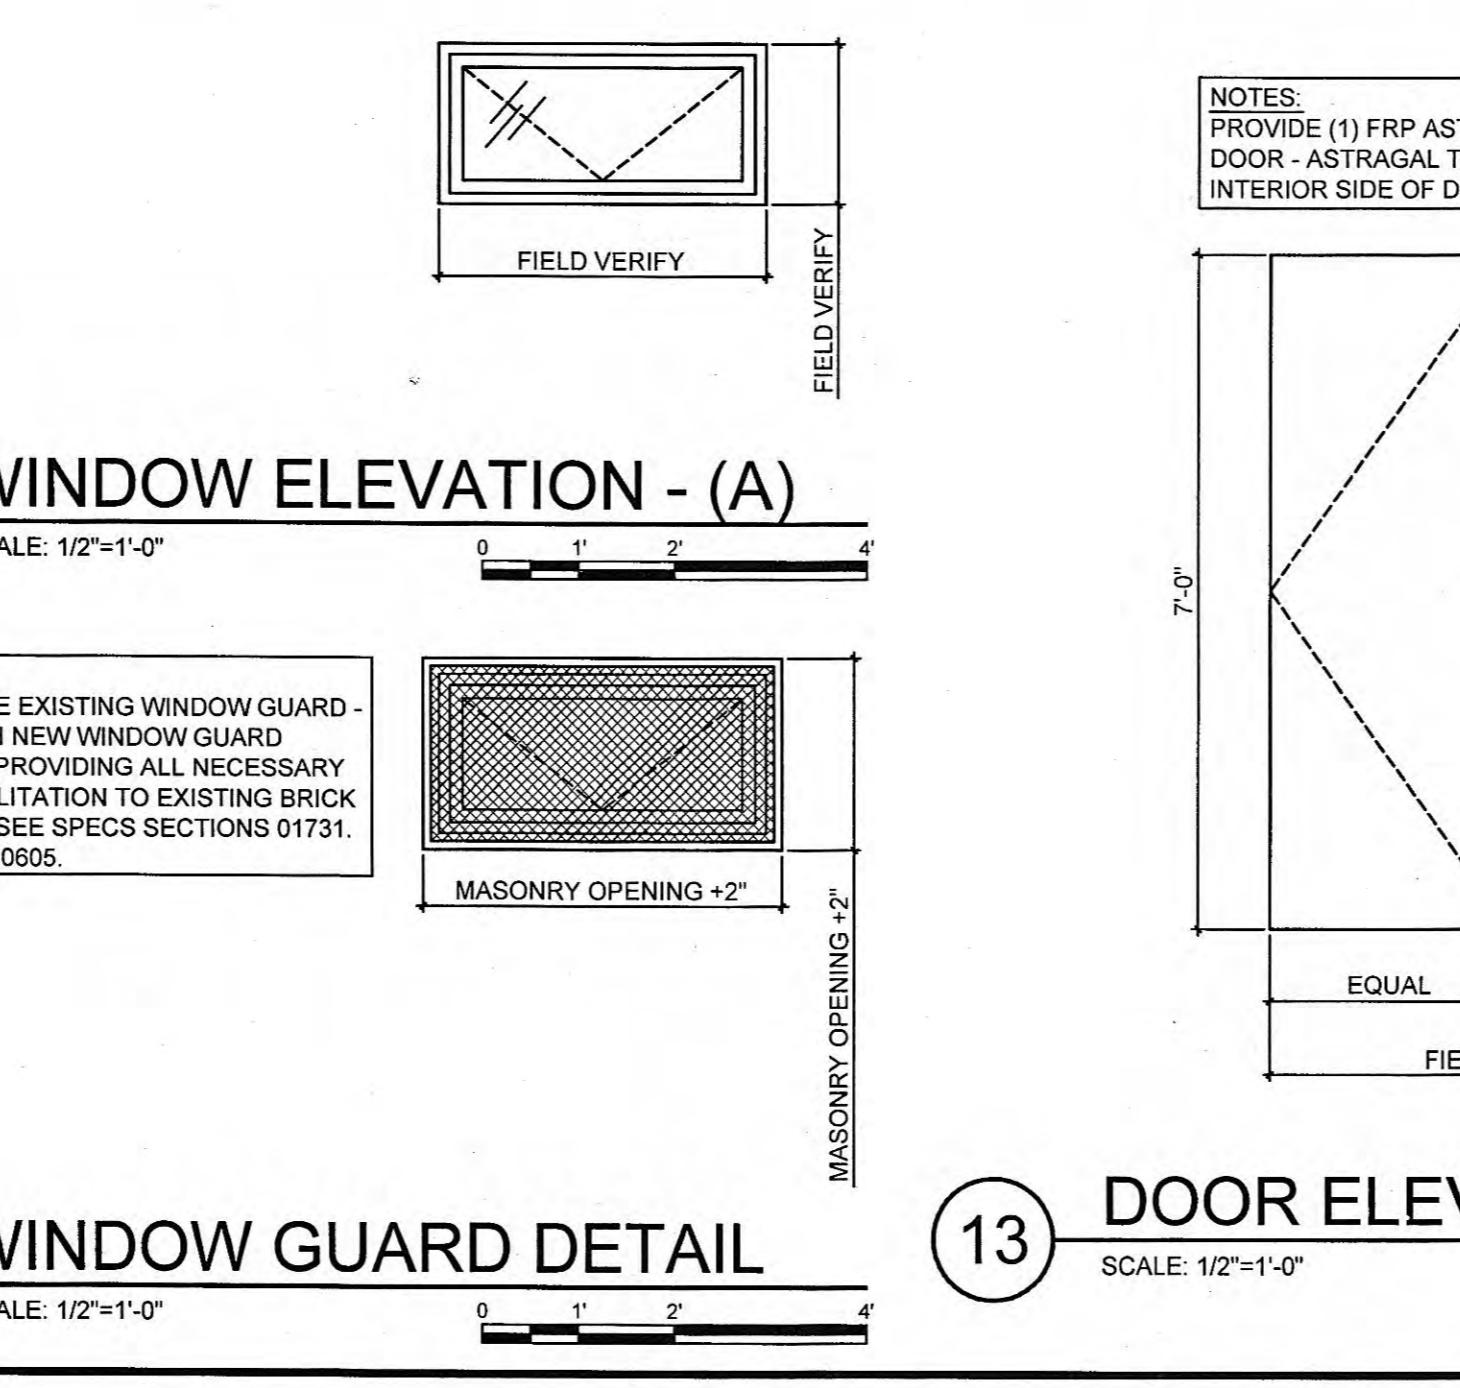
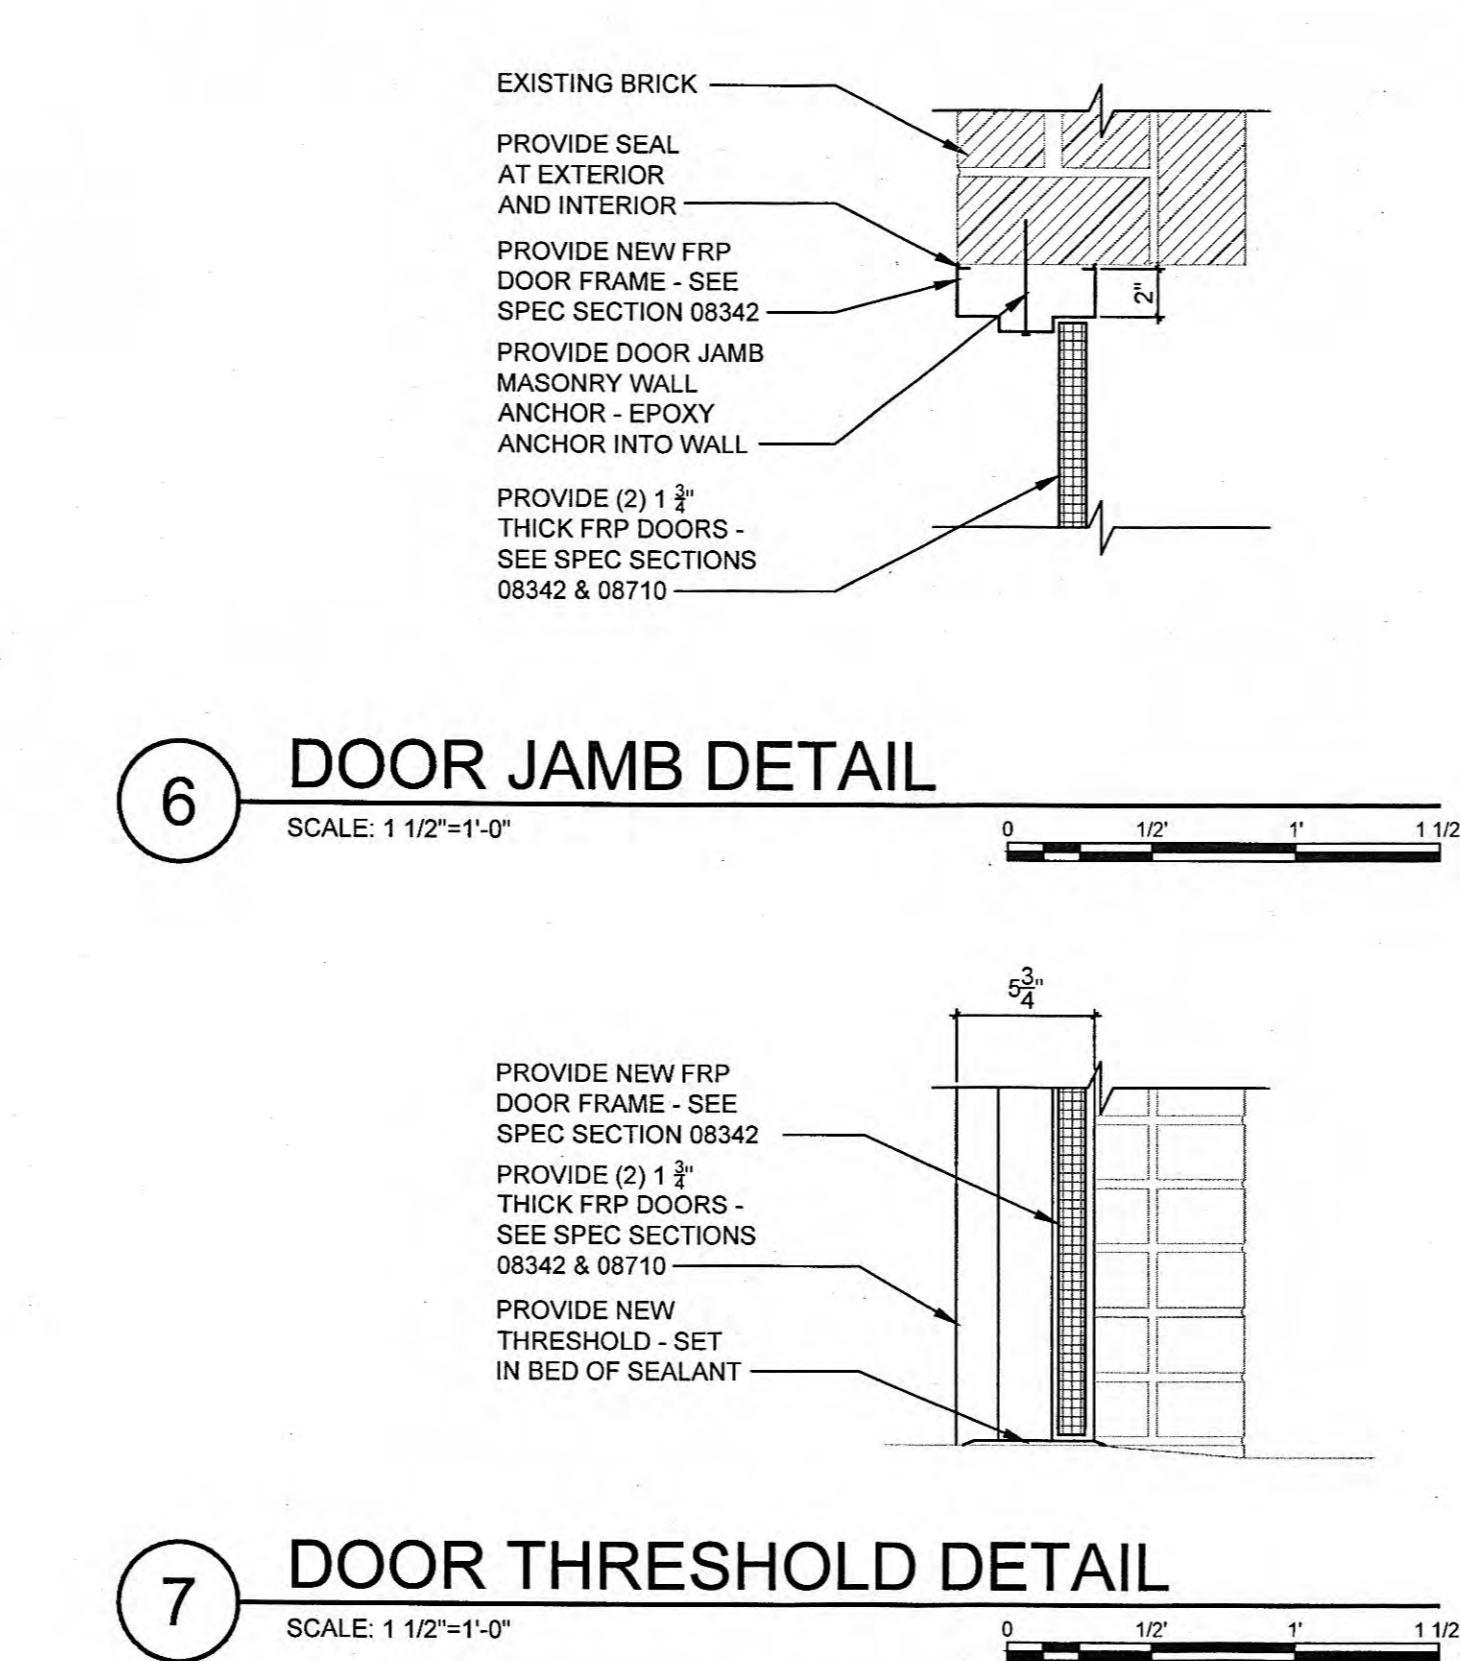
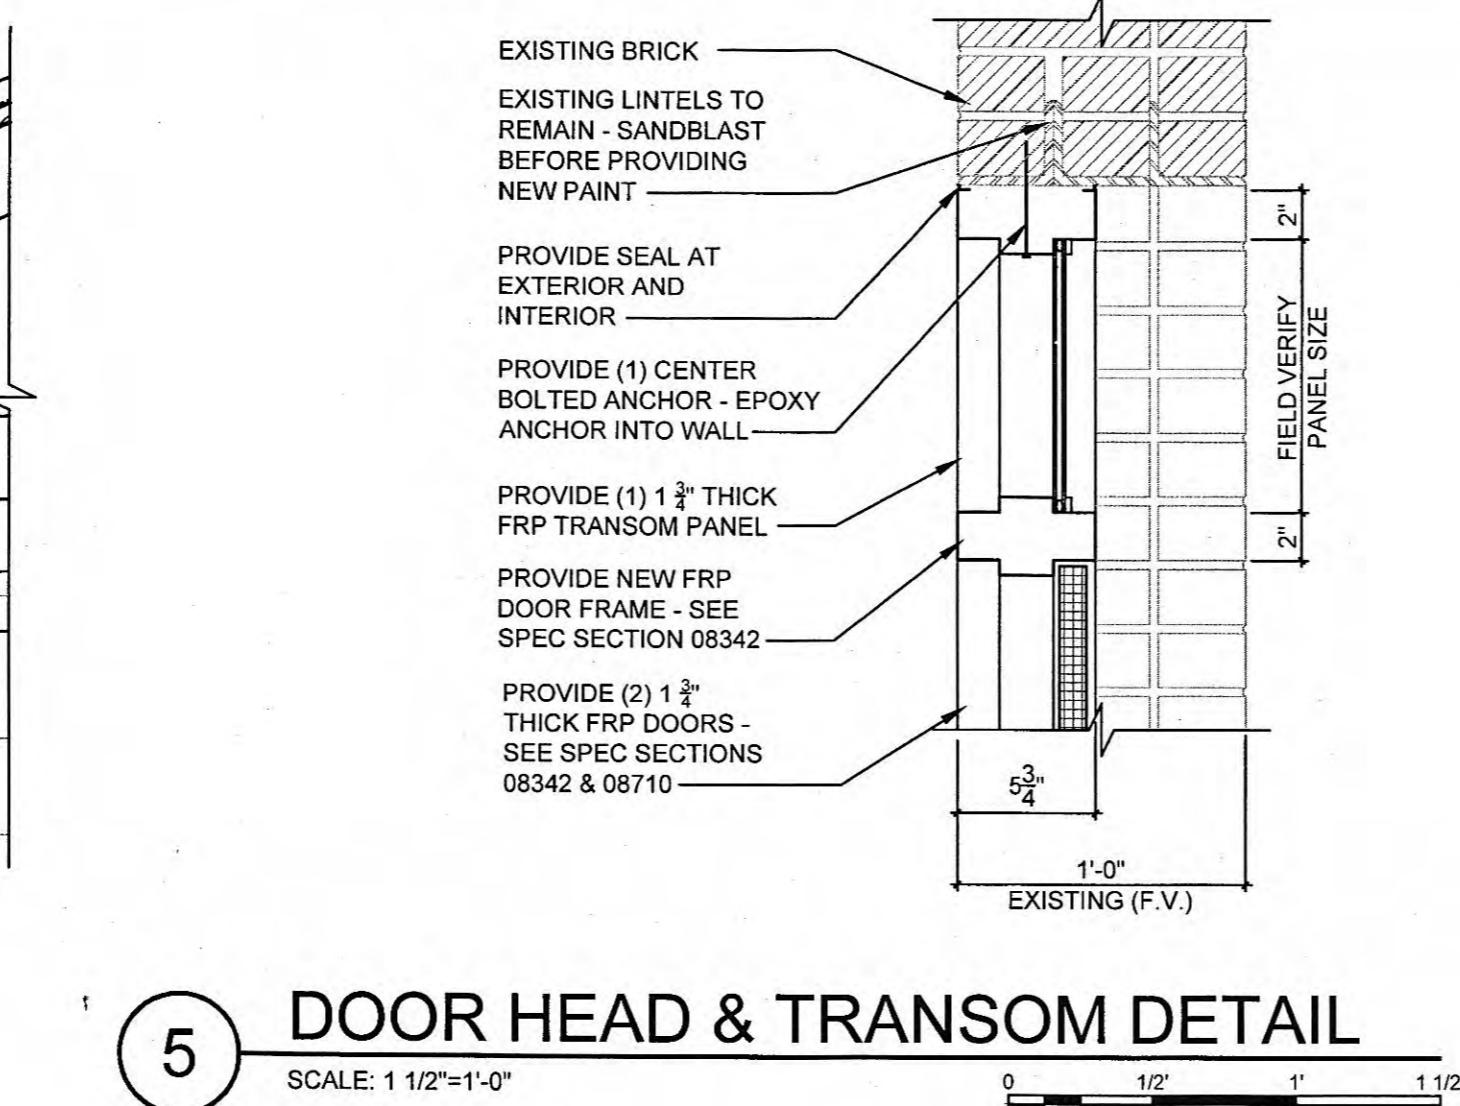
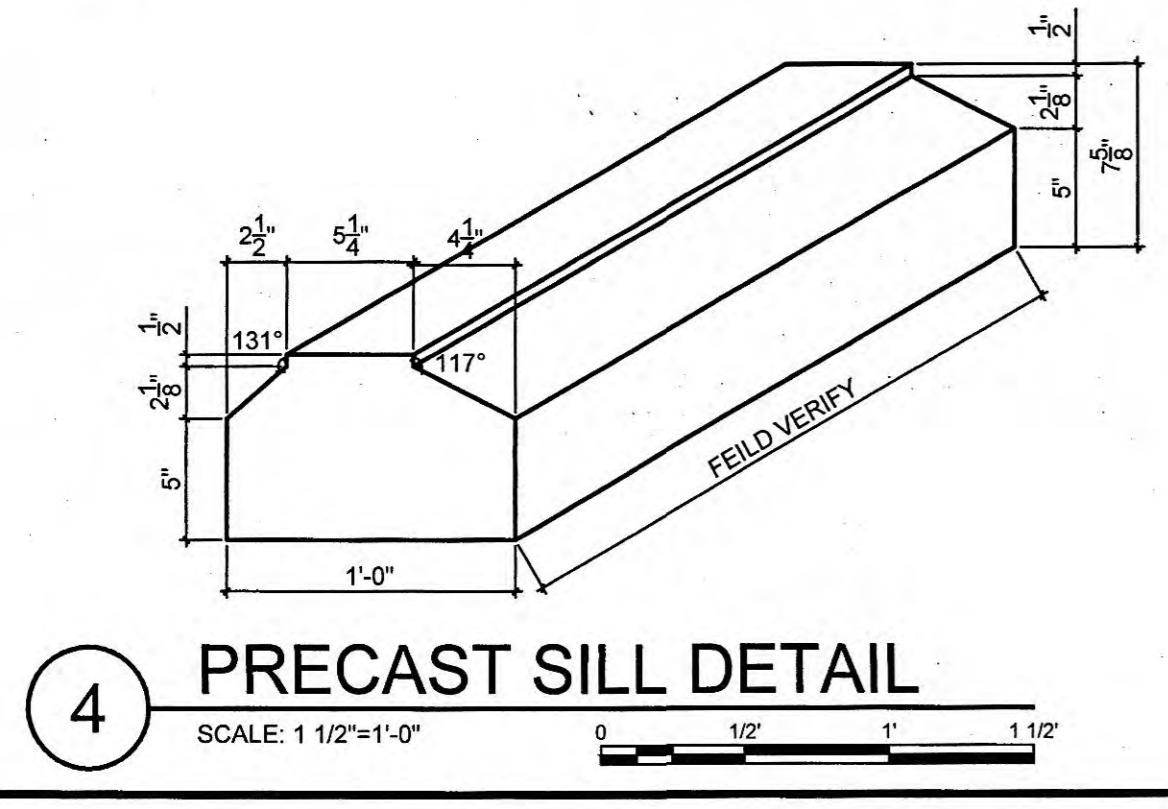
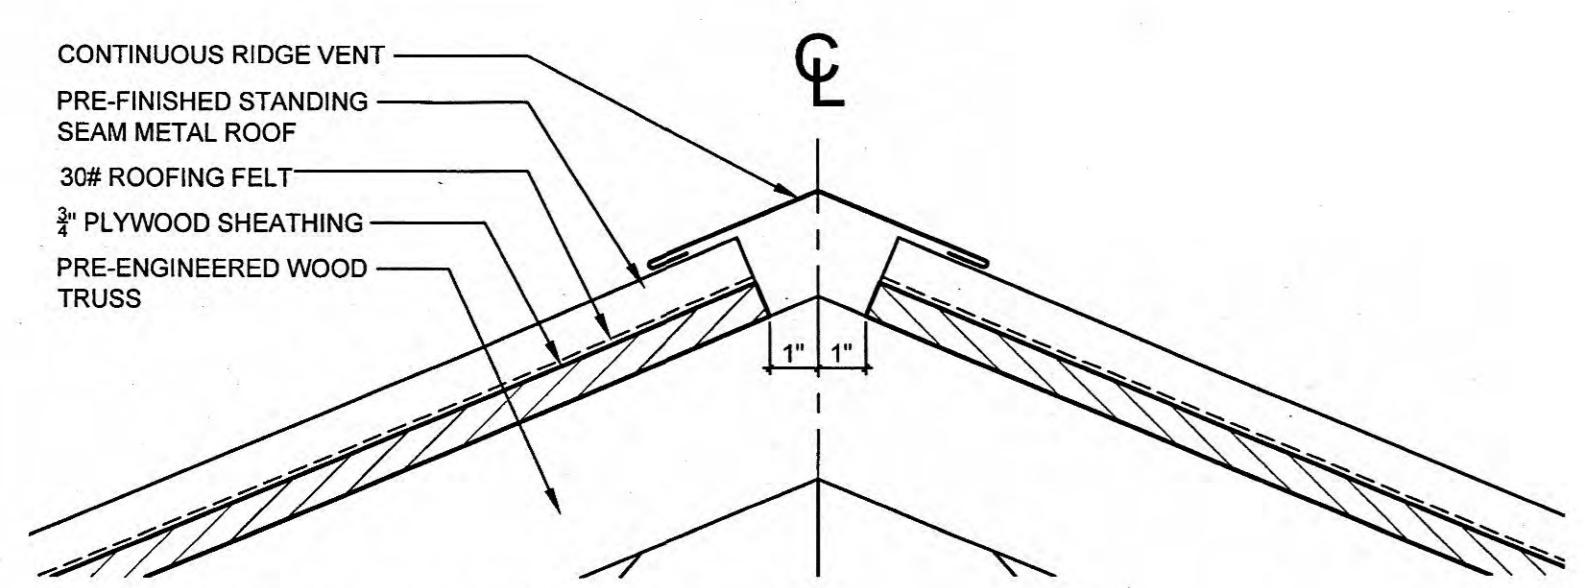
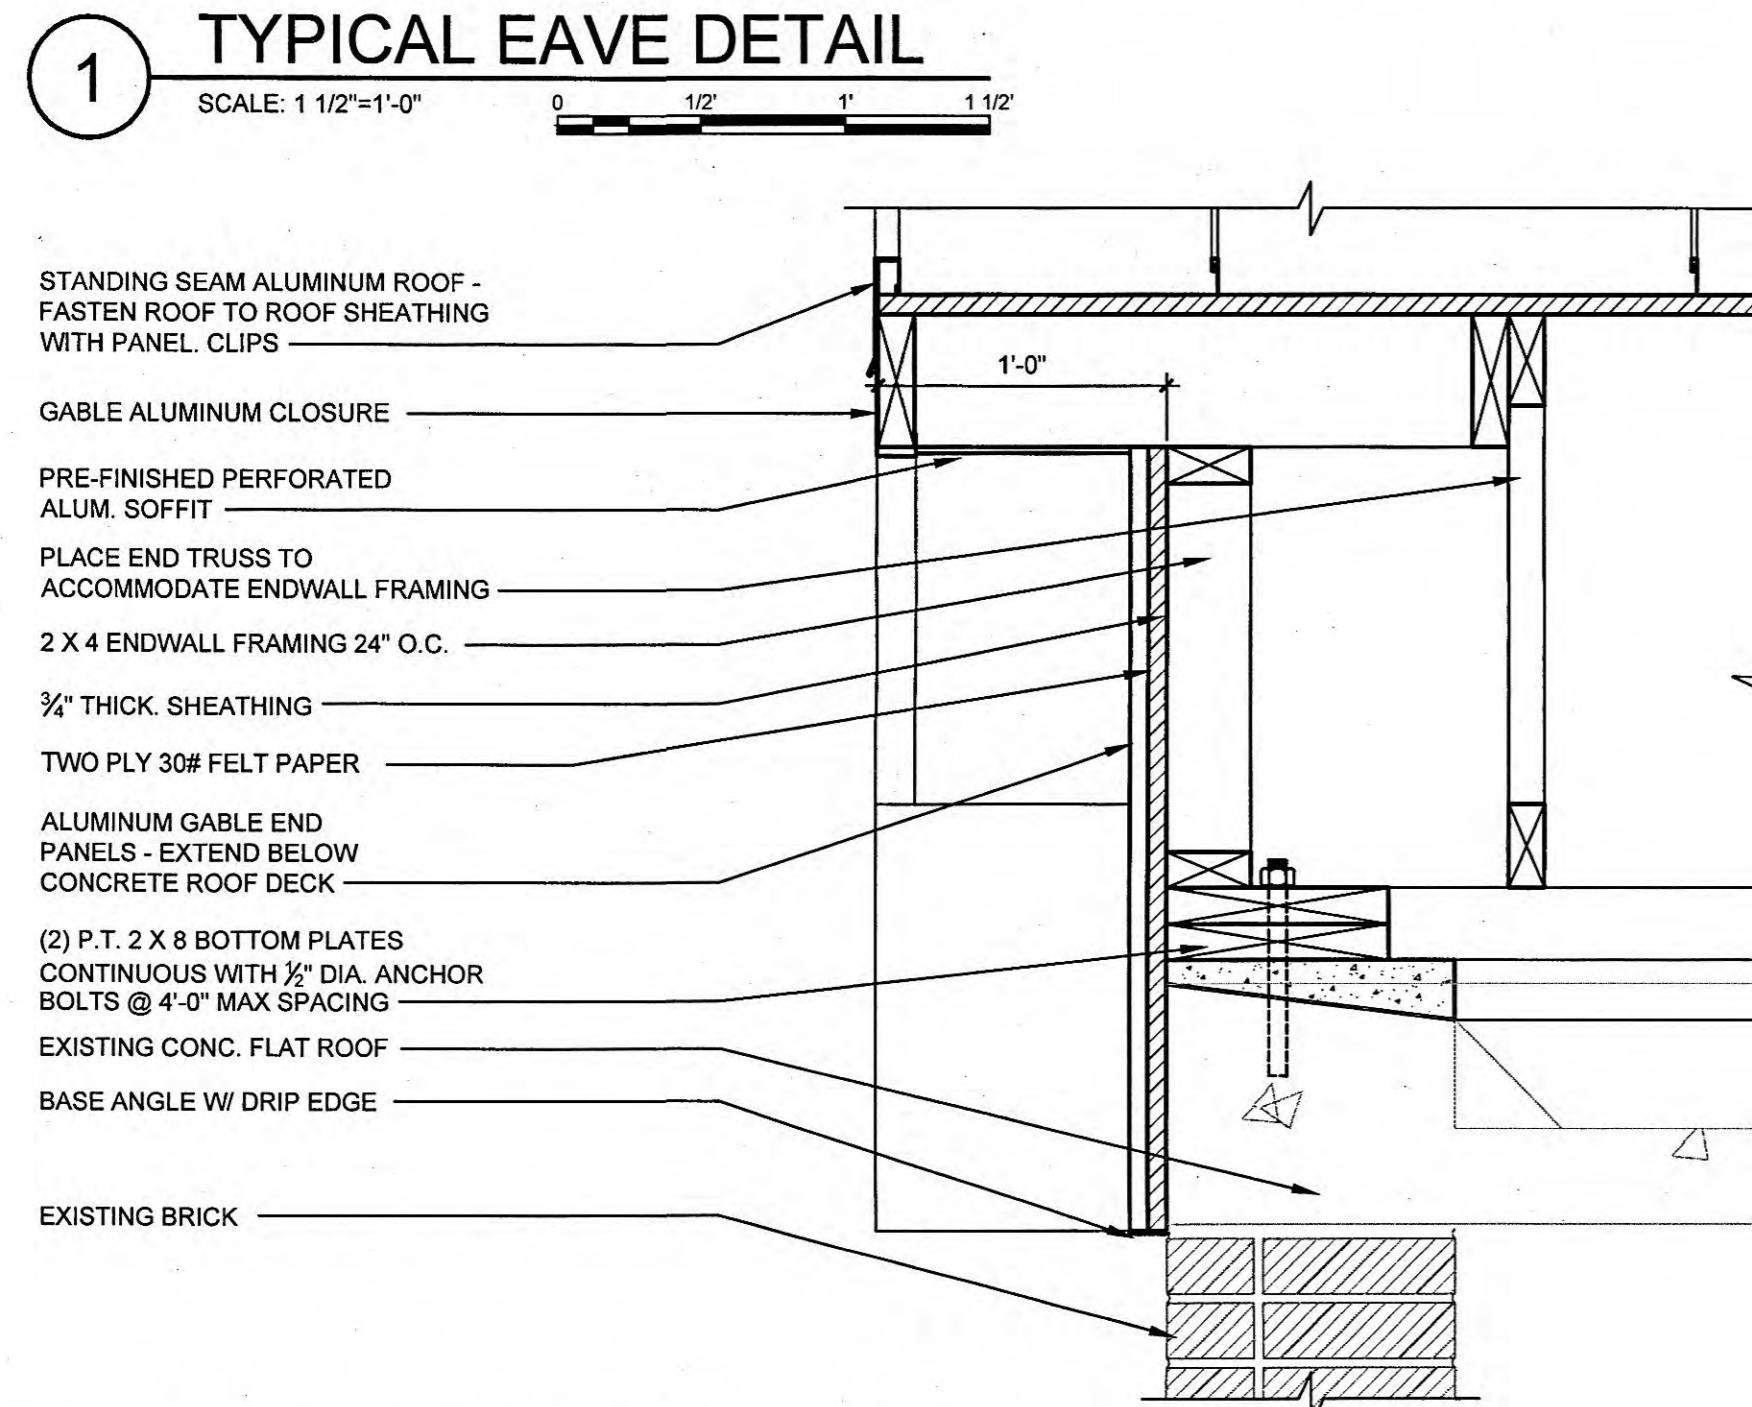
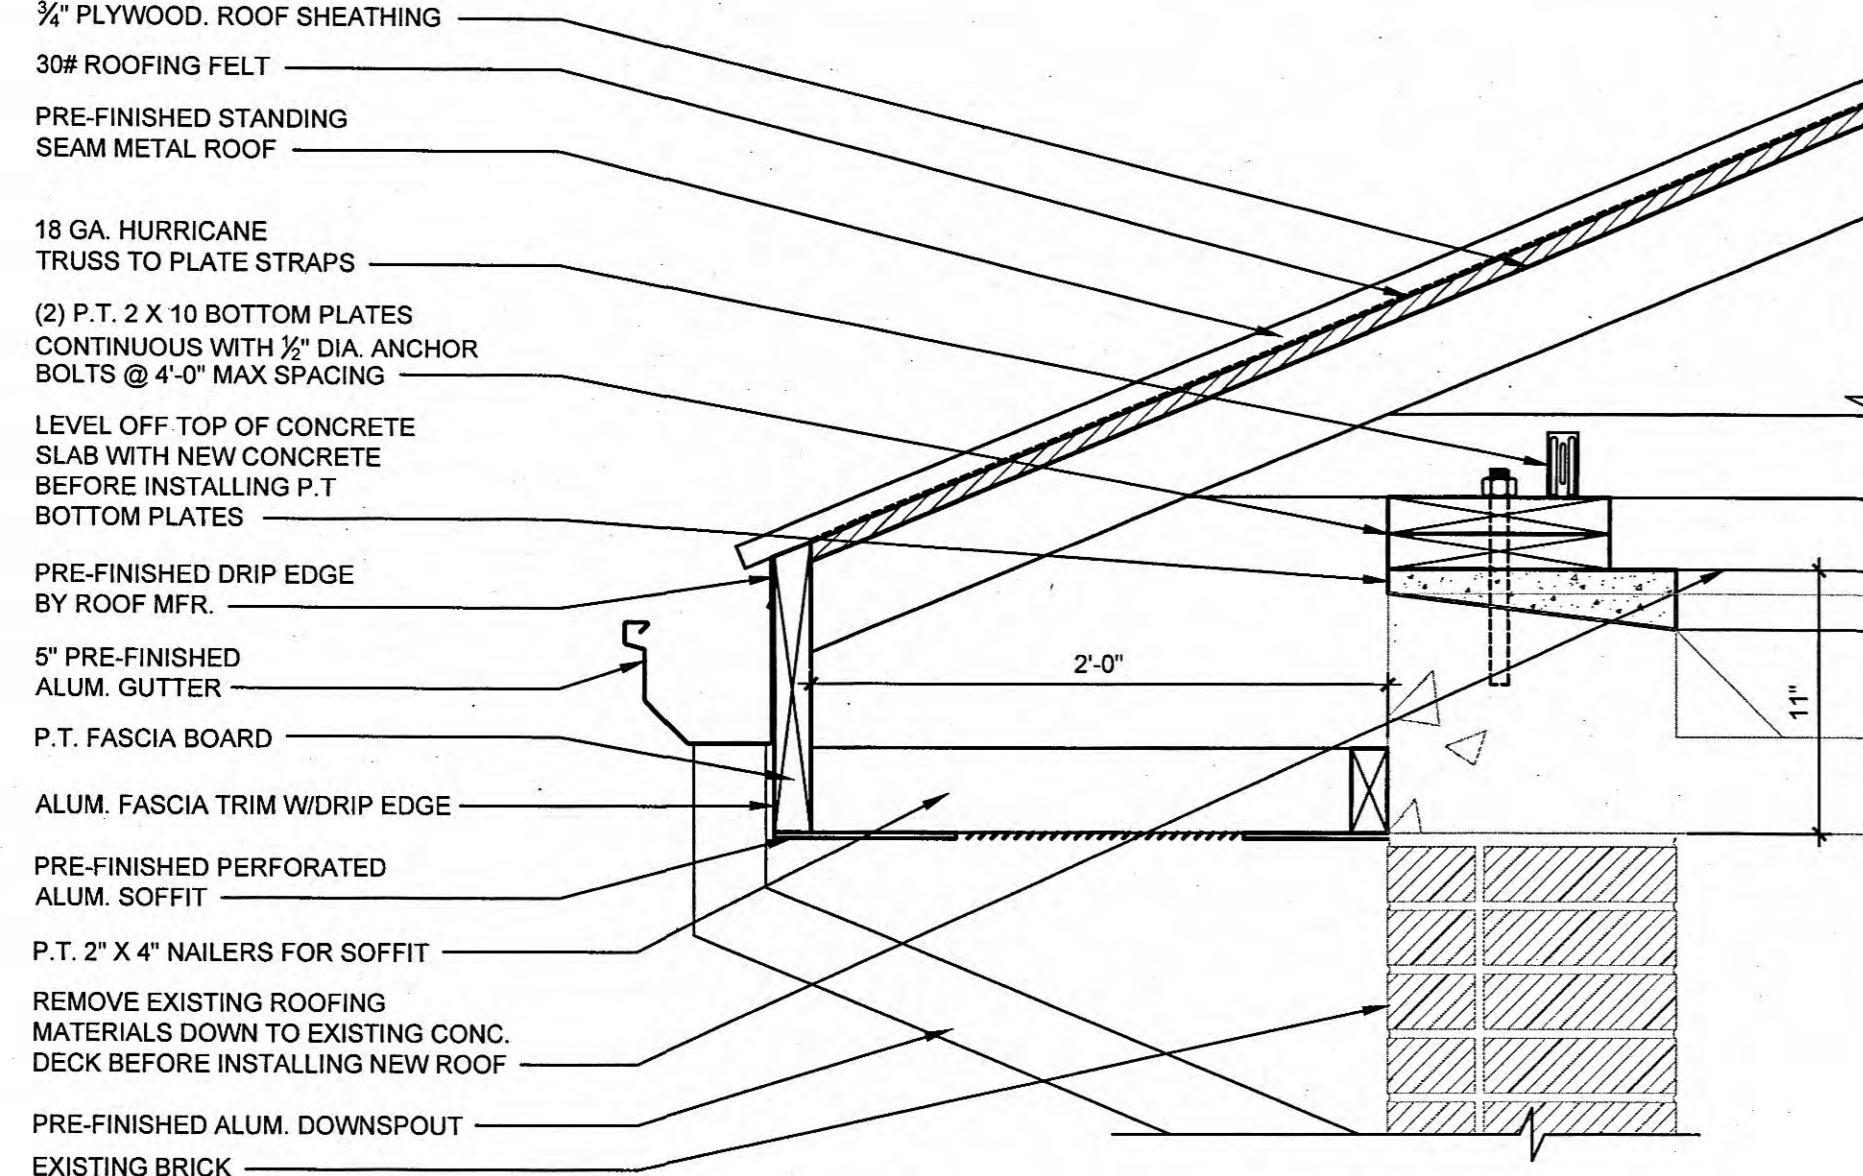
A-1-601

MARK	ROOM NAME	FLOOR		WALLS				CEILING				COMMENTS		
		MATERIAL	FINISH	NORTH	SOUTH	EAST	WEST	NORTH	SOUTH	EAST	WEST	MATERIAL	FINISH	
		CONCRETE	PAINT	CONCRETE	BRICK	CONCRETE	BRICK	CONCRETE	PAINT	PAINT	PAINT	CONCRETE	PAINT	
001	PUMP GALLERY	CONCRETE	PAINT	CONCRETE	BRICK	CONCRETE	BRICK	CONCRETE	PAINT	PAINT	PAINT	CONCRETE	PAINT	FULL HT.
101	CONTROL ROOM	CONCRETE	PAINT	BRICK	BRICK	BRICK	BRICK	PAINT	PAINT	PAINT	PAINT	CONCRETE	PAINT	FULL HT.

DOOR SCHEDULE													
MARK	DOOR SIZE	FIRE RATING	DOOR / FRAME TYPE	JAMB DEPTH	HARDWARE SET	FRAME MATERIAL	FRAME FINISH	DOOR MATERIAL	DOOR FINISH	HEAD DETAIL	JAMB DETAIL	SILL DETAIL	COMMENTS
101	(2) 3'-0" X 7'-2" X 1 3/4"	-	A / 1	5 1/2"	1	FRP	MFR'S STD.	INSULATED FRP	MFR'S STD.	5/A-1-301	6/A-1-301	7/A-1-301	CONTRACTOR TO FIELD VERIFY DOOR AND DOOR FRAME SIZE WITH EXISTING OPENING PRIOR TO ORDERING

MARK	SIZE		TYPE	MATERIAL	FINISH		HEAD DETAIL	JAMB DETAIL	SILL DETAIL	COMMENTS
	WIDTH	HEIGHT			EXTERIOR	INTERIOR				
101A	3'-5"	1'-10"	A	FRP	MFR'S STD.	MFR'S STD.	10/A-1-301	11/A-1-301	12/A-1-301	CONTRACTOR TO FIELD VERIFY WINDOW DIMENSIONS WITH EXISTING OPENINGS PRIOR TO ORDERING
101B	3'-5"	1'-10"	A	FRP	MFR'S STD.	MFR'S STD.	10/A-1-301	11/A-1-301	12/A-1-301	CONTRACTOR TO FIELD VERIFY WINDOW DIMENSIONS WITH EXISTING OPENINGS PRIOR TO ORDERING
101C	3'-5"	1'-10"	A	FRP	MFR'S STD.	MFR'S STD.	10/A-1-301	11/A-1-301	12/A-1-301	CONTRACTOR TO FIELD VERIFY WINDOW DIMENSIONS WITH EXISTING OPENINGS PRIOR TO ORDERING
101D	3'-5"	1'-10"	A	FRP	MFR'S STD.	MFR'S STD.	10/A-1-301	11/A-1-301	12/A-1-301	CONTRACTOR TO FIELD VERIFY WINDOW DIMENSIONS WITH EXISTING OPENINGS PRIOR TO ORDERING
101E	3'-5"	1'-10"	A	FRP	MFR'S STD.	MFR'S STD.	10/A-1-301	11/A-1-301	12/A-1-301	CONTRACTOR TO FIELD VERIFY WINDOW DIMENSIONS WITH EXISTING OPENINGS PRIOR TO ORDERING
101F	3'-5"	1'-10"	A	FRP	MFR'S STD.	MFR'S STD.	10/A-1-301	11/A-1-301	12/A-1-301	CONTRACTOR TO FIELD VERIFY WINDOW DIMENSIONS WITH EXISTING OPENINGS PRIOR TO ORDERING
101G	3'-5"	1'-10"	A	FRP	MFR'S STD.	MFR'S STD.	10/A-1-301	11/A-1-301	12/A-1-301	CONTRACTOR TO FIELD VERIFY WINDOW DIMENSIONS WITH EXISTING OPENINGS PRIOR TO ORDERING









EXISTING LADD PUMP STATION DEMOLITION AND UPGRADE FLOOR PLANS
PUMP STATION REHABILITATION CITY OF HARRIMAN, TENNESSEE

REVISIONS	DESCRIPTION	DESIGNED:	DATE	BY	DRAWN:	REVIEWED:	APPROVED:
NO.							
DATE:							
SCALE:							
NOTE:	THIS MARK SHOULD MEASURE EXACTLY 1" WHEN PLOTTED						
SCALE CHECK:							
DATE:	DECEMBER 2012						
SCALE:	1/4" = 1'-0"						
SHEET NO.:							

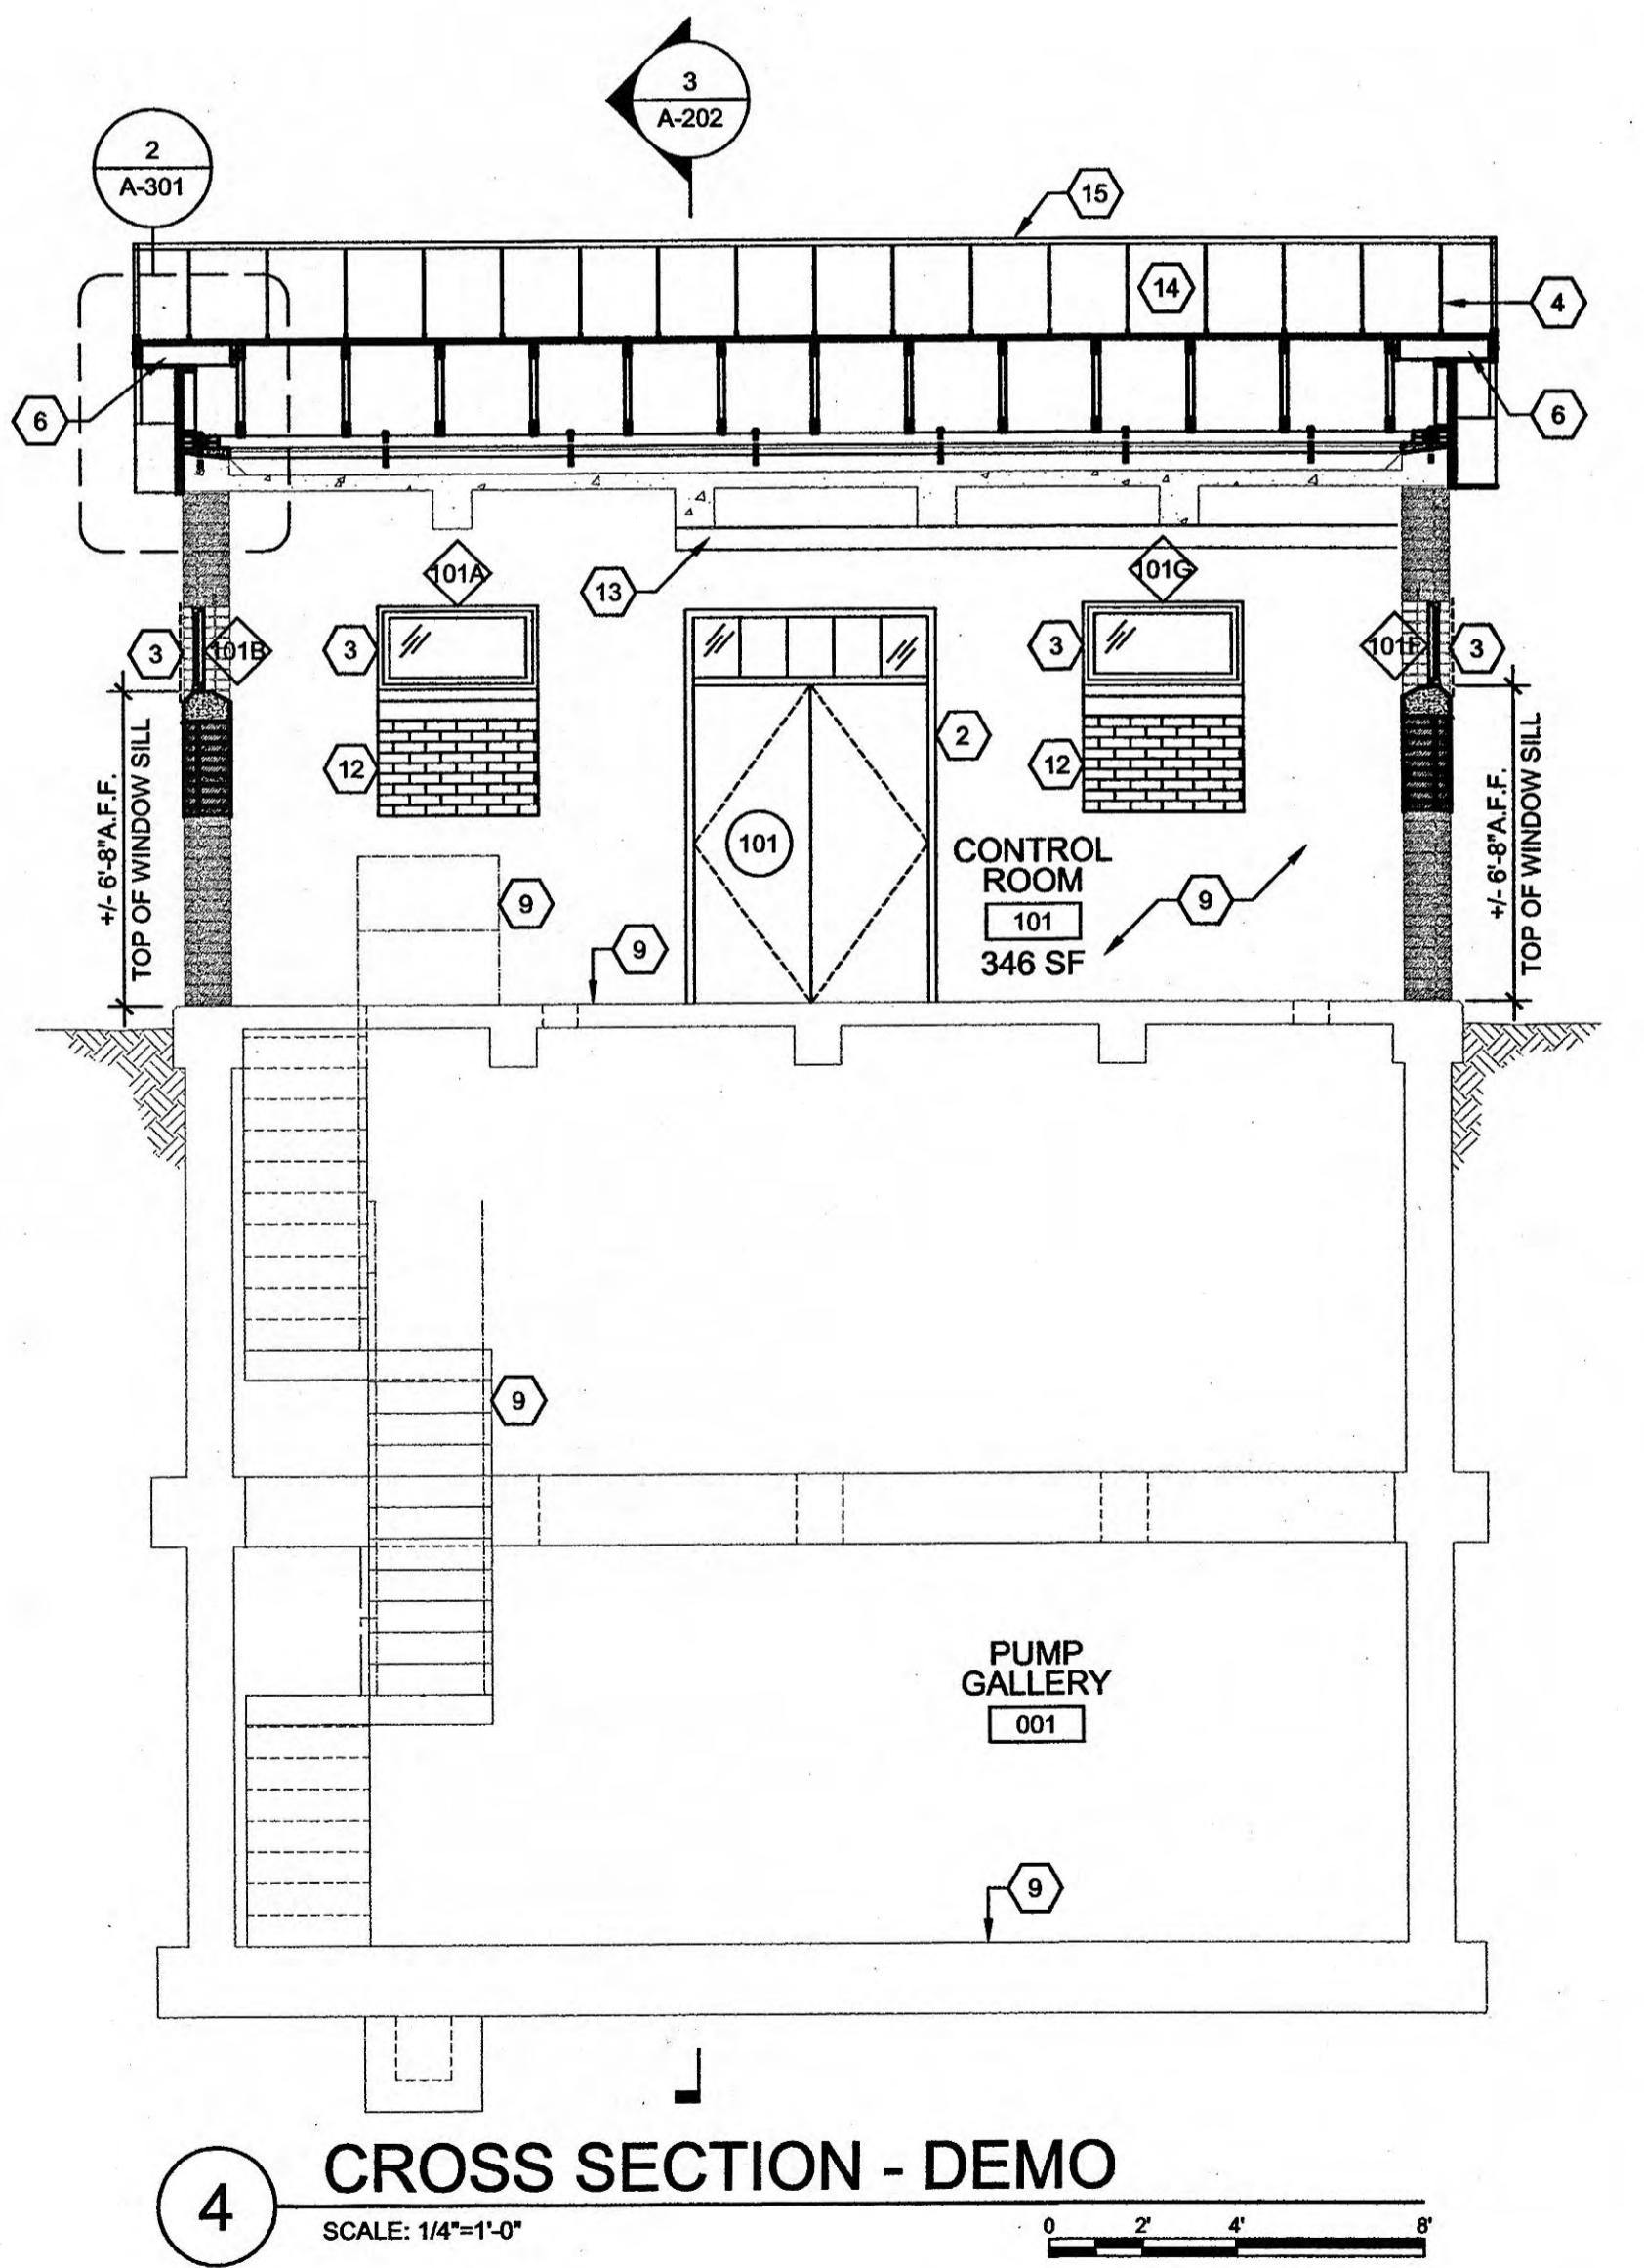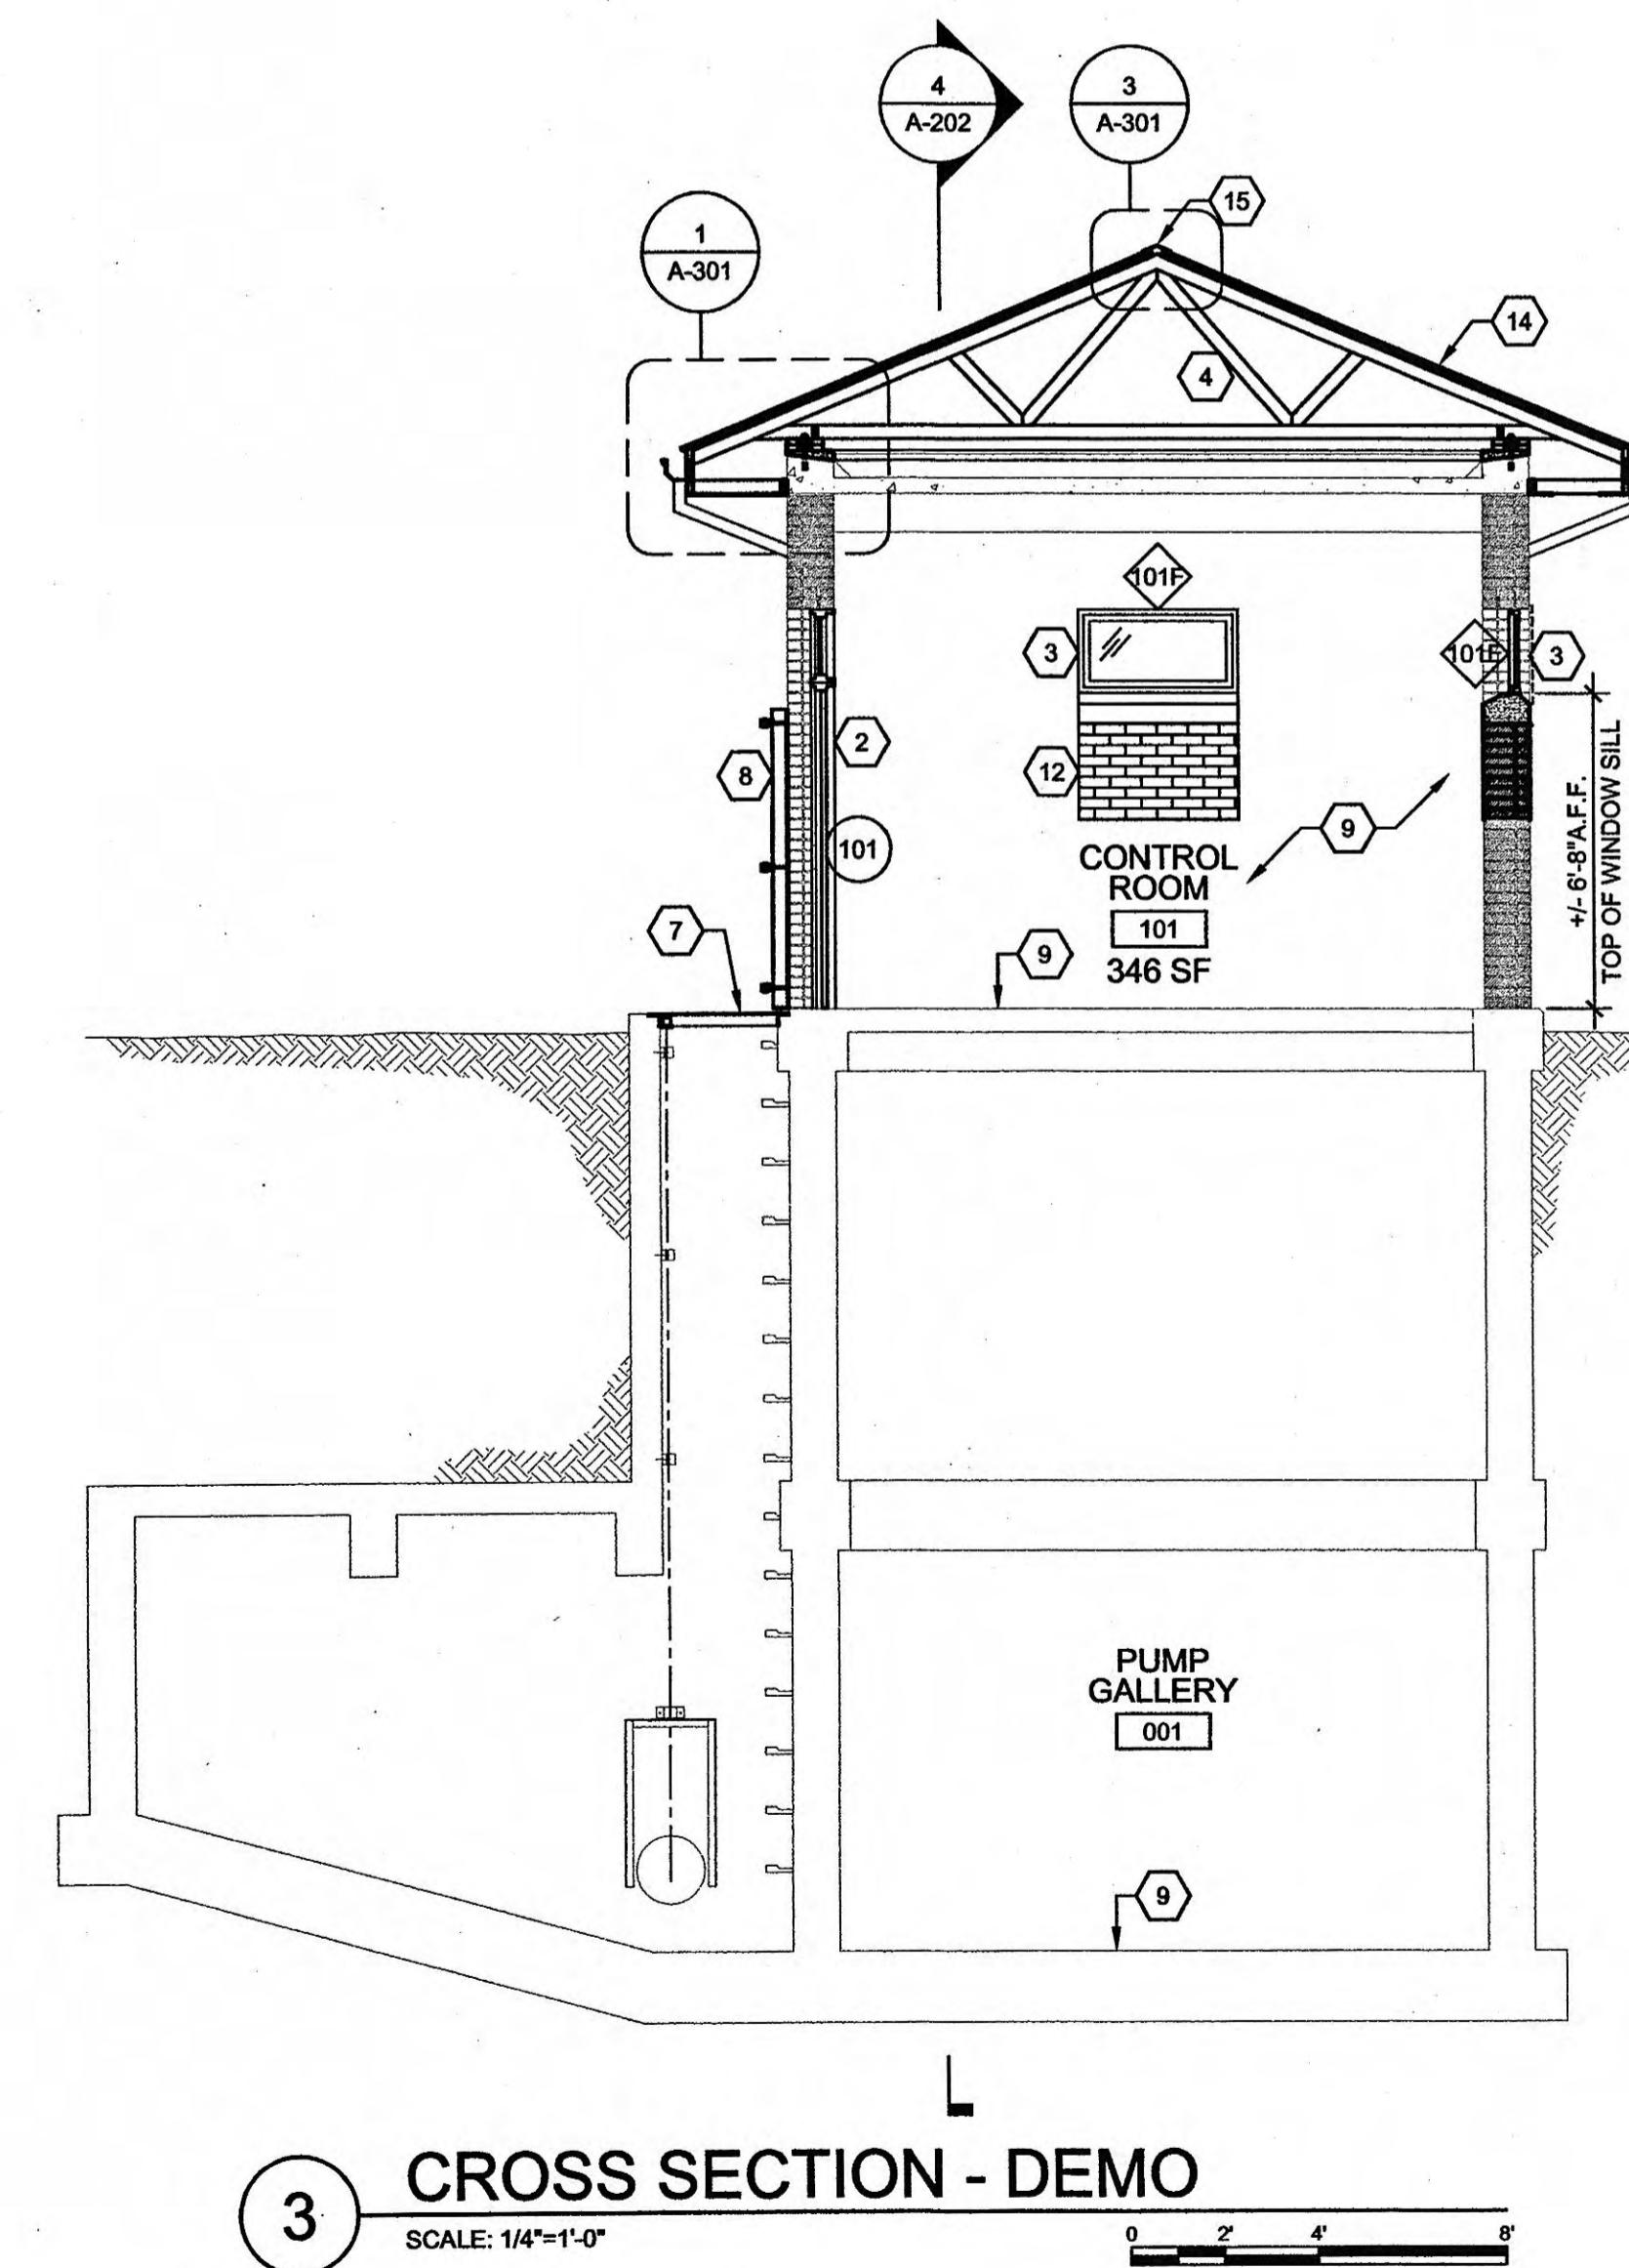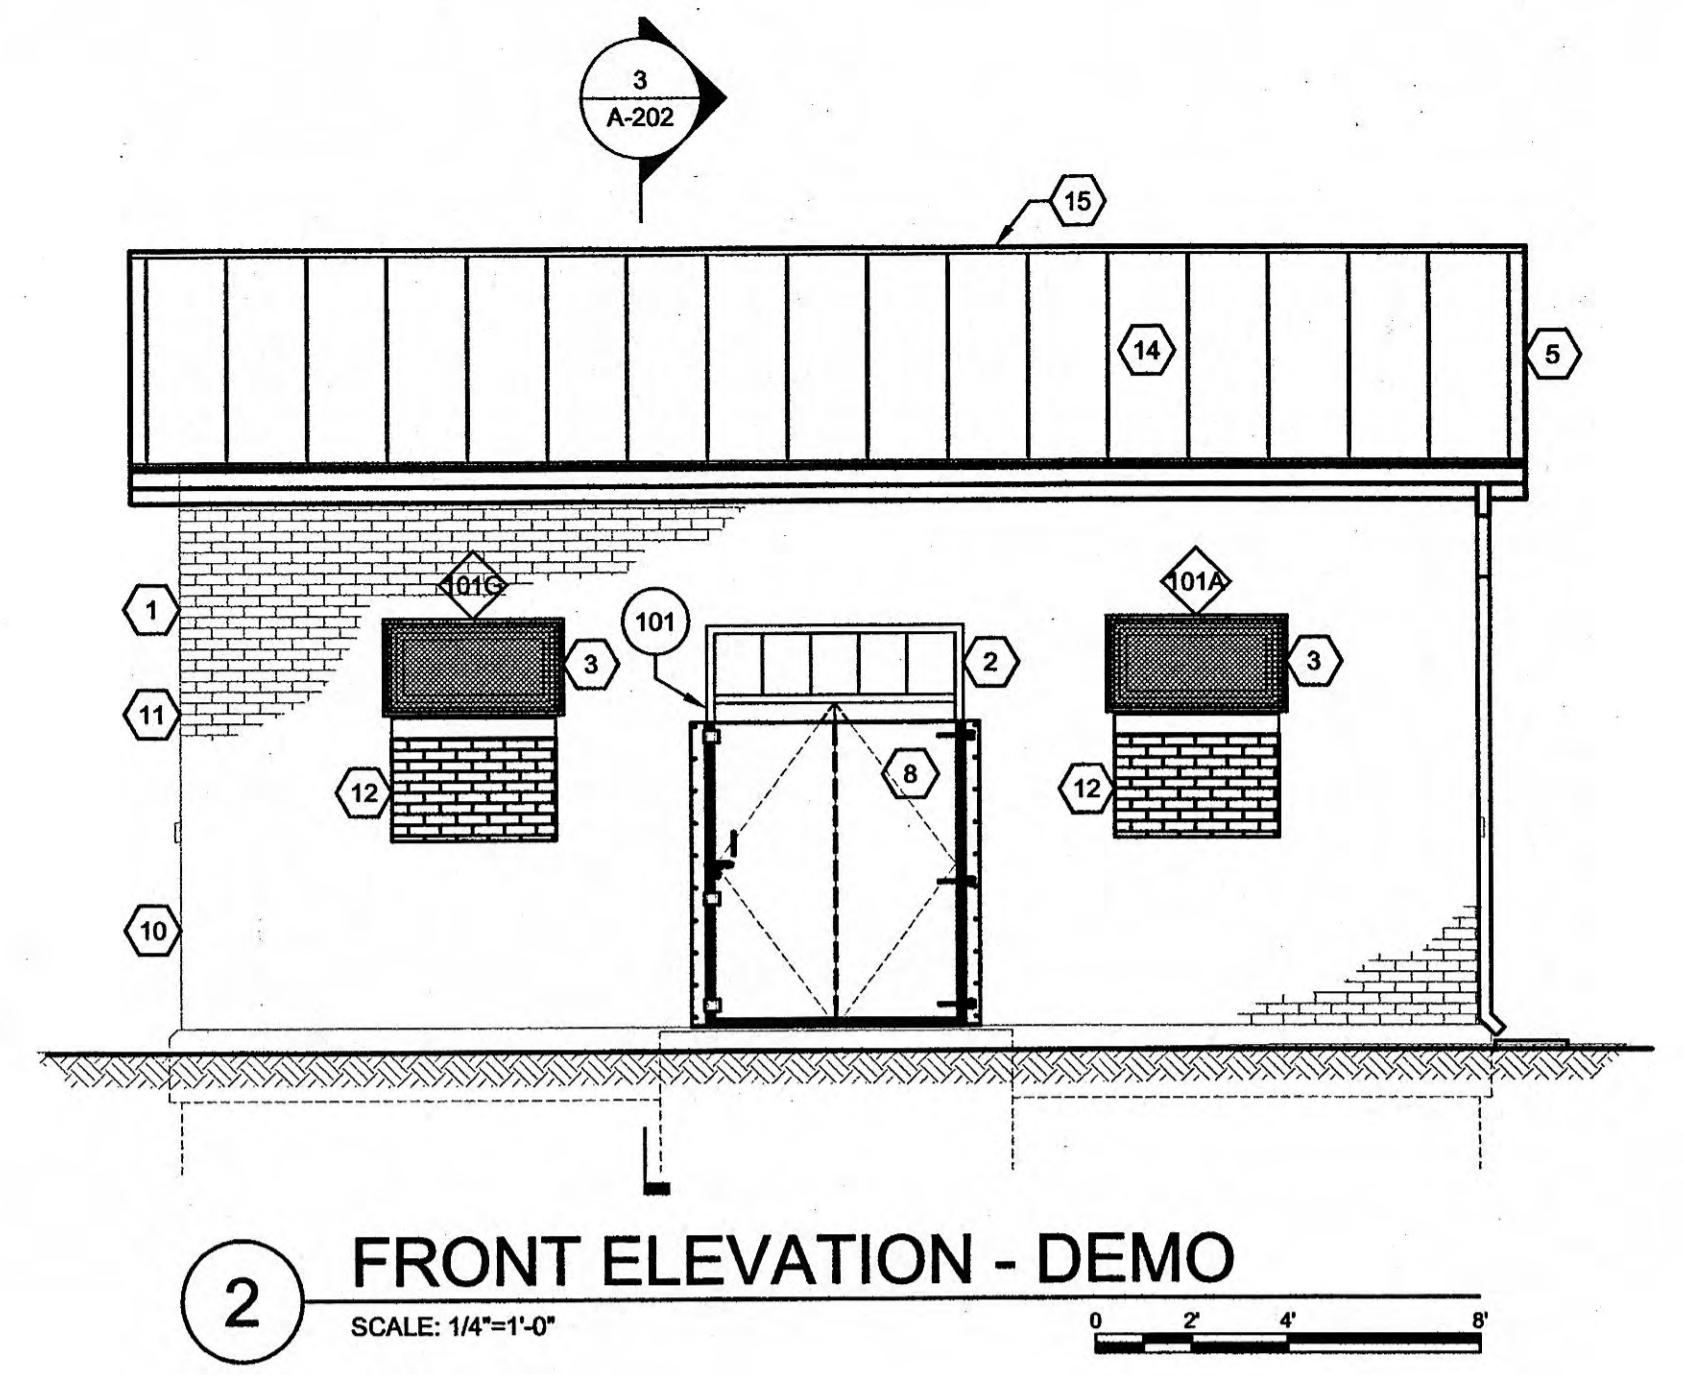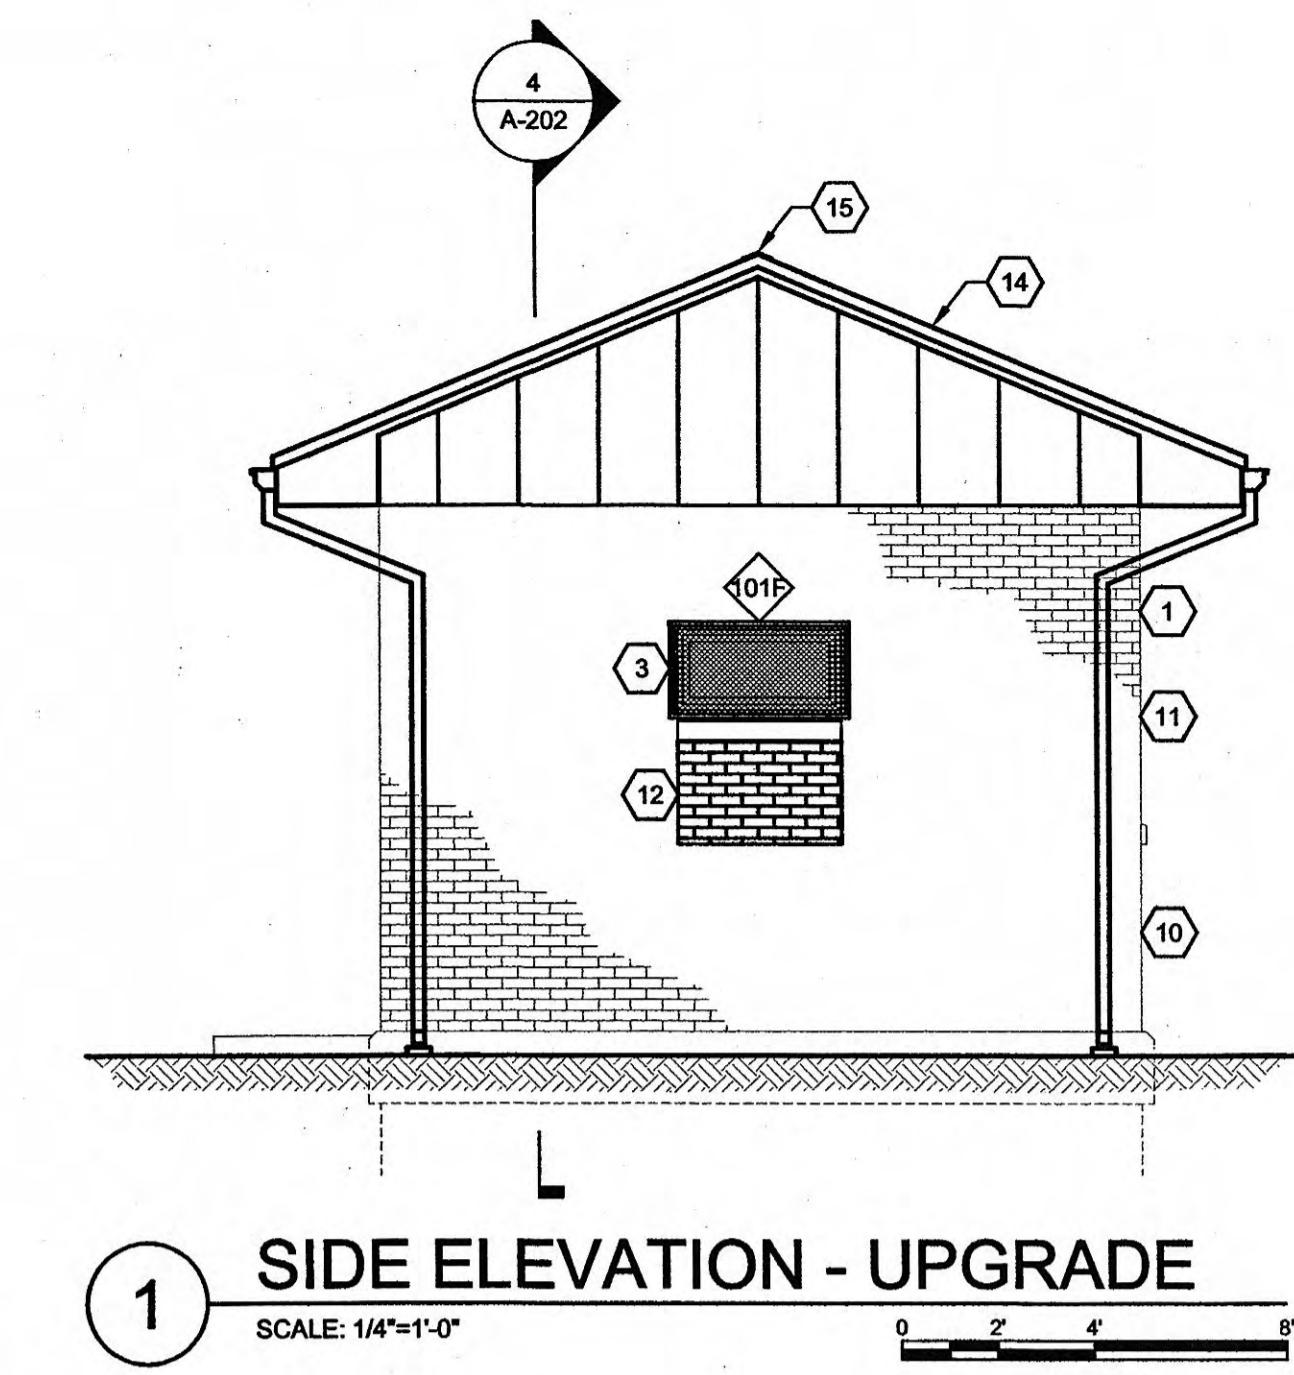A-1-301



GENERAL NOTES:	
1. DOORS & WINDOWS ARE SHOWN FOR REFERENCE PURPOSES ONLY, SEE WINDOW & DOOR SCHEDULE FOR ACTUAL SIZES.	
2. SEE ARCHITECTURAL GENERAL SHEET A-0-001 FOR TYPICAL WALL TYPE DESCRIPTIONS.	
3. MECHANICAL, ELECTRICAL AND PLUMBING FIXTURES ILLUSTRATED AND NOT NOTED ON DRAWINGS ARE FOR ARCHITECTURAL LAYOUT PURPOSES ONLY. REFER TO THE RESPECTIVE DISCIPLINE DRAWINGS FOR EQUIPMENT IN CONTRACT.	
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5. PATCH ALL DISTURBED SURFACES TO MATCH ADJACENT CONSTRUCTION AND FINISH.	

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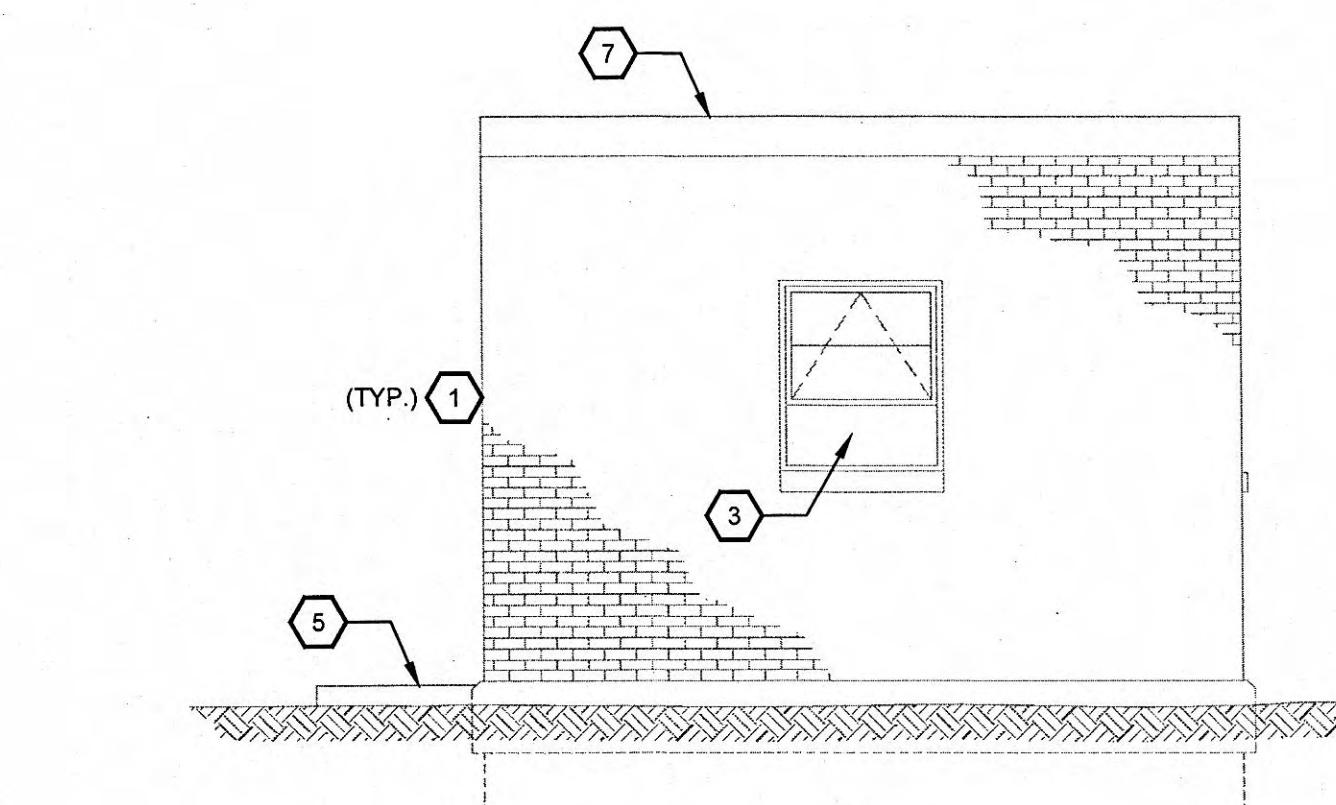
EXISTING LADD PUMP STATION DEMOLITION AND UPGRADE FLOOR PLANS

PUMP STATION REHABILITATION
CITY OF HARRIMAN, TENNESSEE

REVISIONS	DESCRIPTION	DESIGNED BY	TMCH
		DRAWN BY	TMCH
		REVIEWED BY	BSL
		APPROVED BY	BSL
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DATE:	DECEMBER 2012		
SCALE:	1/4" = 1'-0"		
SHEET NO.			

A-1-202


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1 SIDE ELEVATION - DEMO

SCALE: 1/4"=1'-0"


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2 FRONT ELEVATION - DEMO
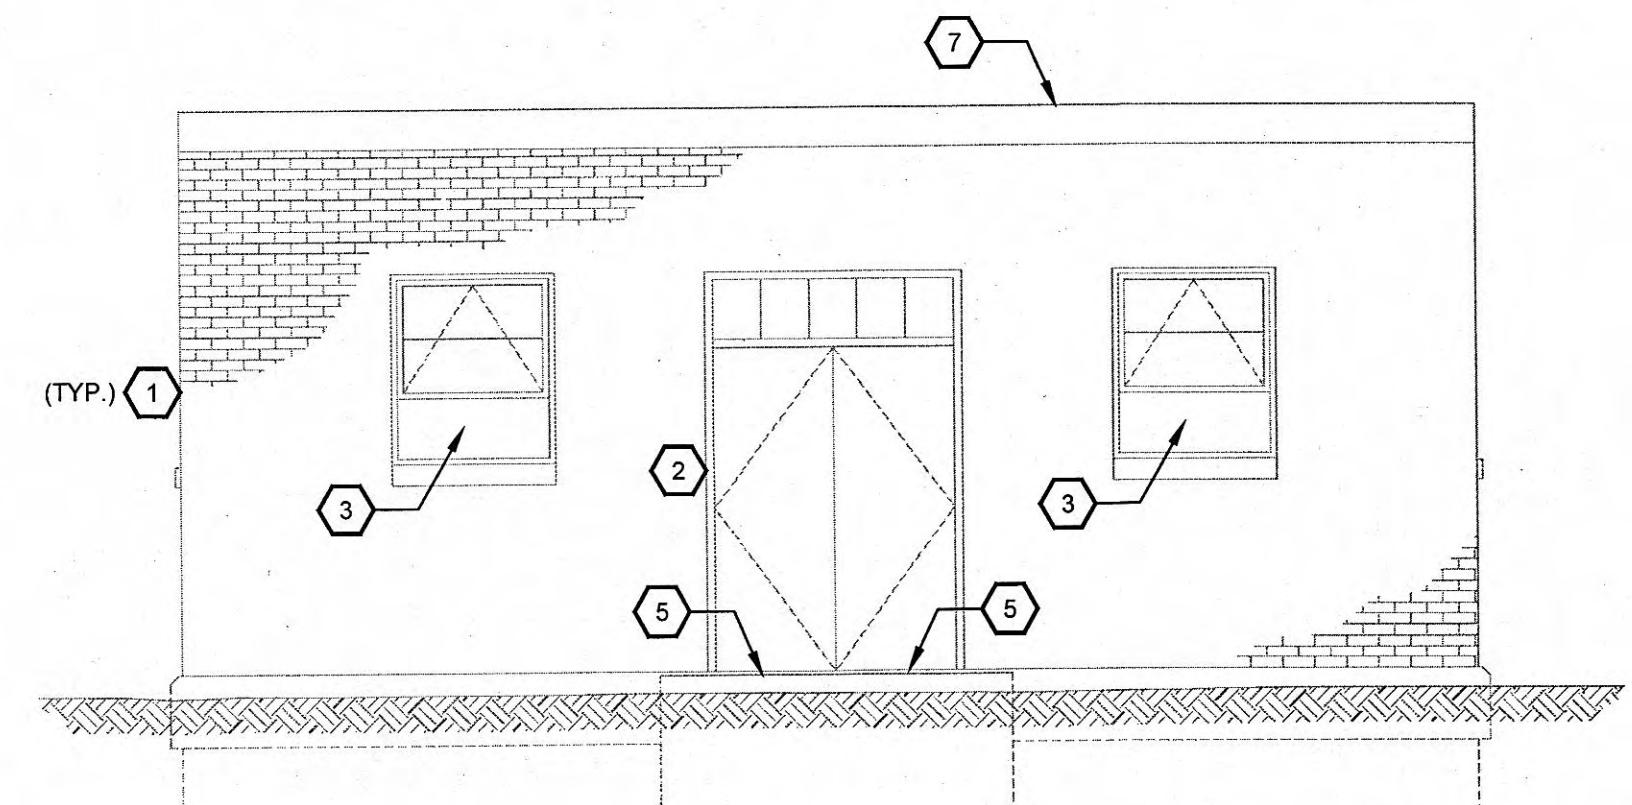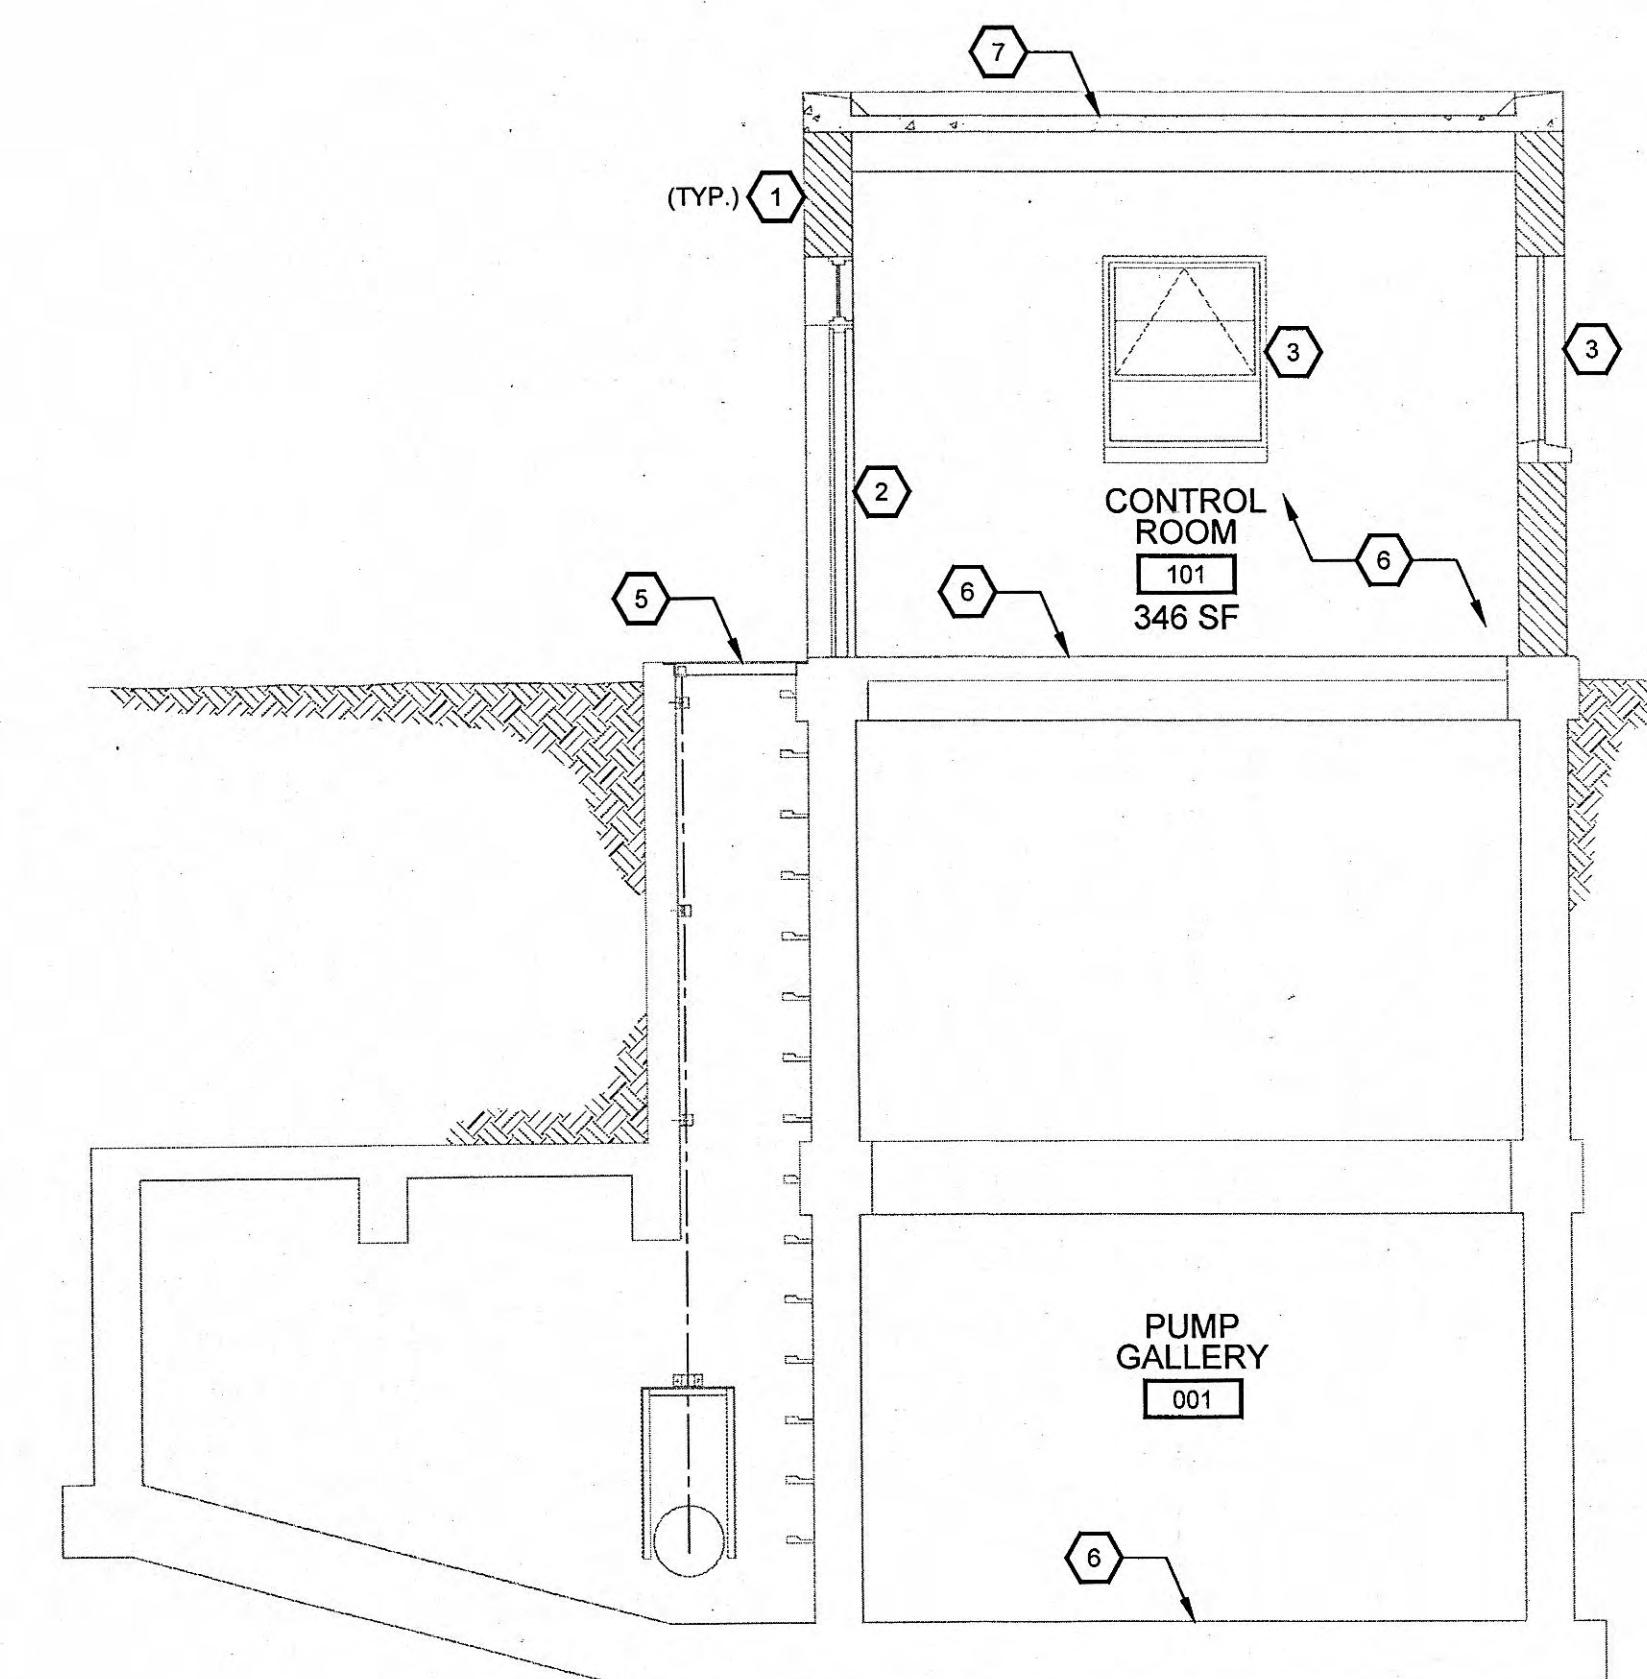
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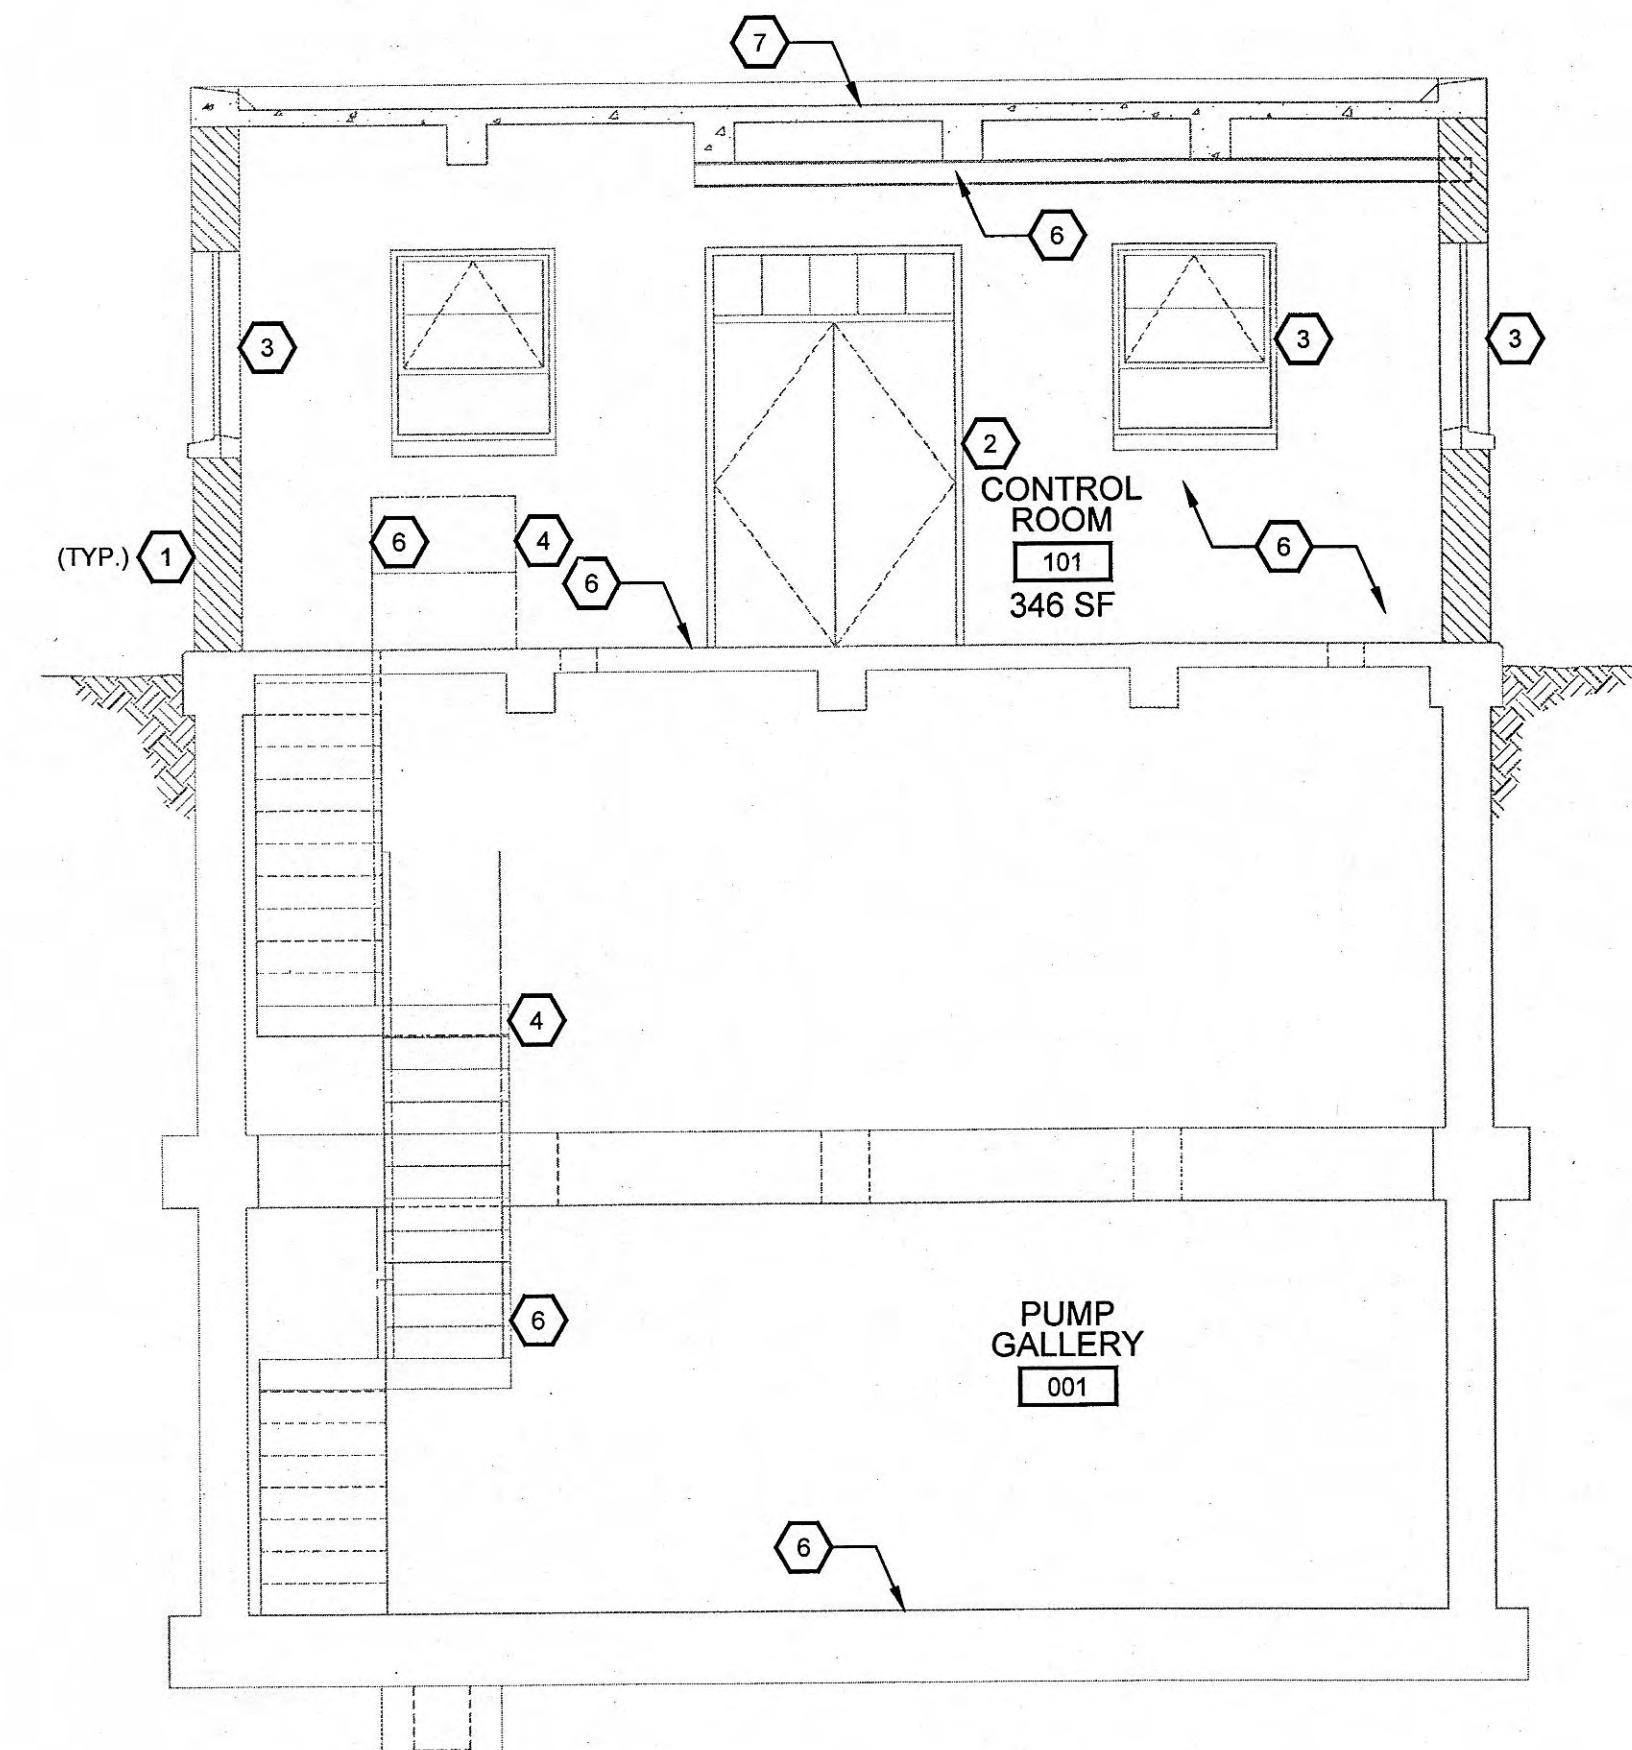
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3 CROSS SECTION - DEMO

SCALE: 1/4"=1'-0"

0 2' 4' 8'



4 CROSS SECTION - DEMO

SCALE: 1/4"=1'-0"

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GENERAL NOTES:

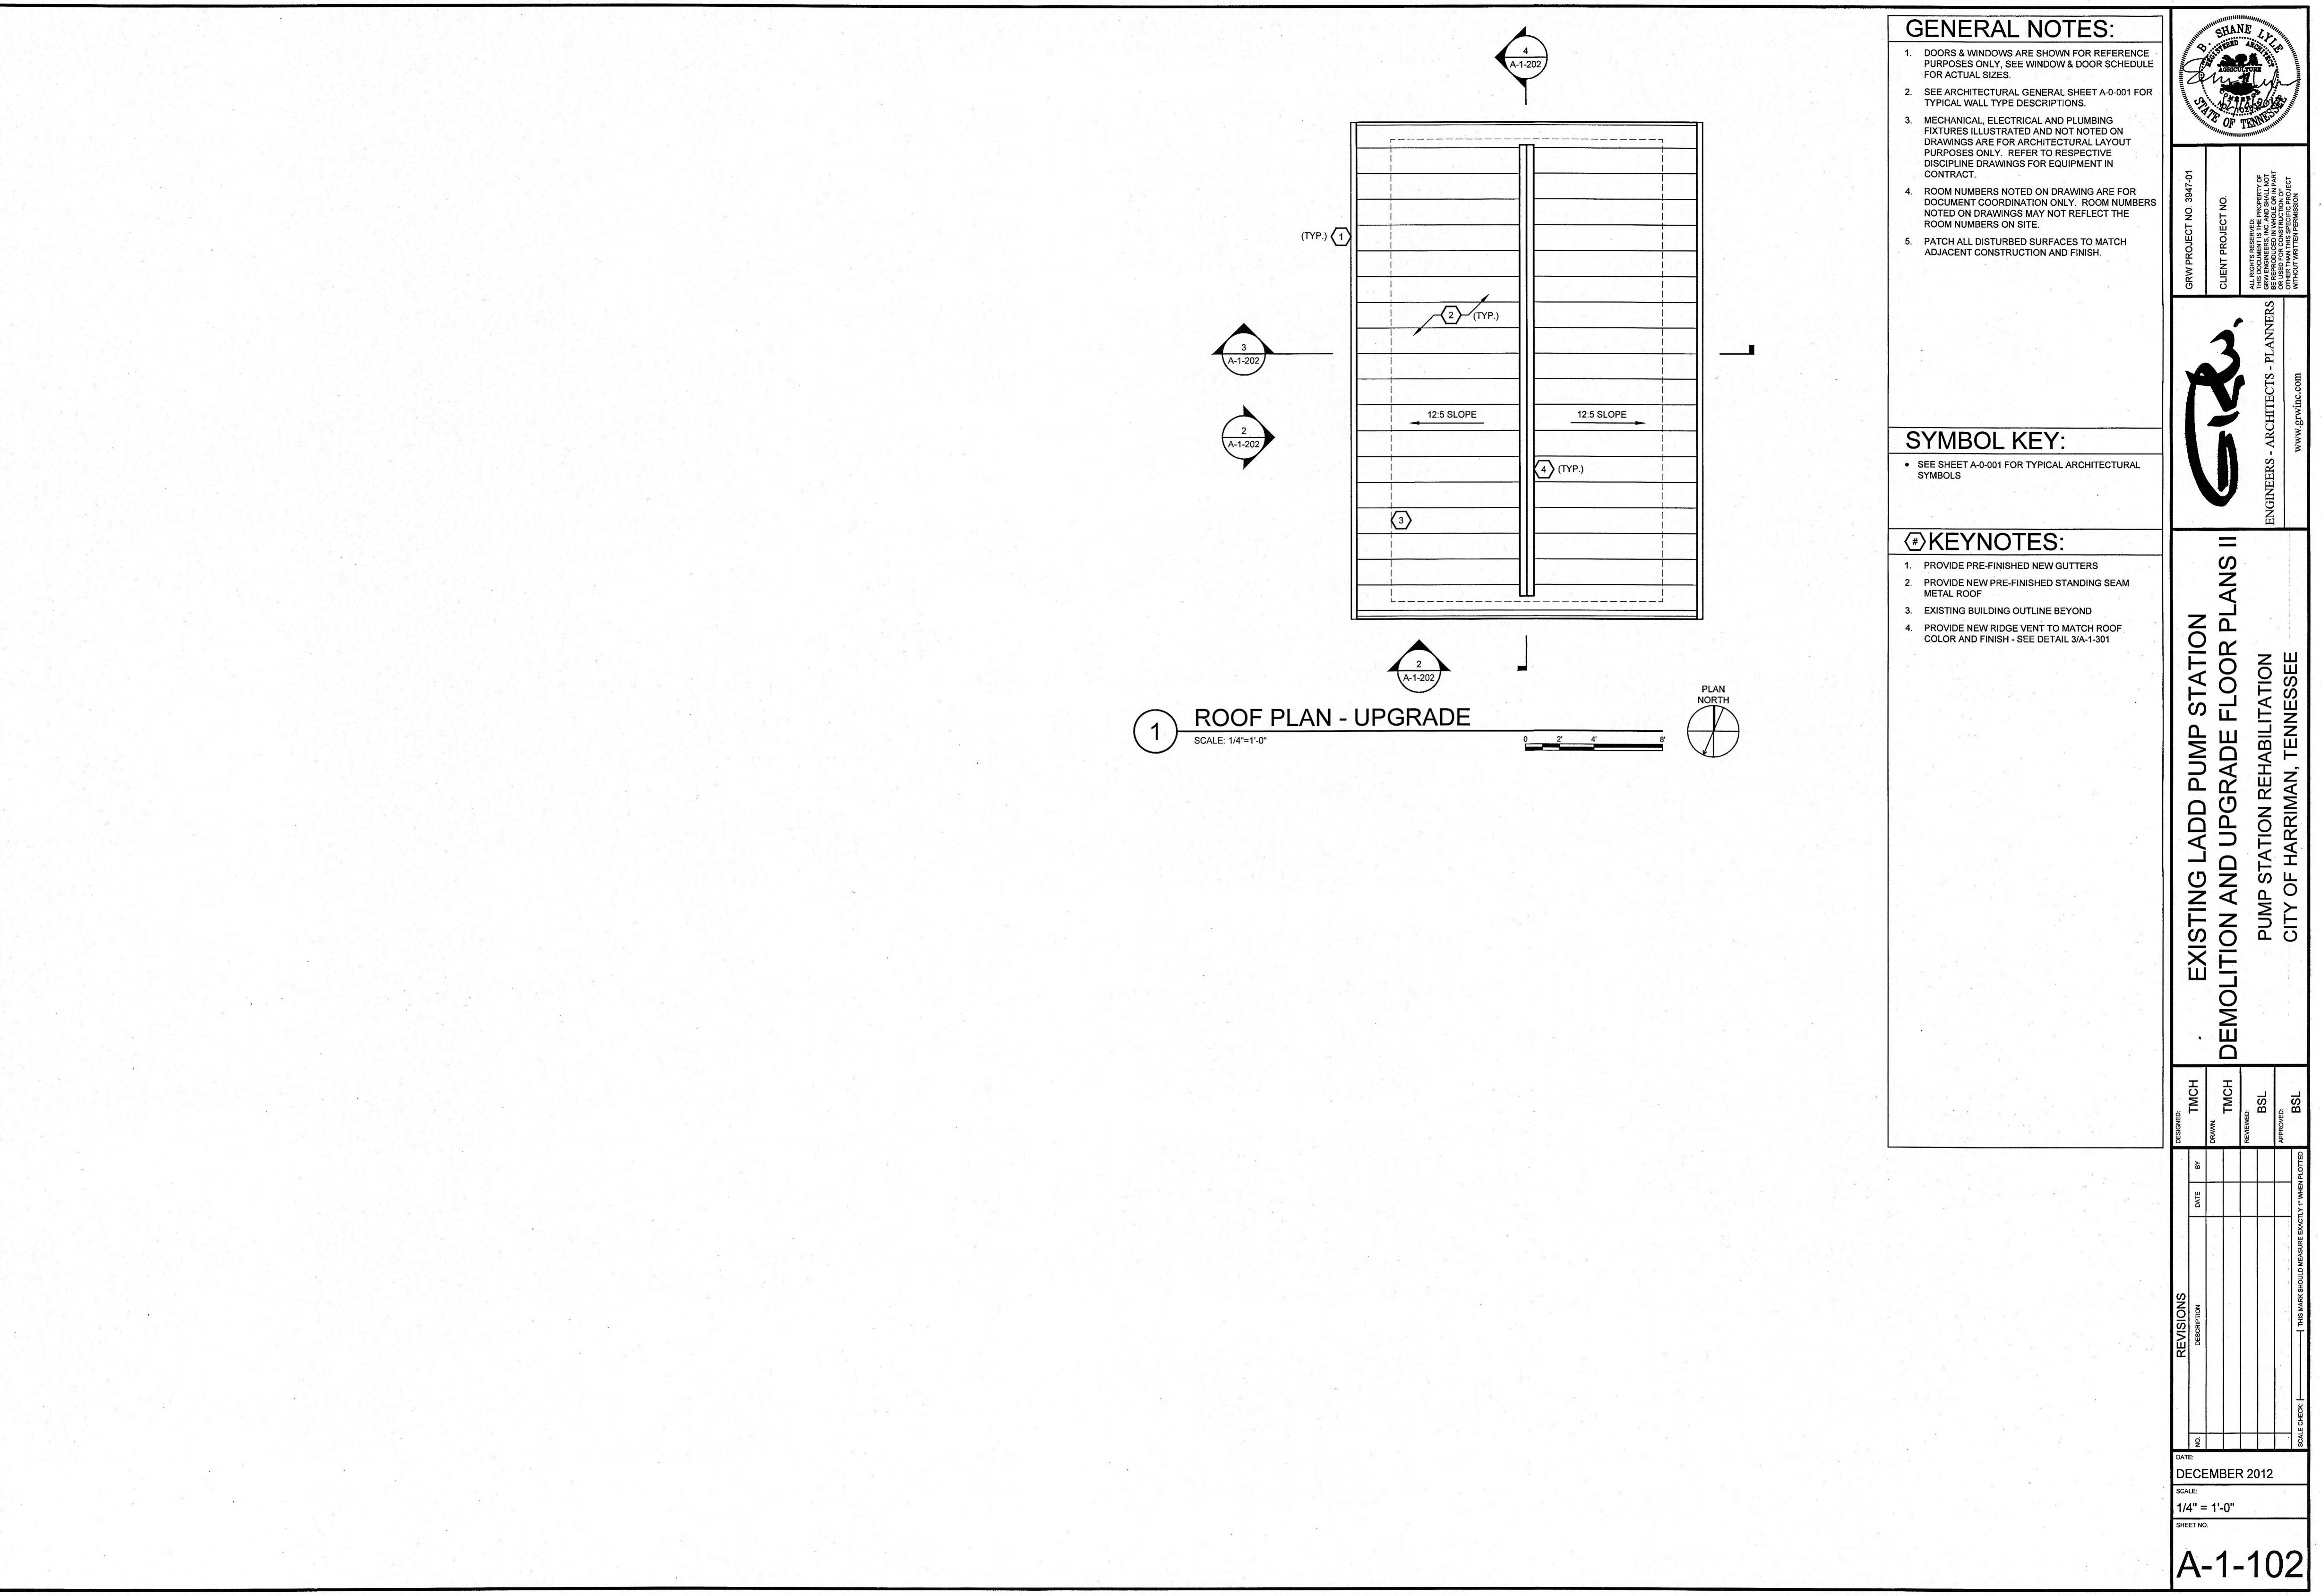
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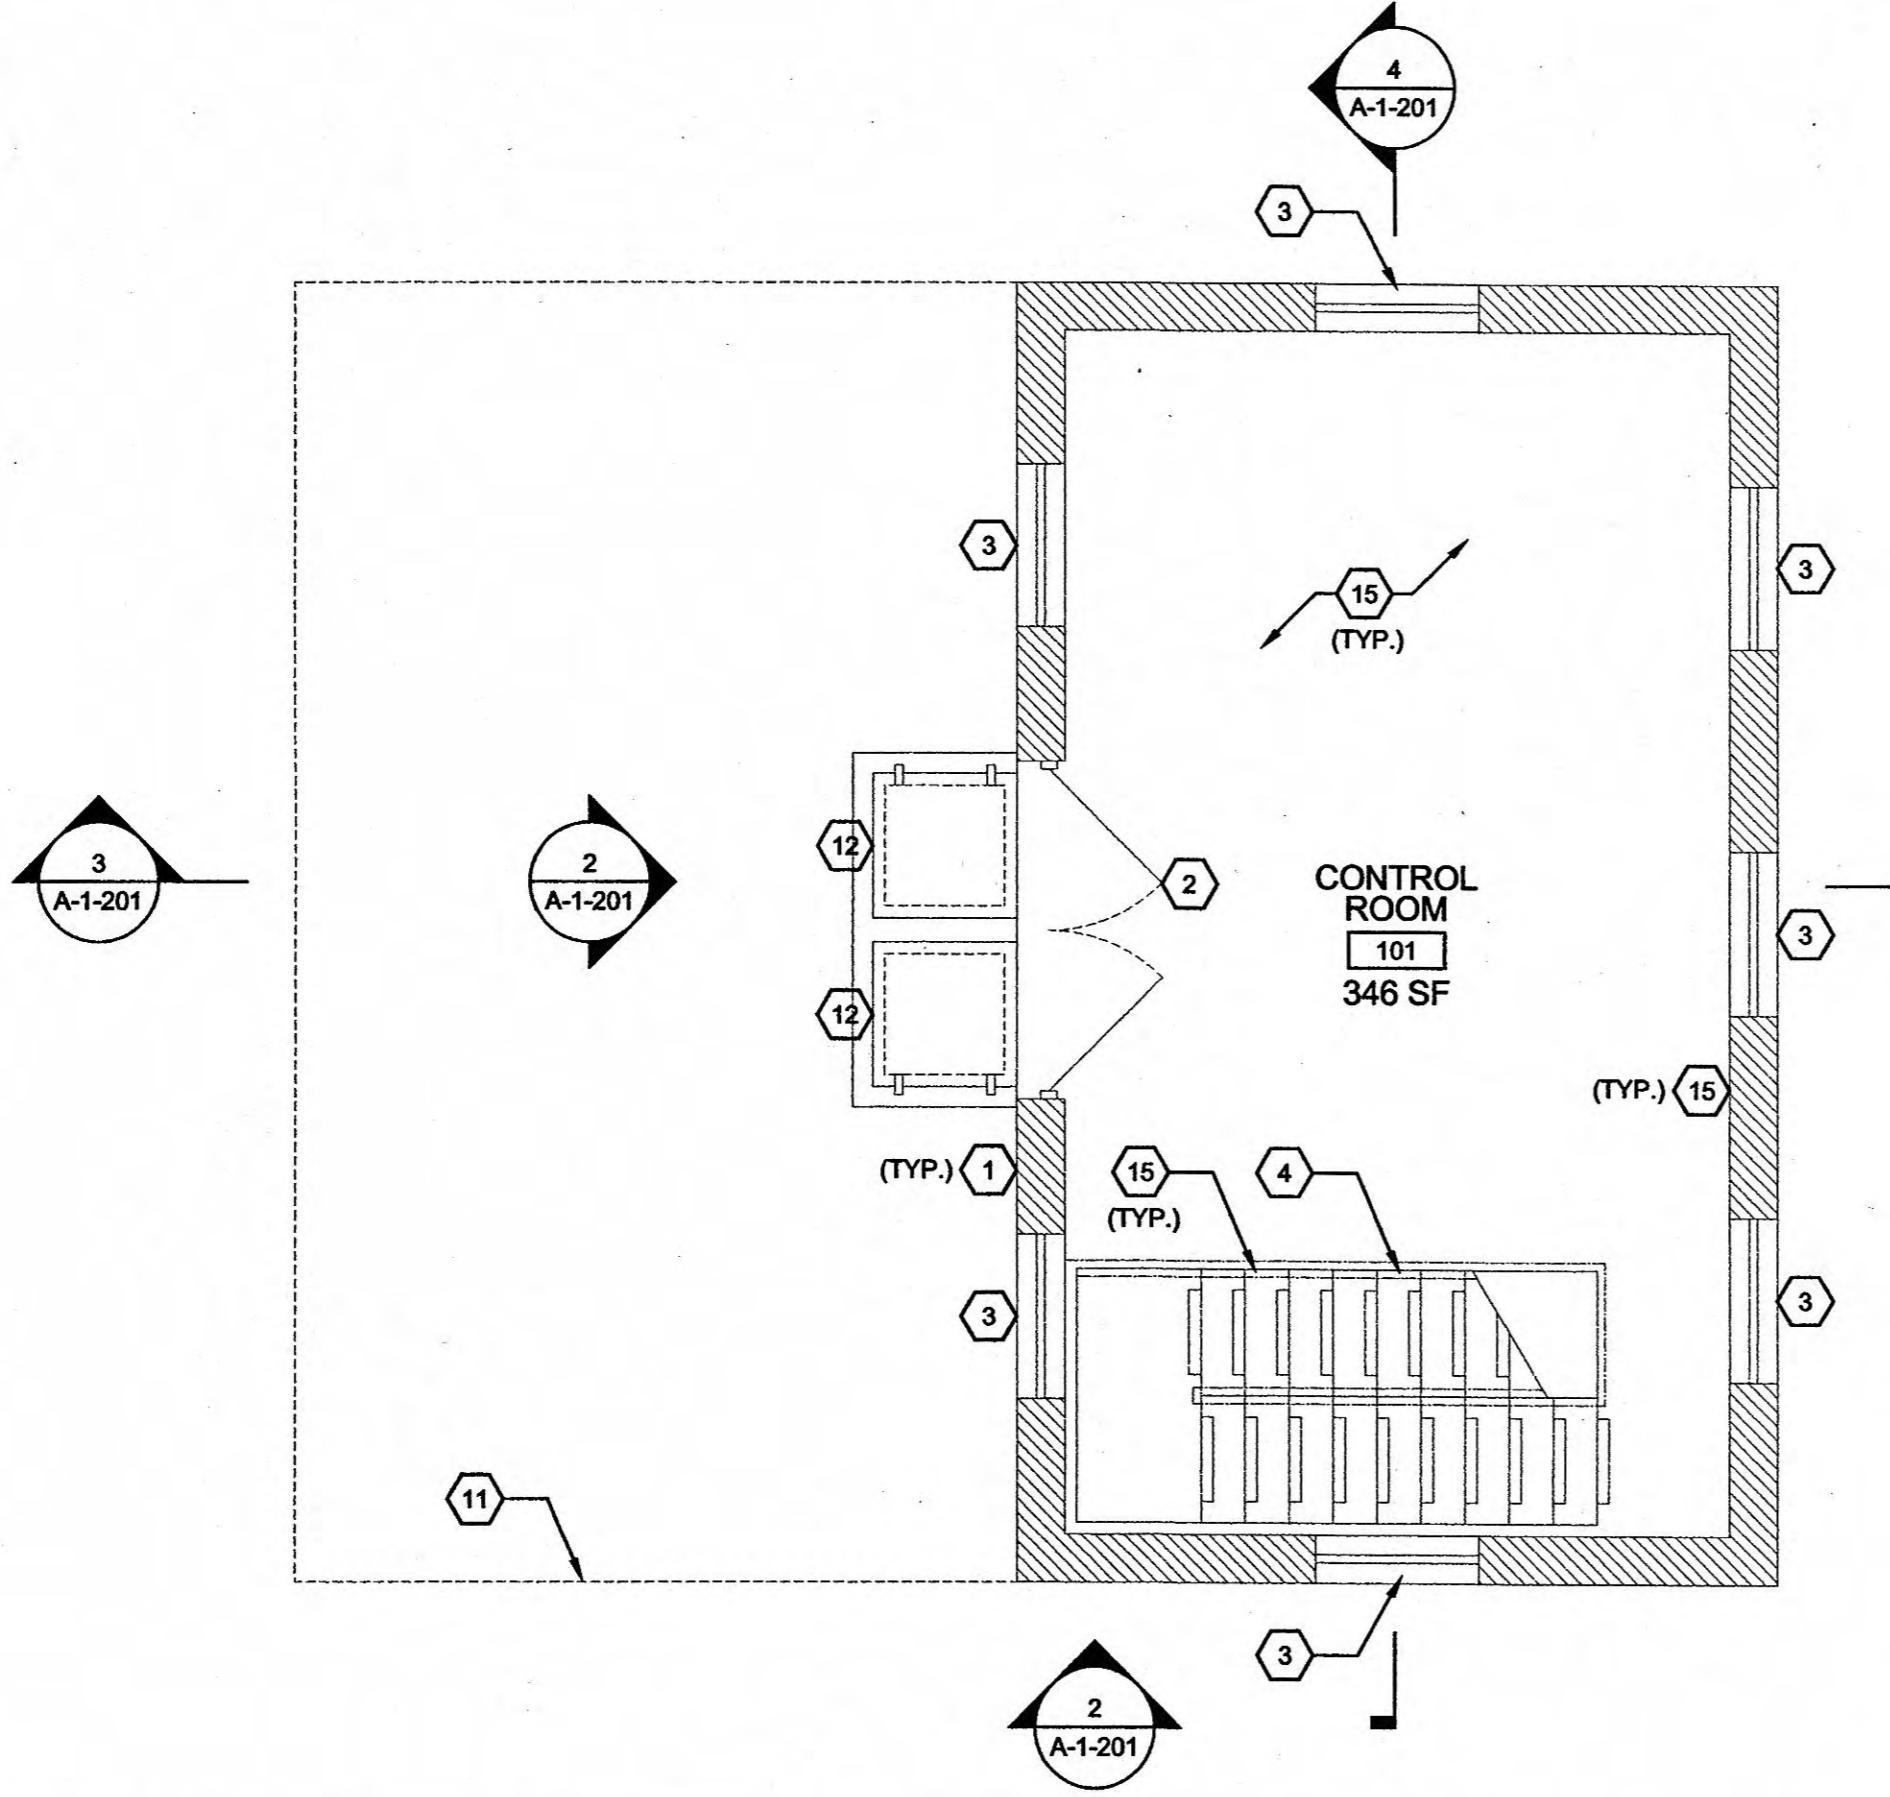
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THE CITY OF HARRIMAN, TENNESSEE.
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BE REPRODUCED IN WHOLE OR IN PART
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WITHOUT WRITTEN PERMISSIONEXISTING LADD PUMP STATION
DEMOLITION ELEVATIONS & SECTIONSPUMP STATION REHABILITATION
CITY OF HARRIMAN, TENNESSEE

DESIGNED:	TMCH
DRAWN:	TMCH
REVIEWED:	BSL
APPROVED:	BSL
REVISIONS	NO. DATE BY
DESCRIPTION	DATE DRAWN
DATE:	DECEMBER 2012
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SCALE CHECK:	

A-1-201






1 ENTRANCE FLOOR PLAN - DEMO

SCALE: 1/4"=1'-0"


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PLAN
NORTH

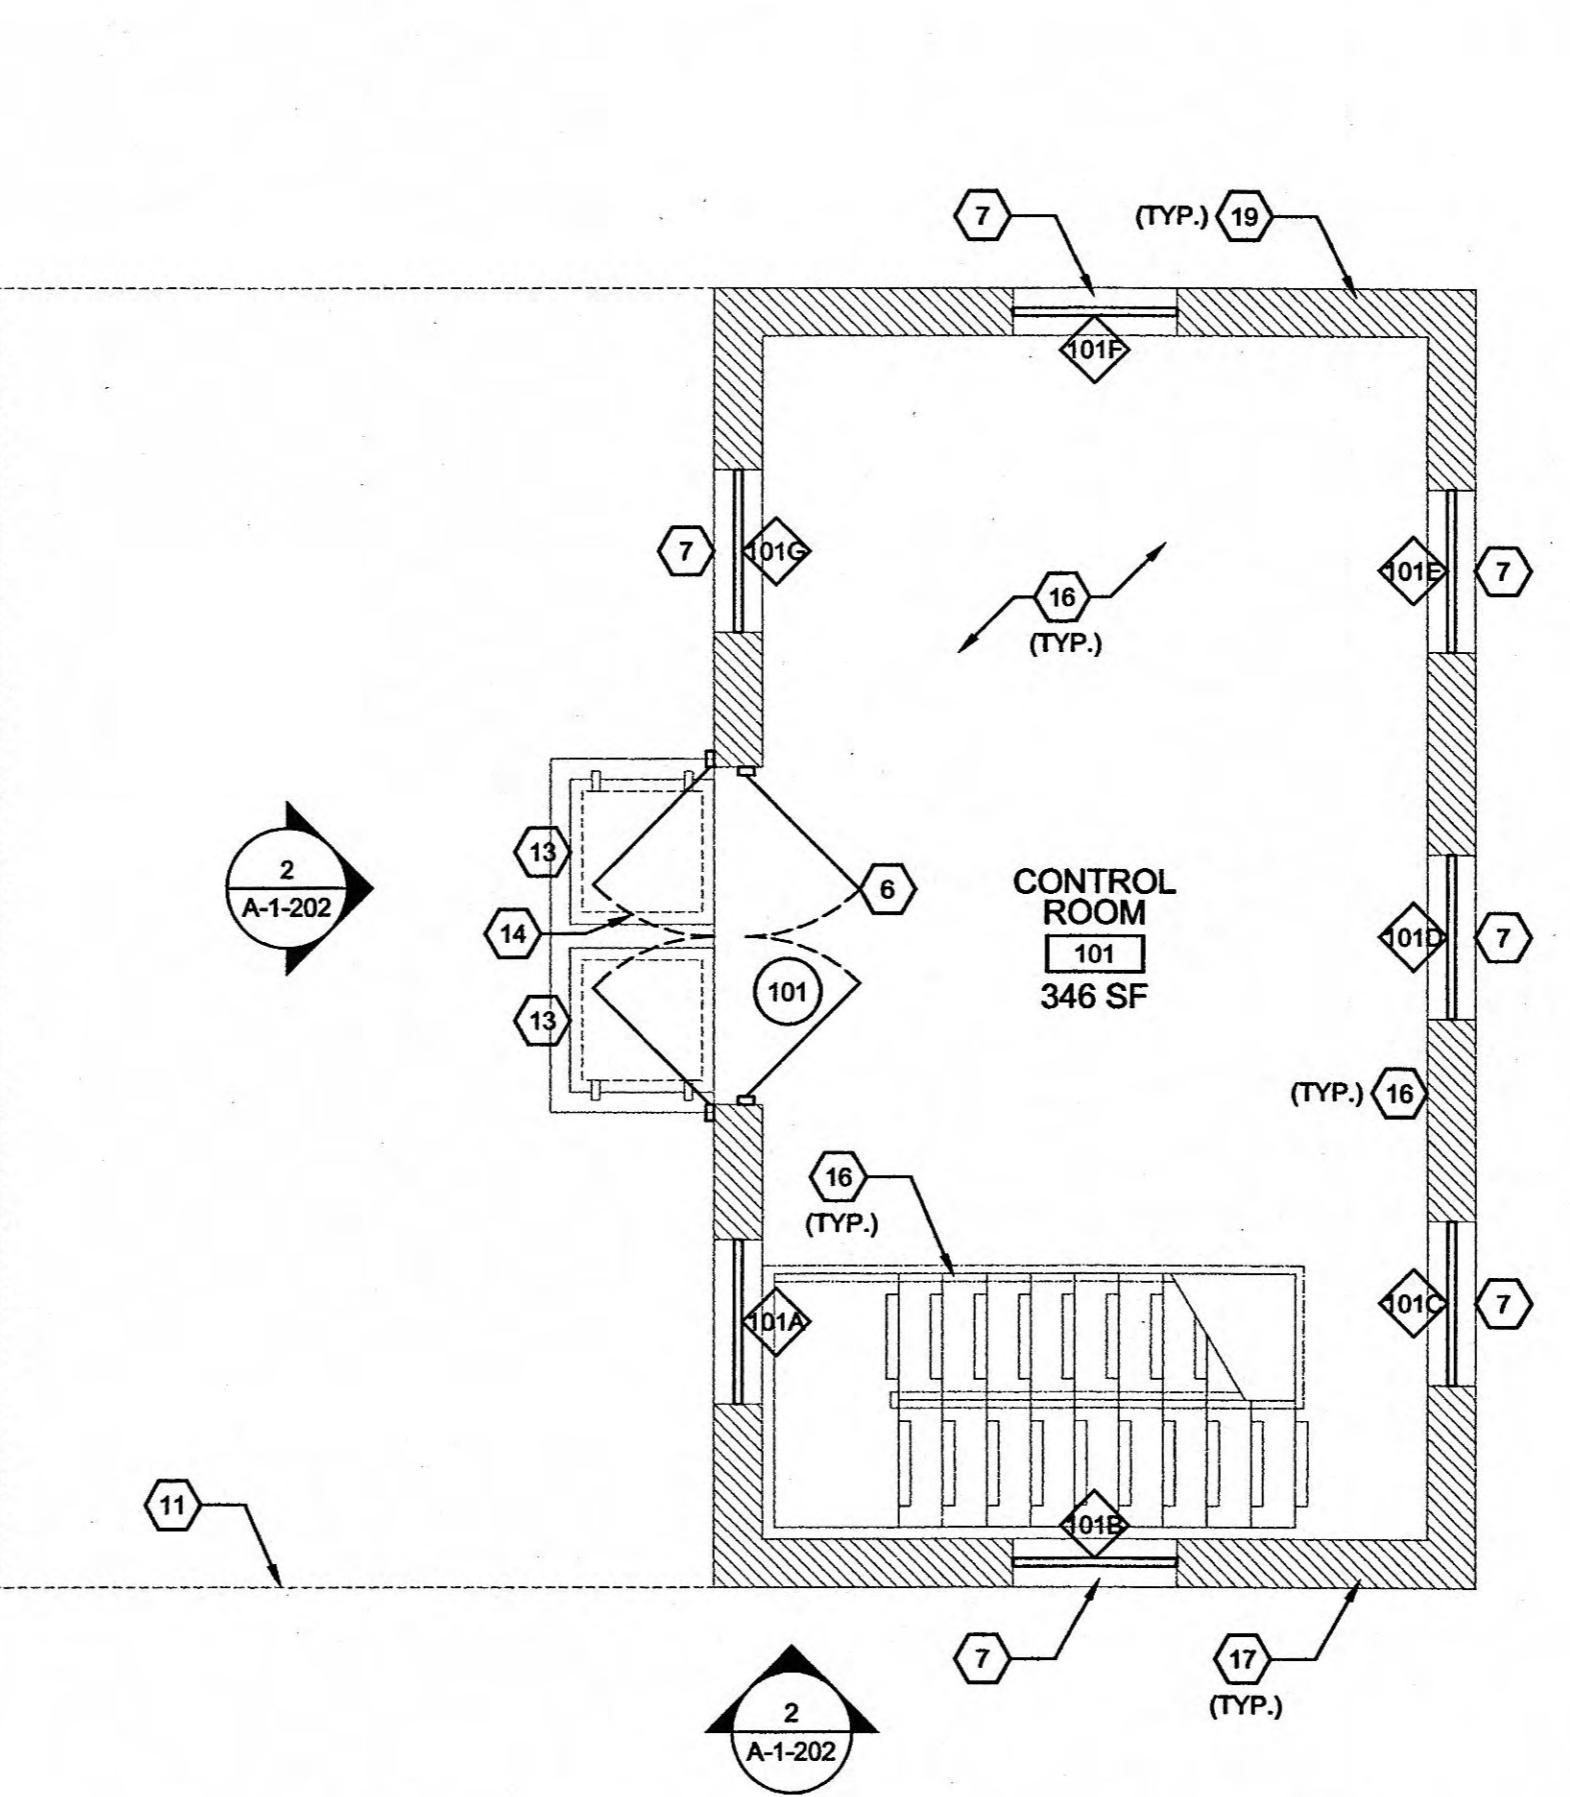2 ENTRANCE FLOOR PLAN - UPGRADE

SCALE: 1/4"=1'-0"

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PLAN
NORTH

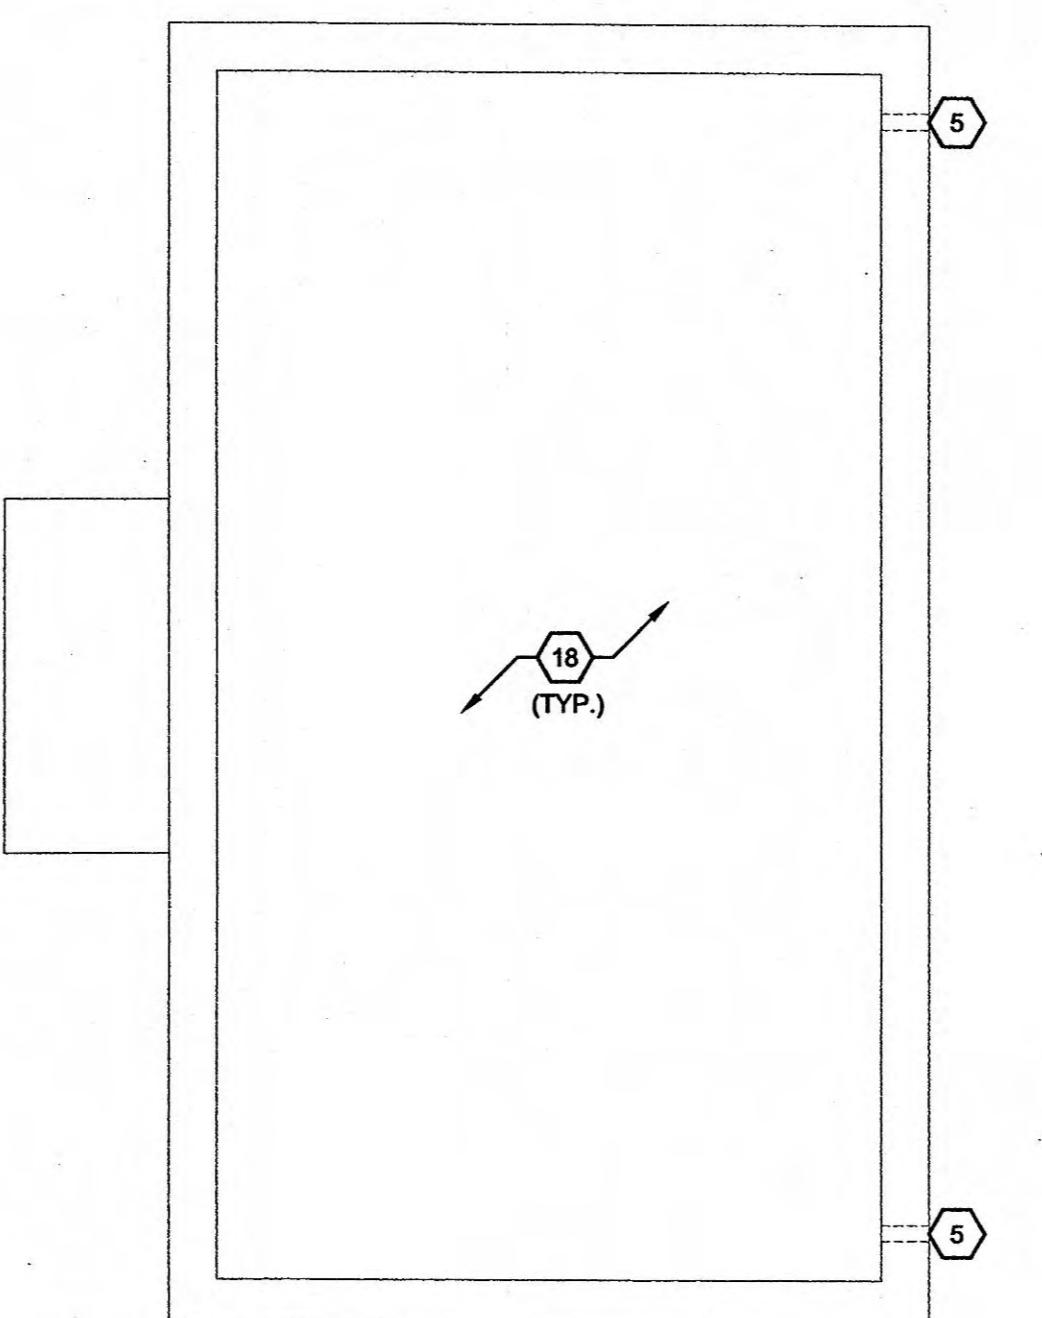3 ROOF PLAN - DEMO

SCALE: 1/4"=1'-0"


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PLAN
NORTH

4 ROOF PLAN - UPGRADE

SCALE: 1/4"=1'-0"

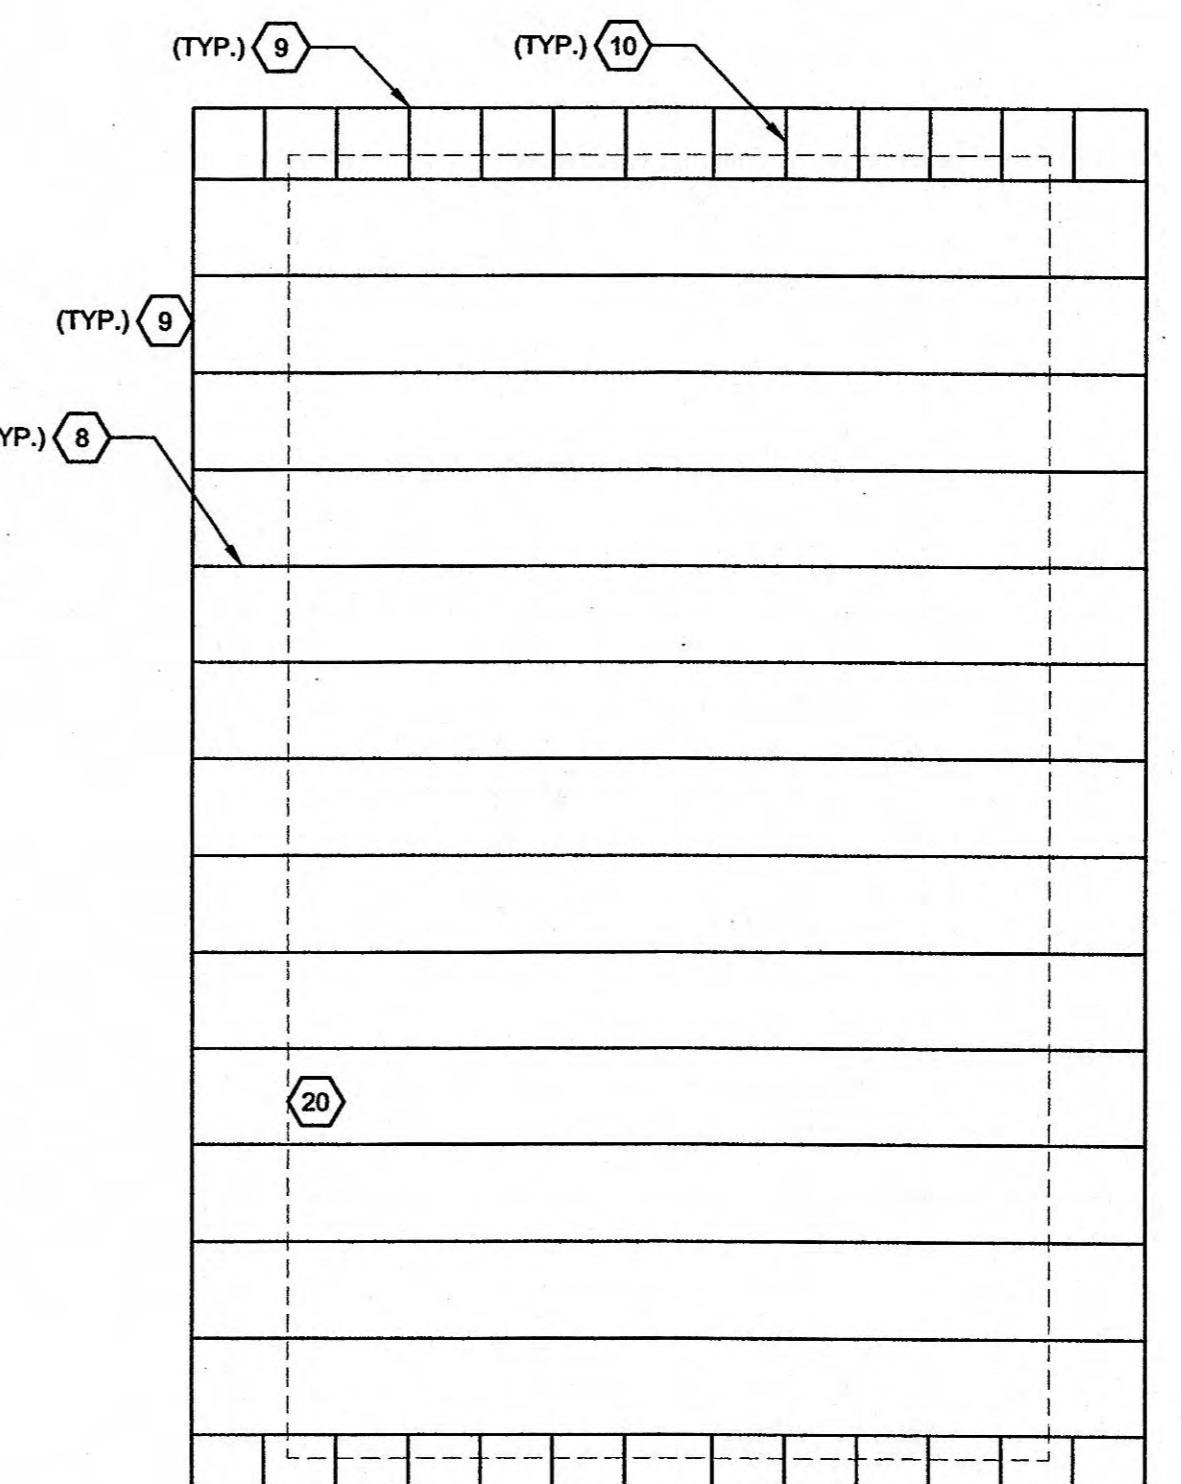0 2' 4' 8'



- GENERAL NOTES:**
- DOORS & WINDOWS ARE SHOWN FOR REFERENCE PURPOSES ONLY, SEE WINDOW & DOOR SCHEDULE FOR ACTUAL SIZES.
 - SEE ARCHITECTURAL GENERAL SHEET A-0-001 FOR TYPICAL WALL TYPE DESCRIPTIONS.
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SYMBOL KEY:

- SEE SHEET A-0-001 FOR TYPICAL ARCHITECTURAL SYMBOLS

KEYNOTES:

- EXISTING BRICK COMPOSITE WALL - REMOVE BRICK AT LOCATIONS DESIGNATED FOR NEW LOUVER OPENINGS - SEE MECHANICAL.
- REMOVE EXISTING DOOR PANELS, DOOR FRAME, TRANSOM, AND DOOR THRESHOLD.
- REMOVE EXISTING WINDOWS - SANDBLAST ALL SILLS AND LINTELS BEFORE INSTALLATION OF NEW WINDOWS.
- EXISTING STAIR AND RAILING TO REMAIN.
- REMOVE EXISTING SCUPPERS.
- PROVIDE NEW FRP DOOR PANELS, TRANSOM, AND DOOR FRAME - FIELD VERIFY WALL OPENING - PATCH EXISTING OPENING AS REQUIRED TO RECEIVE NEW DOOR.
- PROVIDE NEW FRP WINDOWS - PATCH OPENING AS REQUIRED TO RECEIVE NEW WINDOWS.
- PROVIDE PRE-ENGINEERED WOOD TRUSS ROOF FRAMING SYSTEM @ 24" O.C. - SEE SPEC SECTION.
- PROVIDE WOOD BLOCKING FASCIA.
- PROVIDE NOMINAL 2x4 OUTLOOKER @ 18" O.C.
- CONCRETE BASIN BELOW.
- REMOVE EXISTING STEEL PLATE DOORS.
- PROVIDE NEW WATERTIGHT ALUMINUM ACCESS DOORS - SEE DETAIL 1/A-1-601 AND SPECIFICATION 083650.
- PROVIDE NEW FLOOD BARRIER - SEE DETAIL 17/A-1-301 AND SPECIFICATION 083950.
- SANDBLAST EXISTING INTERIOR WALLS, STAIRS, RAILINGS, STEEL, AND CEILINGS AT ALL LEVELS - PREP FOR PAINTING.
- PAINT INTERIOR WALLS, STAIRS, RAILINGS, STEEL, FLOORS, AND CEILINGS AT ALL LEVELS - SEE SPECIFICATION 099611.
- EXISTING EXTERIOR WALLS TO BE CLEANED AND SEALER APPLIED - SEE SPECIFICATION SECTIONS 049010 & 071900.
- REMOVE EXISTING ROOFING MATERIAL DOWN TO EXISTING CONCRETE ROOF DECK - PATCH AND LEVEL AS REQUIRED FOR NEW ROOF INSTALLATION.
- REPOINT ALL CRACKS IN MORTAR JOINTS, AND PATCH HOLES WHERE EQUIPMENT, SCUPPERS, OR PIPING HAS BEEN REMOVED.
- EXISTING BUILDING OUTLINE BELOW.

**EXISTING LADD PUMP STATION
DEMOLITION AND UPGRADE FLOOR PLANS I**

PUMP STATION REHABILITATION
CITY OF HARRIMAN, TENNESSEE

REVISIONS	DESIGNED	DATE	BY	DRAWN	REVISED	APPROVED
No.	TMCH			TMCH		BSL
Description						

THIS MARK SHOULD MEASURE EXACTLY WHEN PLOTTED

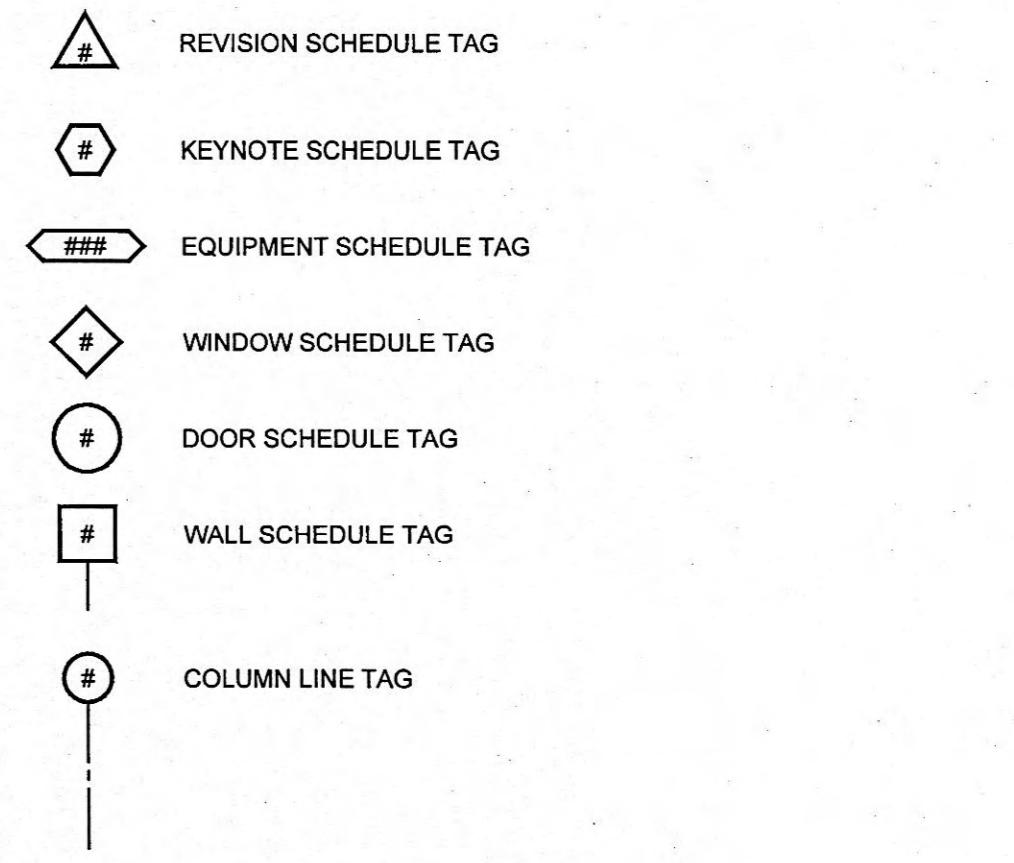
DATE: DECEMBER 2012
SCALE: 1/4" = 1'-0"
SHEET NO. _____

A-1-101

GENERAL ARCHITECTURAL NOTES:

1. CONTRACTOR AND SUB-CONTRACTORS TO VERIFY ALL DIMENSIONS IN THE FIELD PRIOR TO BEGINNING CONSTRUCTION OR ORDERING MATERIALS
2. EACH TRADE SHALL BE RESPONSIBLE FOR COORDINATING AND SEQUENCING ALL WORK WITH OTHER TRADES
3. CONTRACTOR SHALL PROVIDE ALL FURNISHINGS AND OTHER BUILDING COMPONENTS UNLESS NOTED OTHERWISE

ARCHITECTURAL SYMBOL KEY:



APPLICABLE BUILDING & FIRE CODES:

2006 INTERNATIONAL BUILDING CODE (EXCLUDING CHAPTERS 11 & 27)
INTERNATIONAL CODE COUNCIL, INC.
900 MONTCLAIR ROAD
BIRMINGHAM, AL 35213-1206

2006 NFPA 101 LIFE SAFETY CODE
NATIONAL FIRE PROTECTION ASSOCIATION
1 BATTERYMARCH PARK
QUINCY, MA 02269-9101

2006 INTERNATIONAL FIRE CODE
INTERNATIONAL CODE COUNCIL, INC.
900 MONTCLAIR ROAD
BIRMINGHAM, AL 35213-1206

2002 NORTH CAROLINA ACCESSIBILITY CODE WITH THE 2004 AMENDMENTS

CHAPTER 3:
OCCUPANCY TYPE

(U) Utility

CHAPTER 5:
ALLOWABLE BUILDING HEIGHT / ACTUAL BUILDING HEIGHT
ALLOWABLE BUILDING AREA / ACTUAL BUILDING AREA

1 / 1
5,500 SF / 692 SF

CHAPTER 6:
CONSTRUCTION TYPE

V-B (UNPROTECTED)

GENERAL ARCHITECTURAL SHEET NOTES AND SYMBOLS


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**GENERAL ARCHITECTURAL SHEET
NOTES AND SYMBOLS**


PUMP STATION REHABILITATION
CITY OF HARRIMAN, TENNESSEE

DESIGNED:	REVISIONS
DATE:	DESCRIPTION
DRAWN:	DATE
REVIEWED:	BY
APPROVED:	TMCH
SCALE:	TMCH
FILE NAME: U:\\3947-Harriman Utility\\01-SRF Sewer Rehab\\Working Drawings\\AutoCAD\\3947-01-A-001.dwg	BSL
PRINTED: 12/10/2012 @ 8:40AM	BSL
DATE: DECEMBER 2012	BSL
SCALE: N/A	BSL
SHEET NO.	BSL
THIS MARK SHOULD MEASURE EXACTLY 1' WHEN PLOTTED	BSL
SCALE CHECK	BSL

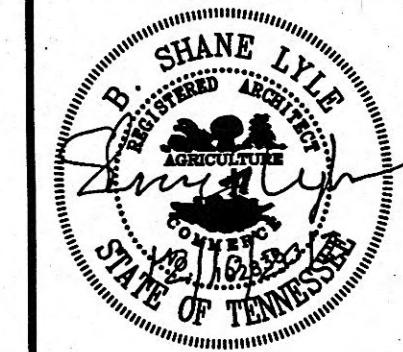A-0-001



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ENTRANCE FLOOR PLAN

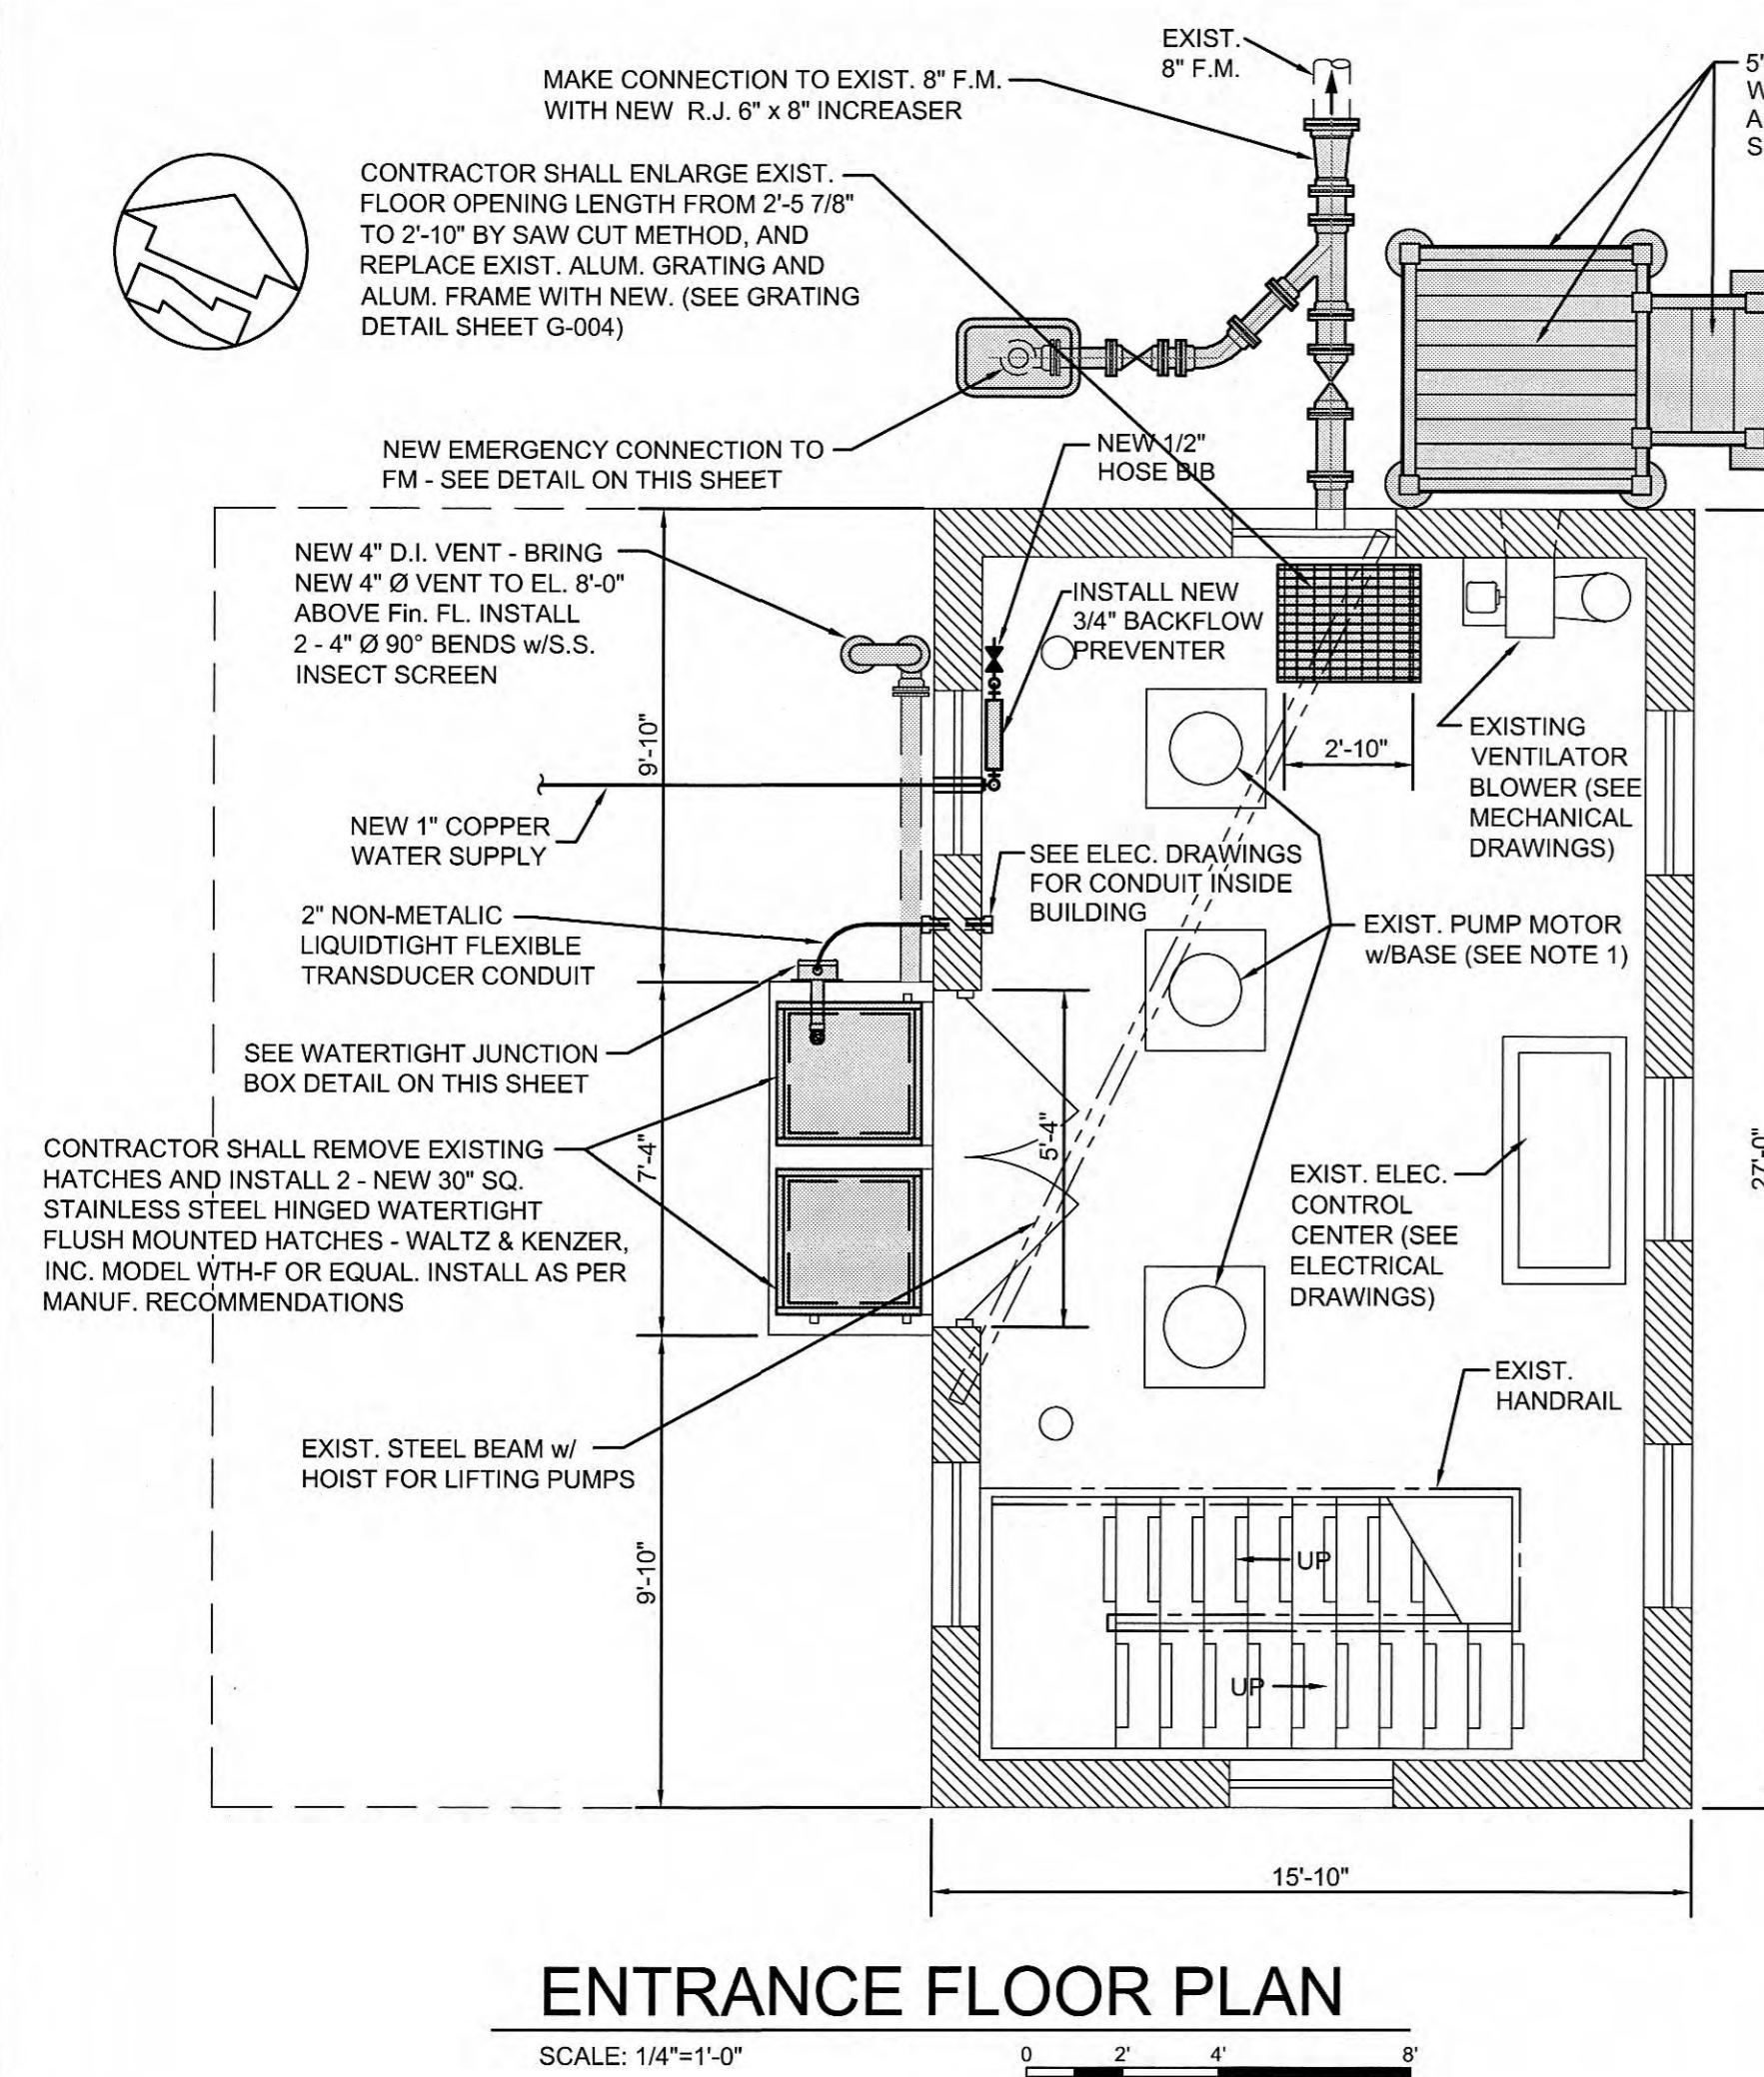
SCALE: 1/4"=1'-0"

UPGRADE LEGEND

- [Shaded Box] INDICATES NEW EQUIPMENT / PIPING
- [Hatched Box] INDICATES EXISTING CONC. STRUCTURE
- [White Box] INDICATES EXISTING EQUIPMENT / PIPING TO REMAIN

PUMP ROOM PLAN

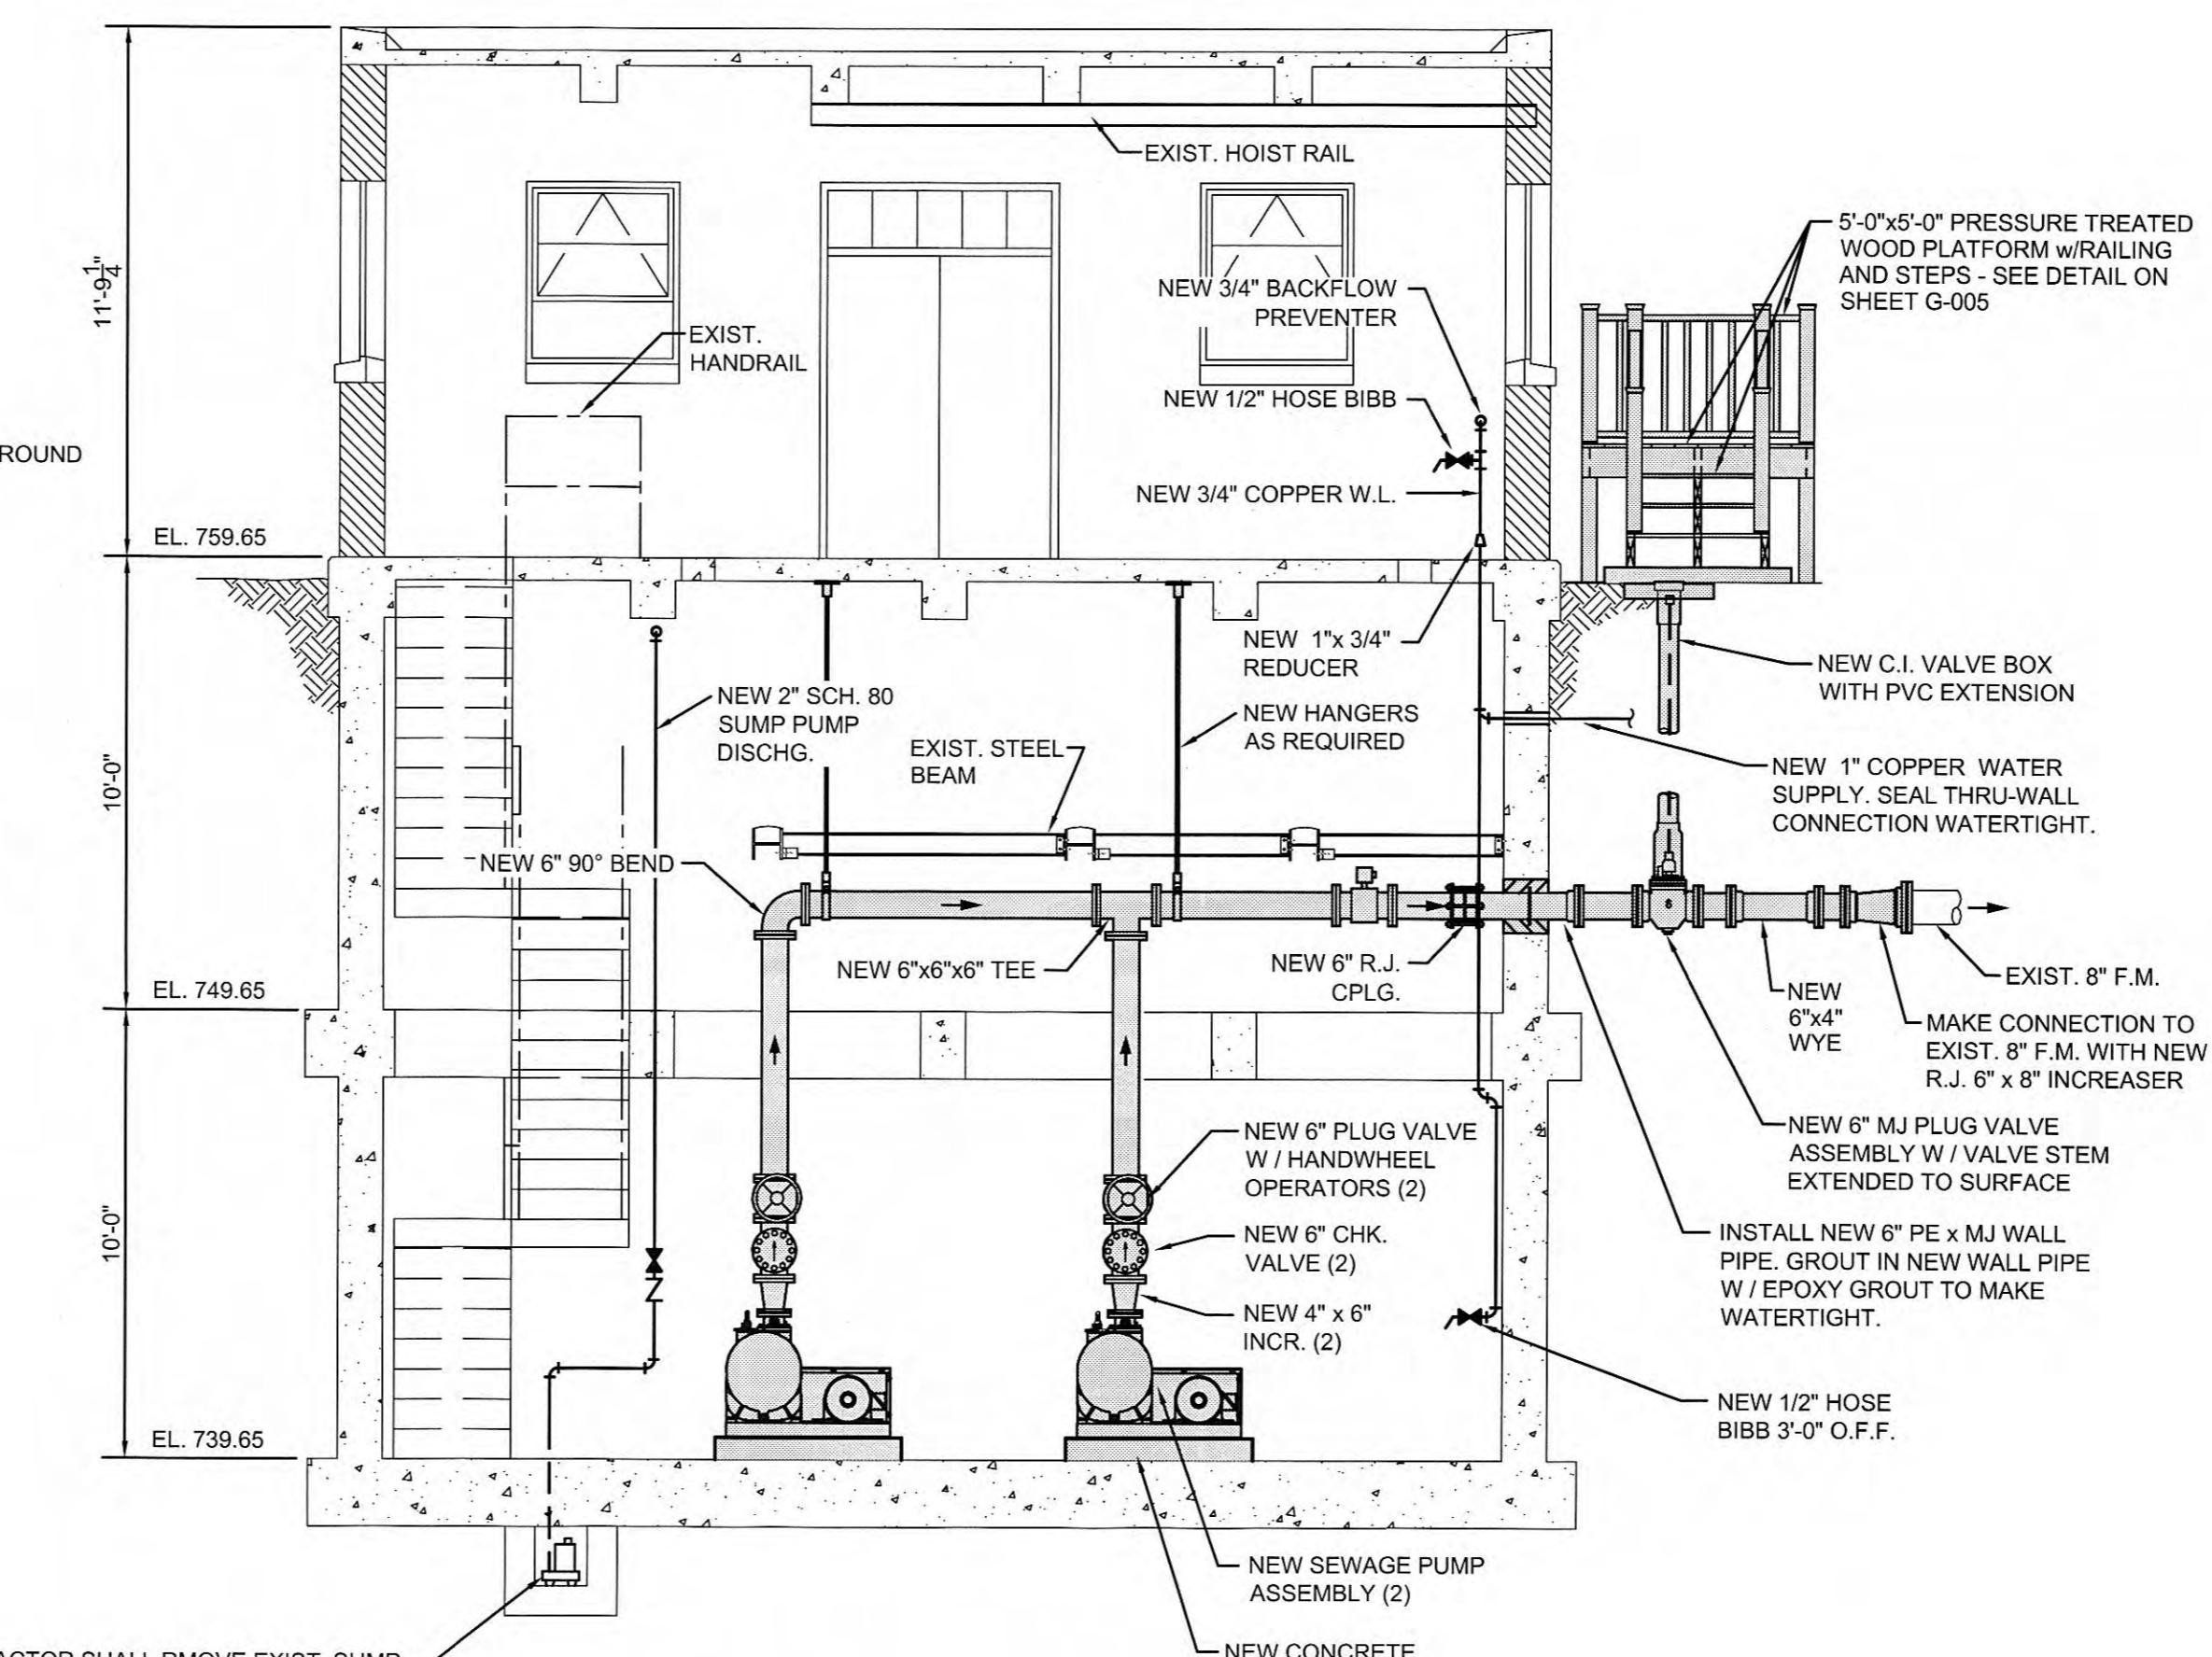SCALE: 1/4"=1'-0"



SECTION VIEW

1

SECTION VIEW

SCALE: 1/4"=1'-0"

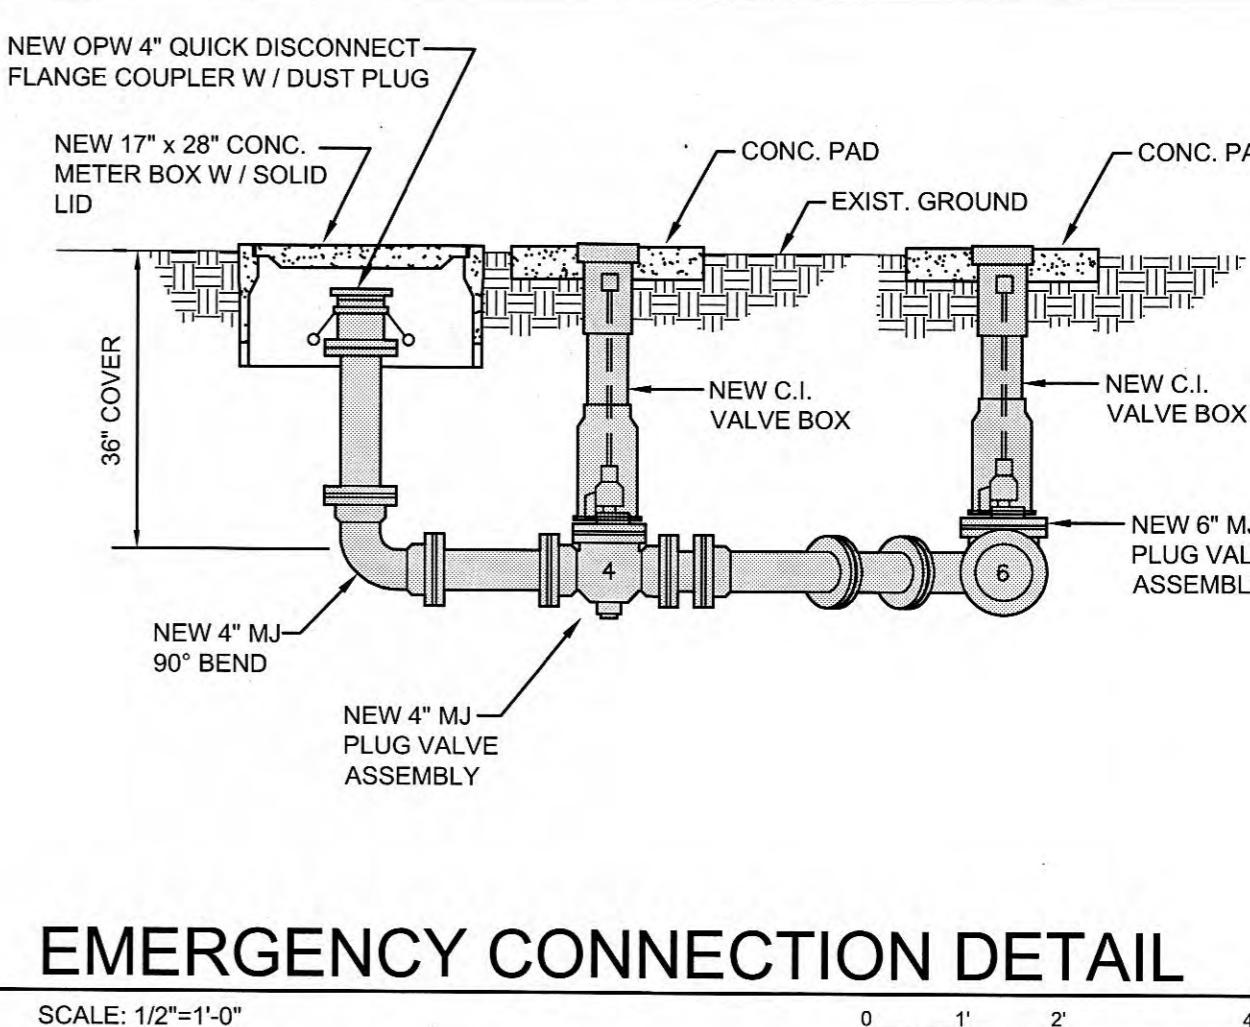
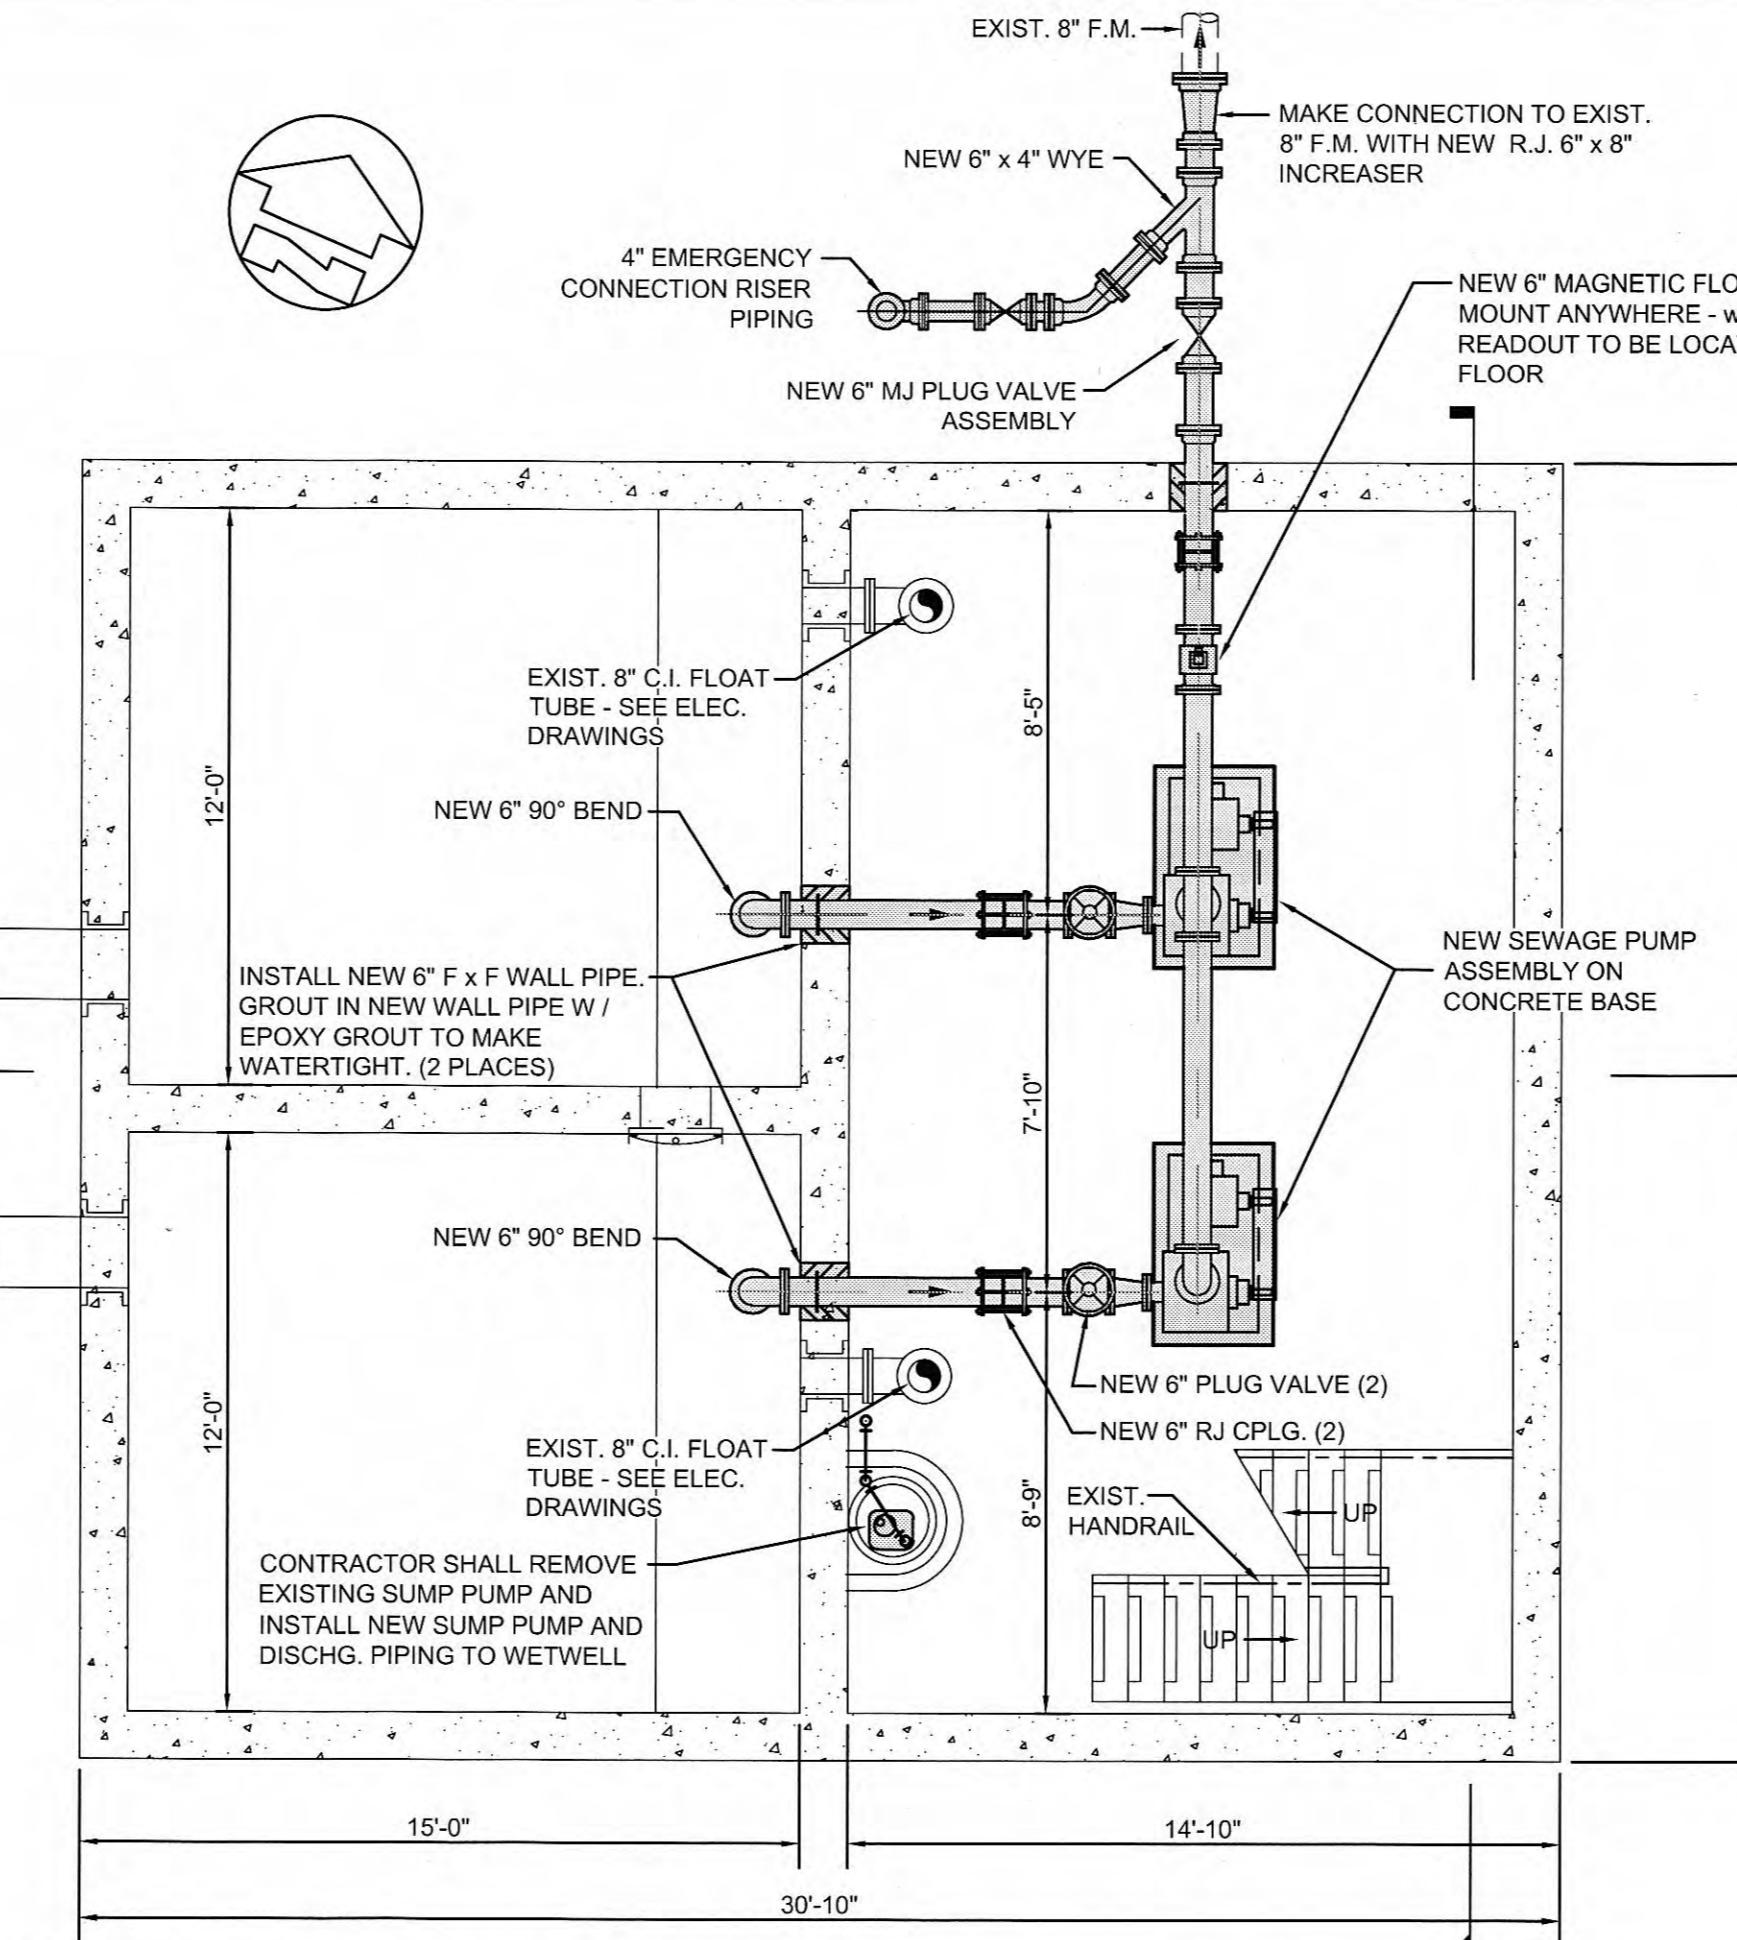
2

SECTION VIEW

SCALE: 1/4"=1'-0"

SECTION VIEW

SCALE: 1/4"=1'-0"



EMERGENCY CONNECTION DETAIL

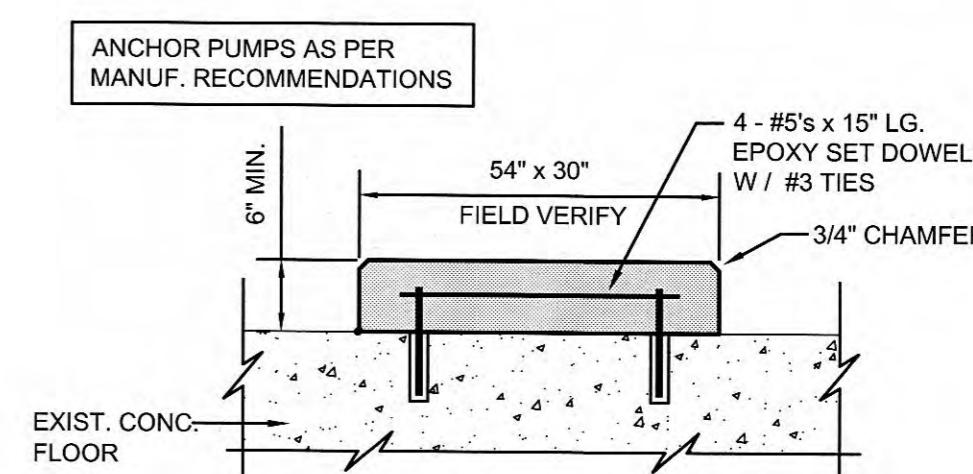
SCALE: 1/2"=1'-0"

0 1' 2' 4'

VALVE SUPPORT DETAIL

SCALE: 3/4"=1'-0"


0 1' 2' 3'



PUMP BASE DETAIL

SCALE: 3/4"=1'-0"

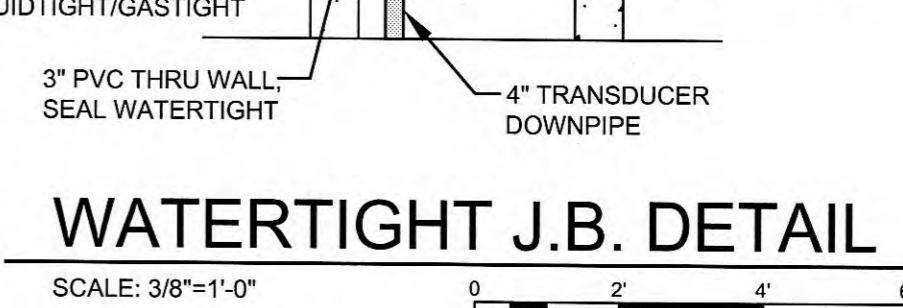0 1' 2' 3'



WATERTIGHT J.B. DETAIL

SCALE: 3/8"=1'-0"

0 2' 4' 6'

NOTES:


- ① CONTRACTOR SHALL REMOVE EXISTING SEWAGE PUMPS, PIPING, VALVES, BASE SLABS, AND PIERS.
- ② CONTRACTOR SHALL PATCH, CLEAN AND SEAL FLOORS AFTER REMOVAL OF PUMP MOTORS AND BASE PLATES.
- ③ CONTRACTOR SHALL REMOVE EXISTING WALL SLEEVE AND GROUT OPENING TO MAKE WATERTIGHT.
- ④ SEE ARCHITECTURAL DRAWINGS FOR MODIFICATIONS TO EXISTING PUMP STATION BUILDING.
- ⑤ FIELD LOCATE NEW SEWAGE PUMPS SO AS TO NOT INTERFERE WITH THE OPERATION OF THE EXISTING FLOOR DRAINS.
- ⑥ ALL EMERGENCY CONNECTION PIPING AND CONNECTION TO EXISTING F.M. SHALL BE RESTRAINED JOINT.

EXISTING LADD PUMP STATION
NEW EQUIPMENT, PLAN & SECTIONSPUMP STATION REHABILITATION
CITY OF HARRIMAN, TENNESSEE


GRW PROJECT NO. 3947-01	CLIENT PROJECT NO.
ALL RIGHTS RESERVED. PROPERTY OF GRW ENGINEERS, INC. AND SHALL NOT BE COPIED OR USED FOR ANY PURPOSE OTHER THAN THAT THIS SPECIFIC PROJECT	
RECORDED BY ROBERT G. THREADELL, STATE OF TENNESSEE, NO. 012645 1/11/2013	
www.grwinc.com	

DESIGNED	RGT
DRAWN	CJSH
REVIEWED	RGT
APPROVED	RGT
REVISED	
DESCRIPTION	
DATE	
BY	
SCALE	
NOTE	
FILE NAME: I:\\3947-Harriman Utility\\01-SRF Sewer Rehab\\Working Drawings\\Design Drawings\\Cen S12-01_Pump Station\\3947-01-C-1-104.dwg	THIS MARK SHOULD MEASURE EXACTLY 1' WHEN FLATTENED
DATE: DECEMBER 2012	SCALE:
AS NOTED	NOTE:
SHEET NO.	

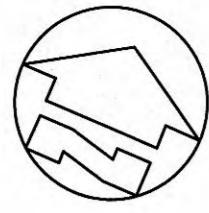C-1-104





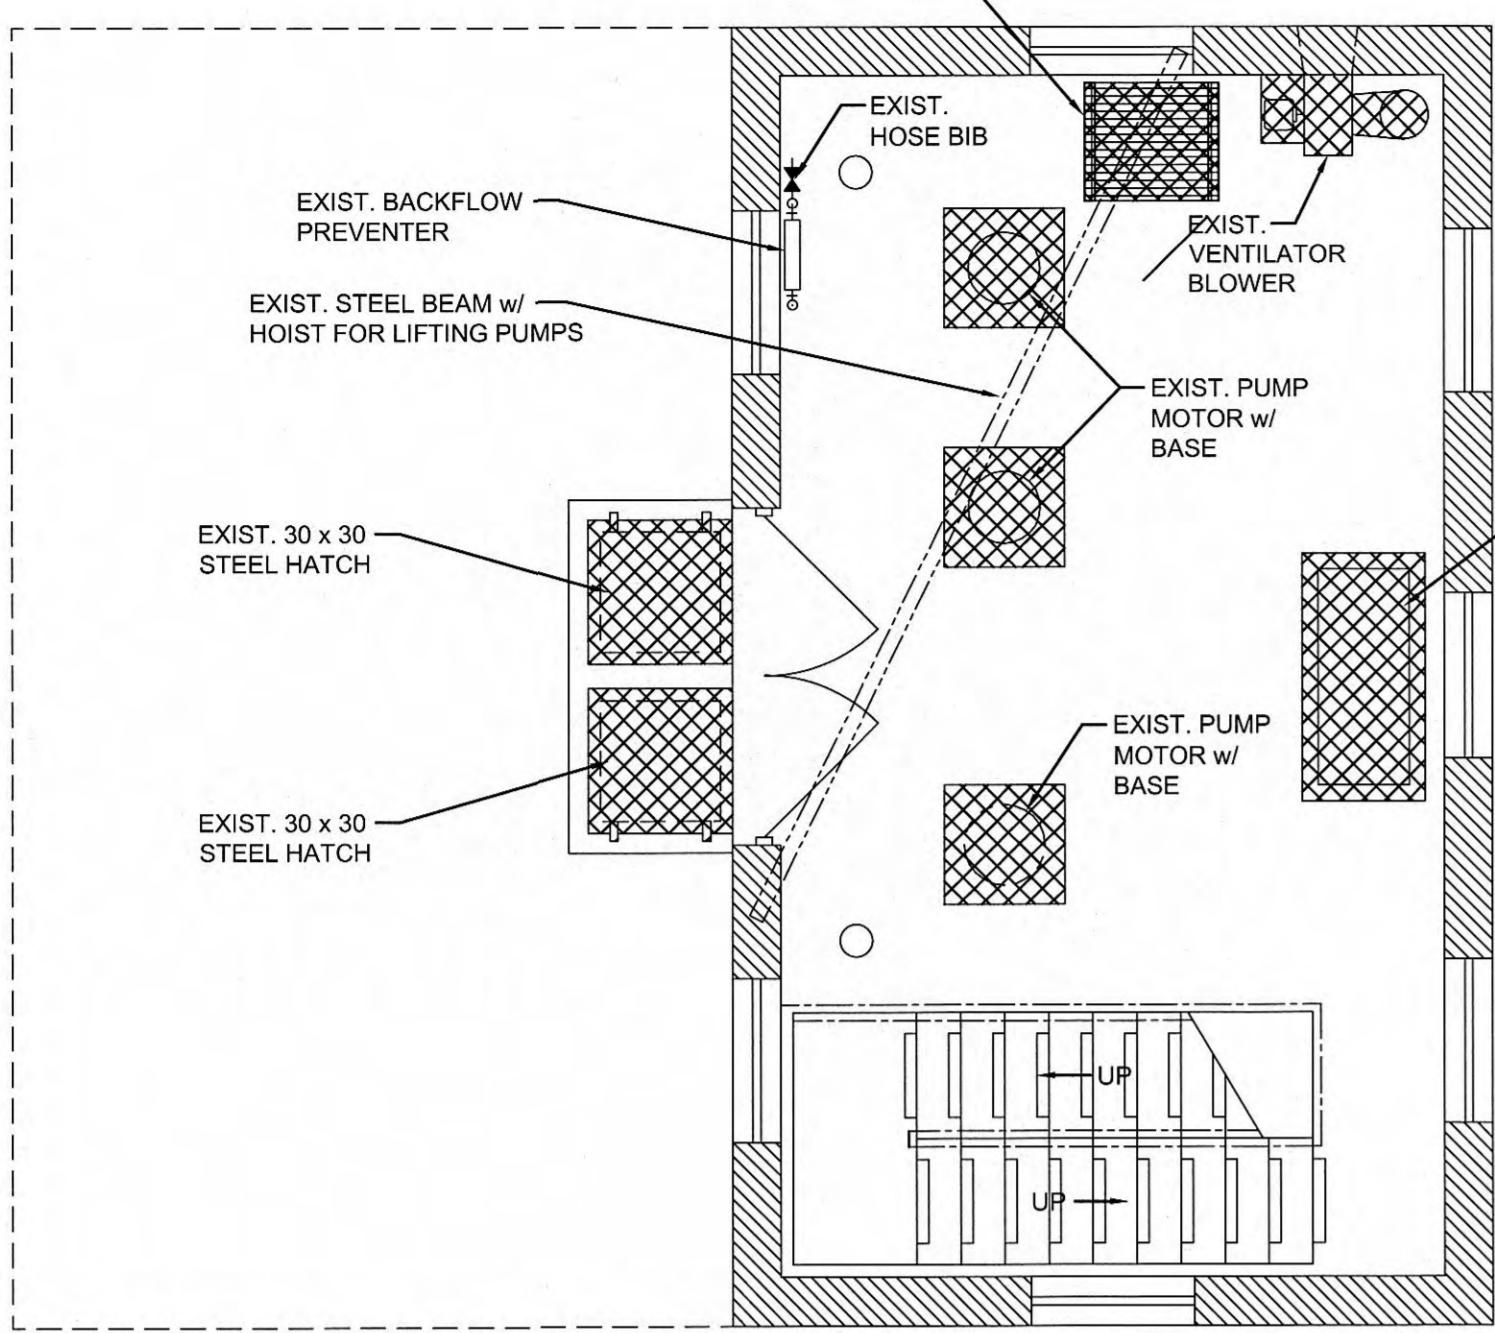EXIST. FLOOR OPENING
TO BE ENLARGED AND
GRATING REPLACED.
(SEE SHEET C-1-104)





ENTRANCE FLOOR PLAN

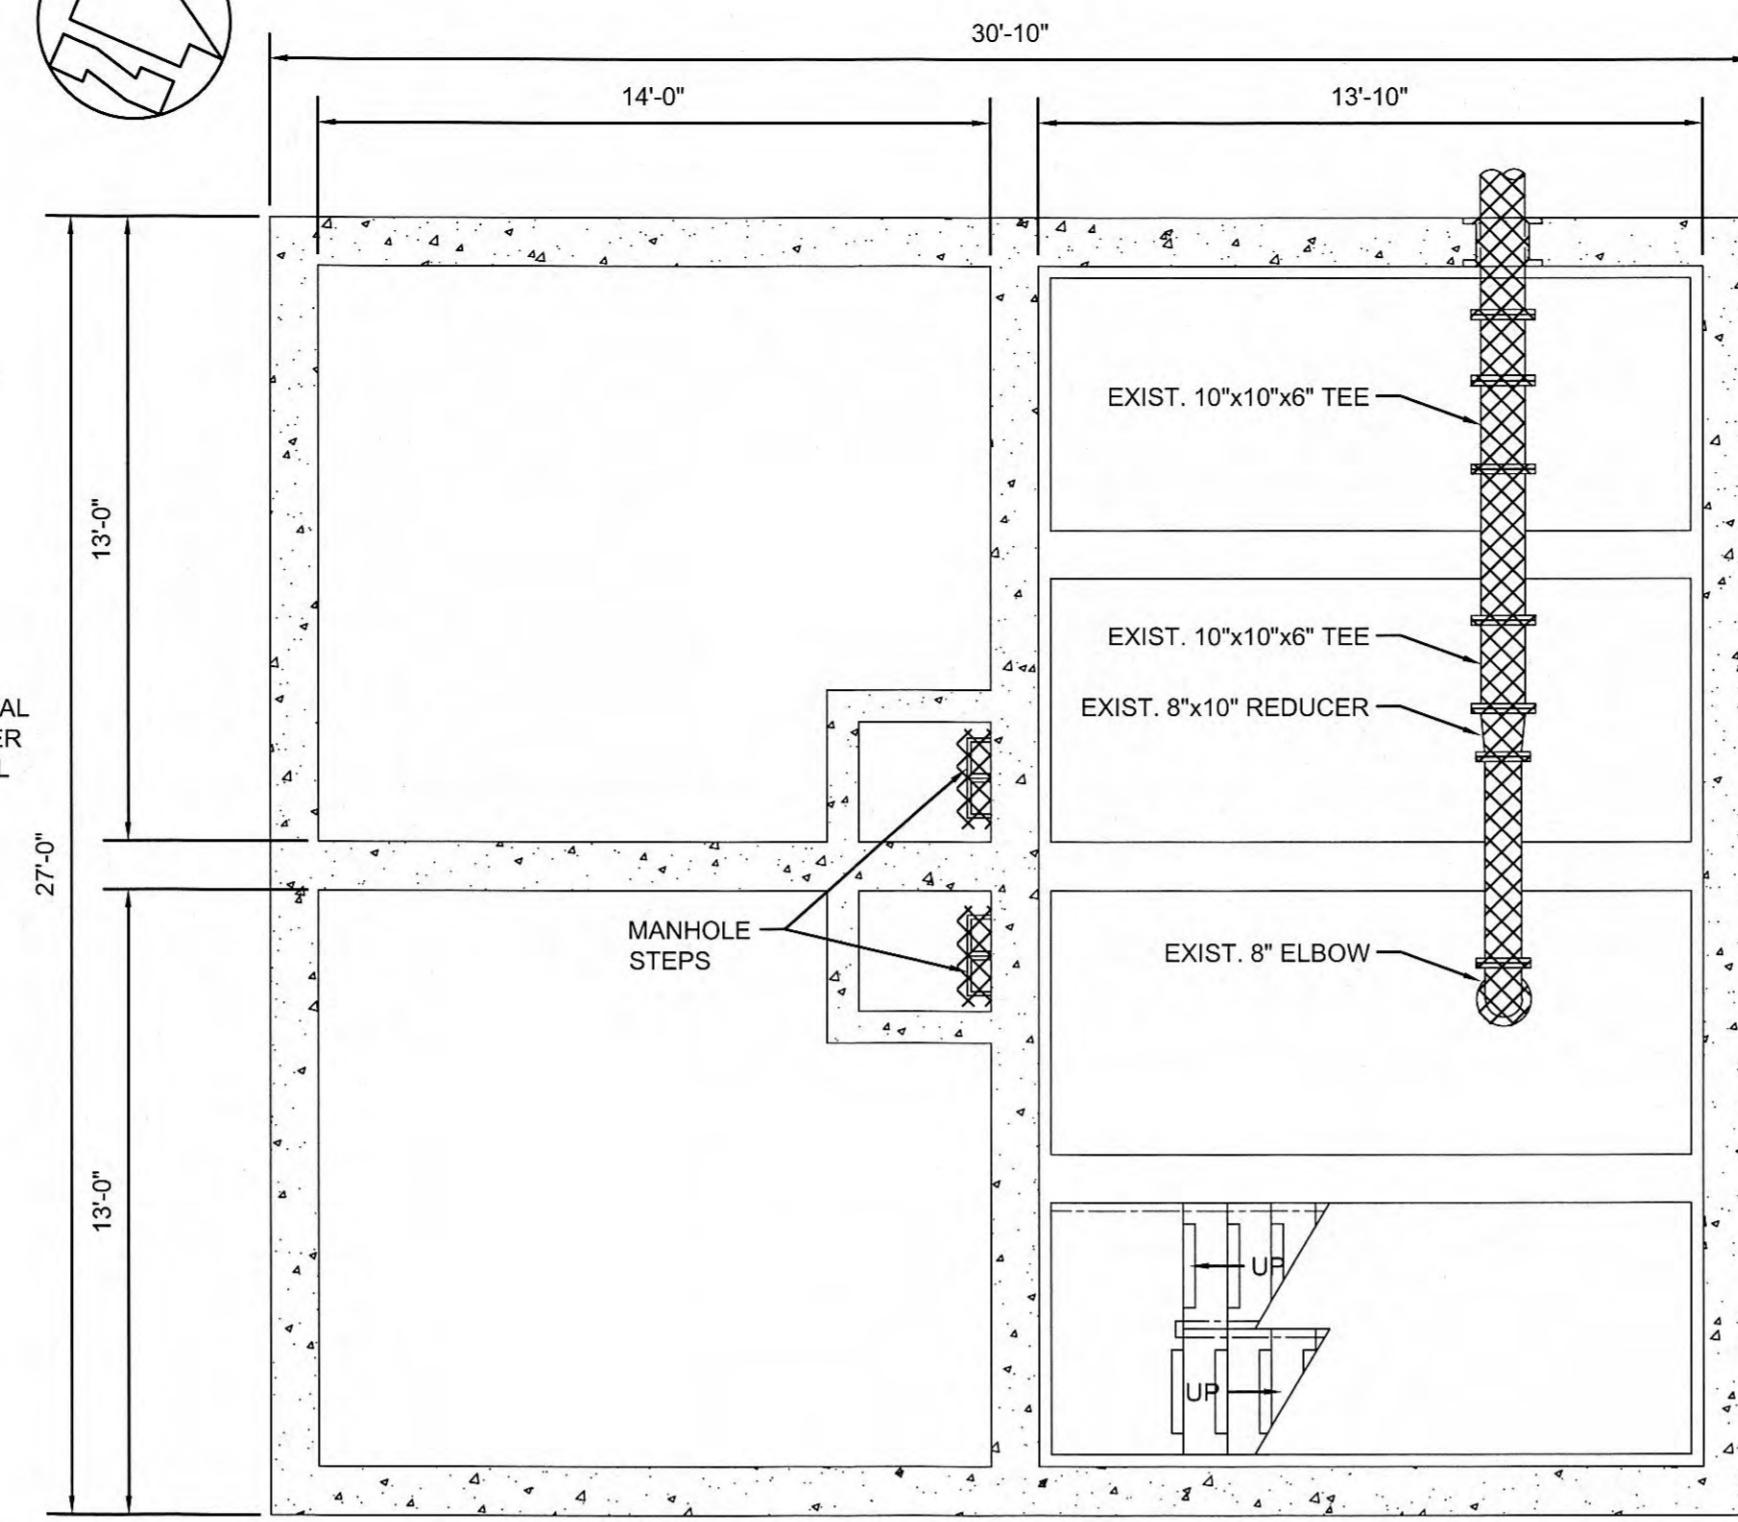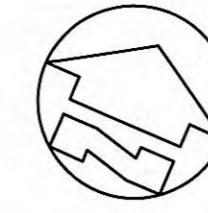SCALE: 1/4"=1'-0"




INTERMEDIATE PLAN

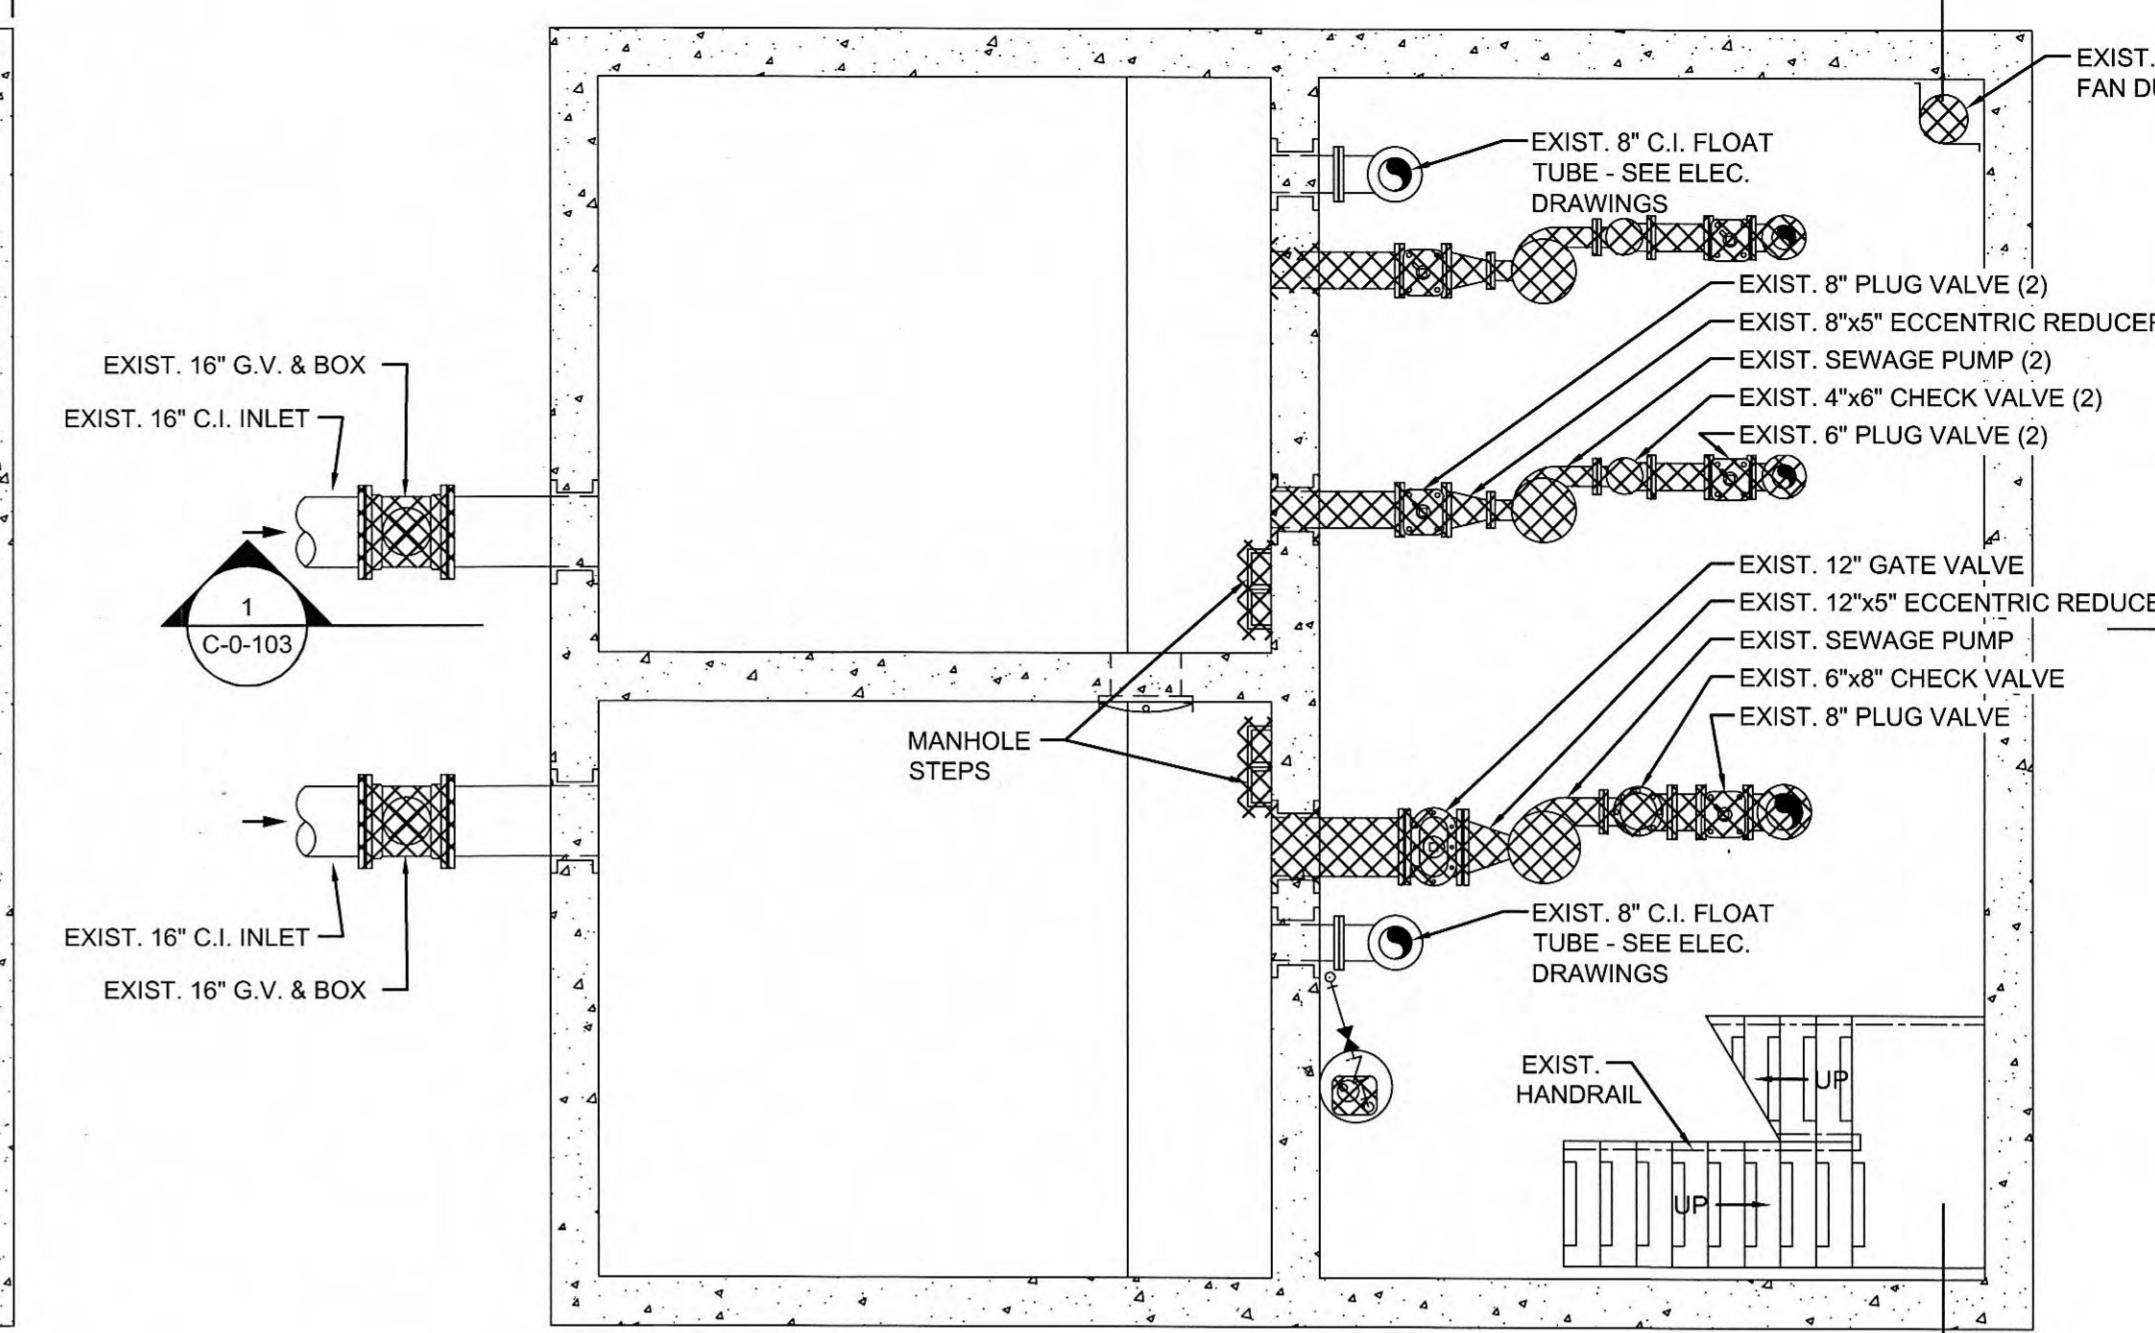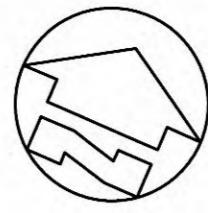SCALE: 1/4"=1'-0"



PUMP ROOM PLAN

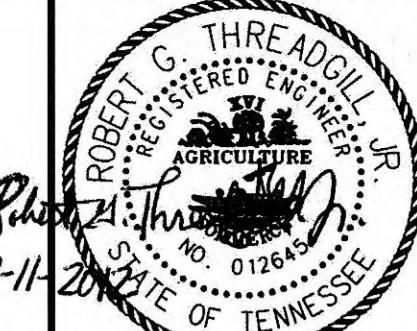SCALE: 1/4"=1'-0"



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EXISTING LADD PUMP STATION DEMOLITION PLAN AND SECTIONS

PUMP STATION REHABILITATION
CITY OF HARRIMAN, TENNESSEE

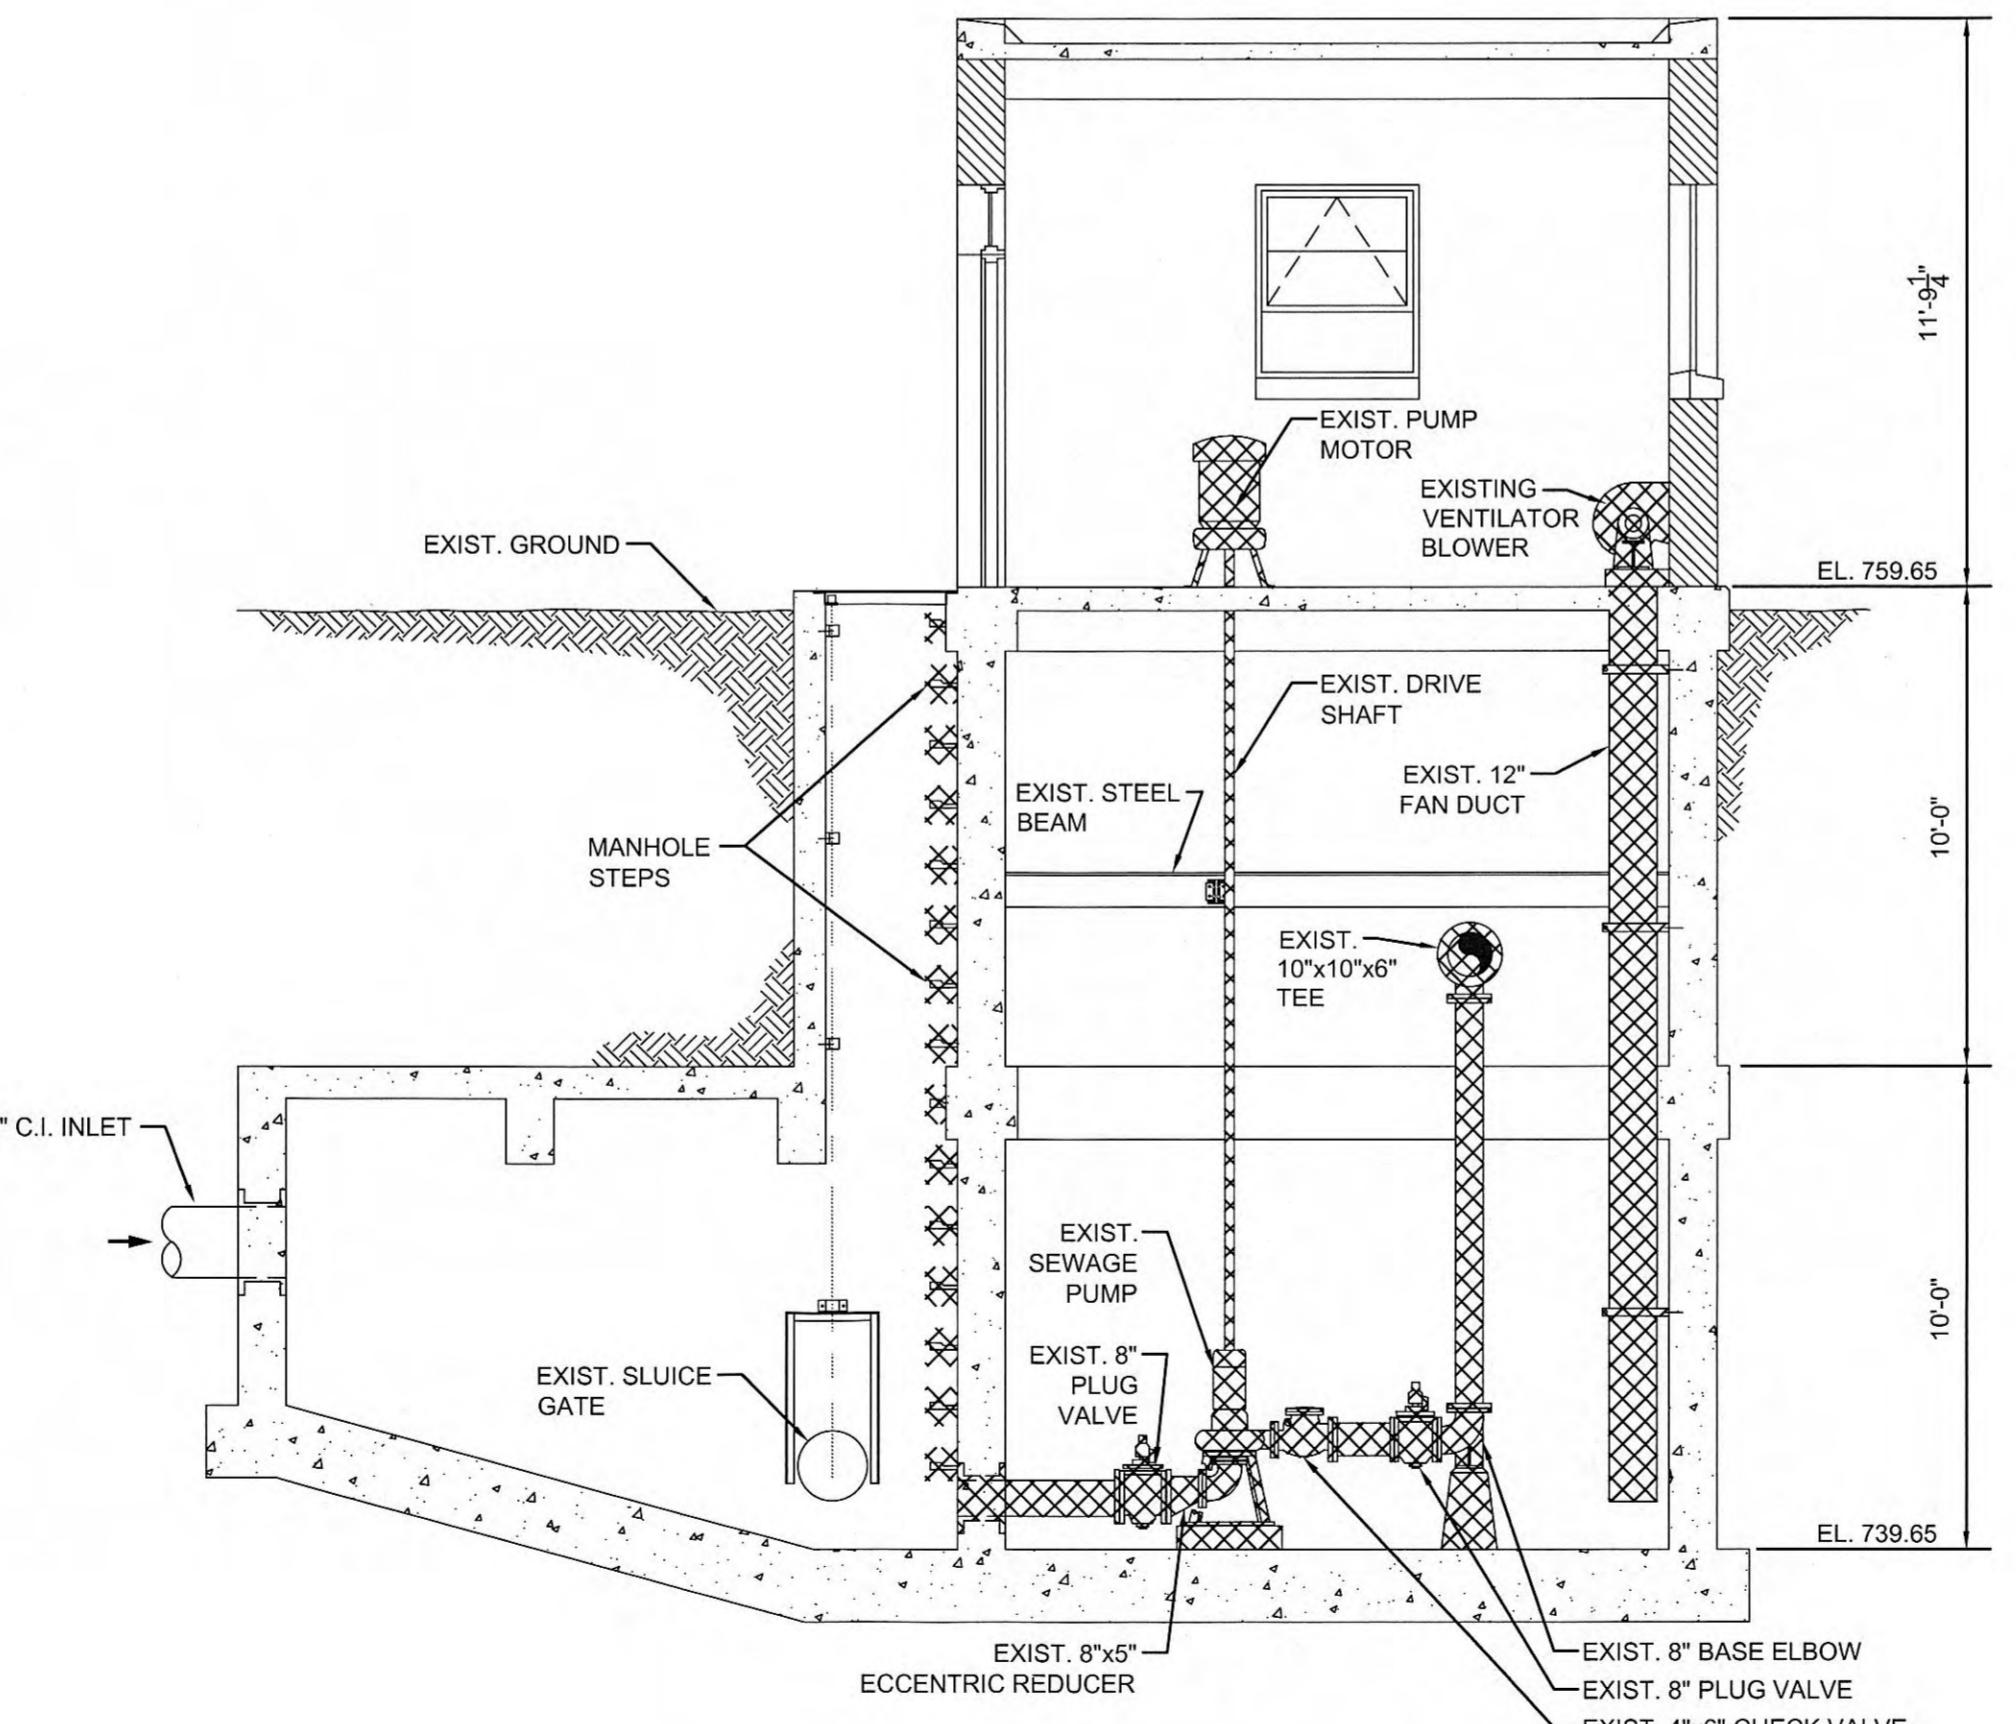
SEE ARCHITECTURAL DRAWINGS
FOR MODIFICATIONS TO EXIST.
PUMP STATION BUILDING.

CONTRACTOR SHALL REMOVE EXISTING
PUMP MOTORS AND STEEL BASE PLATES,
PATCH, CLEAN AND SEAL FLOOR AFTER
REMOVAL OF MOTORS AND PLATES.

CONTRACTOR SHALL REMOVE
EXISTING SEWAGE PUMPS,
PIPING, VALVES, BASE SLABS
AND PIERS.


DEMO LEGEND

- [Cross-hatched box] INDICATES EQUIPMENT /
PIPING TO BE REMOVED
- [Solid box] INDICATES EXISTING CONC.
STRUCTURE
- [Empty box] INDICATES EXISTING
EQUIPMENT / PIPING TO REMAIN



SECTION VIEW 1

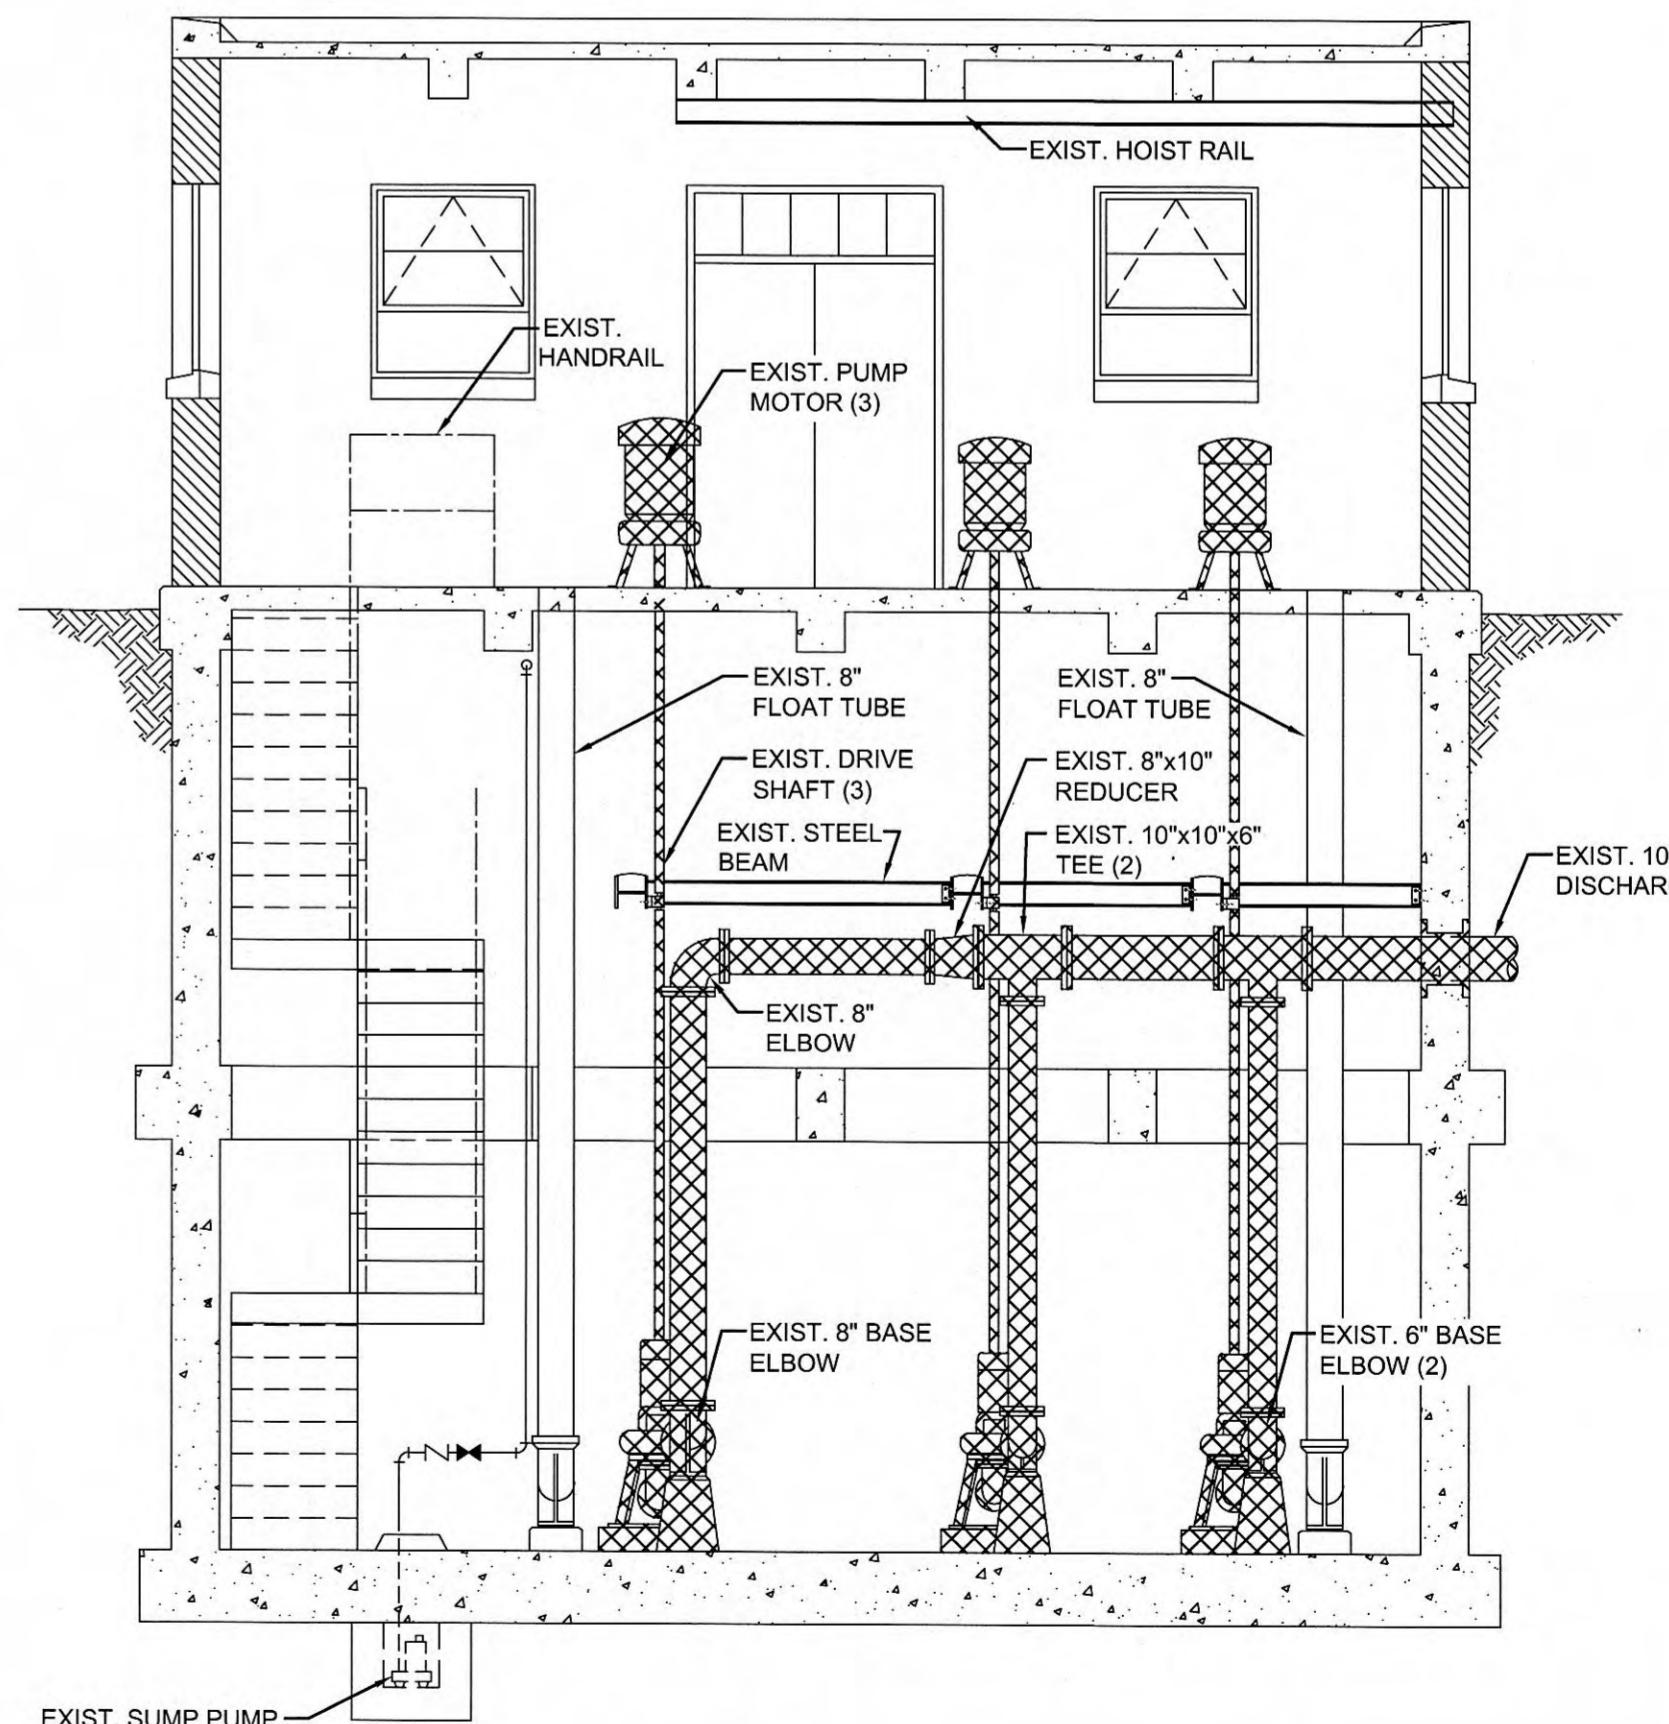SCALE: 1/4"=1'-0"



SECTION VIEW 2

SCALE: 1/4"=1'-0"

REVISIONS	DESCRIPTION	DESIGNED BY	DRAWN BY	REVIEWED BY	APPROVED BY
NO.:		RGT	CJSH	RGT	RGT

DATE:




DECEMBER 2012

SCALE:

AS NOTED

SHEET NO.:

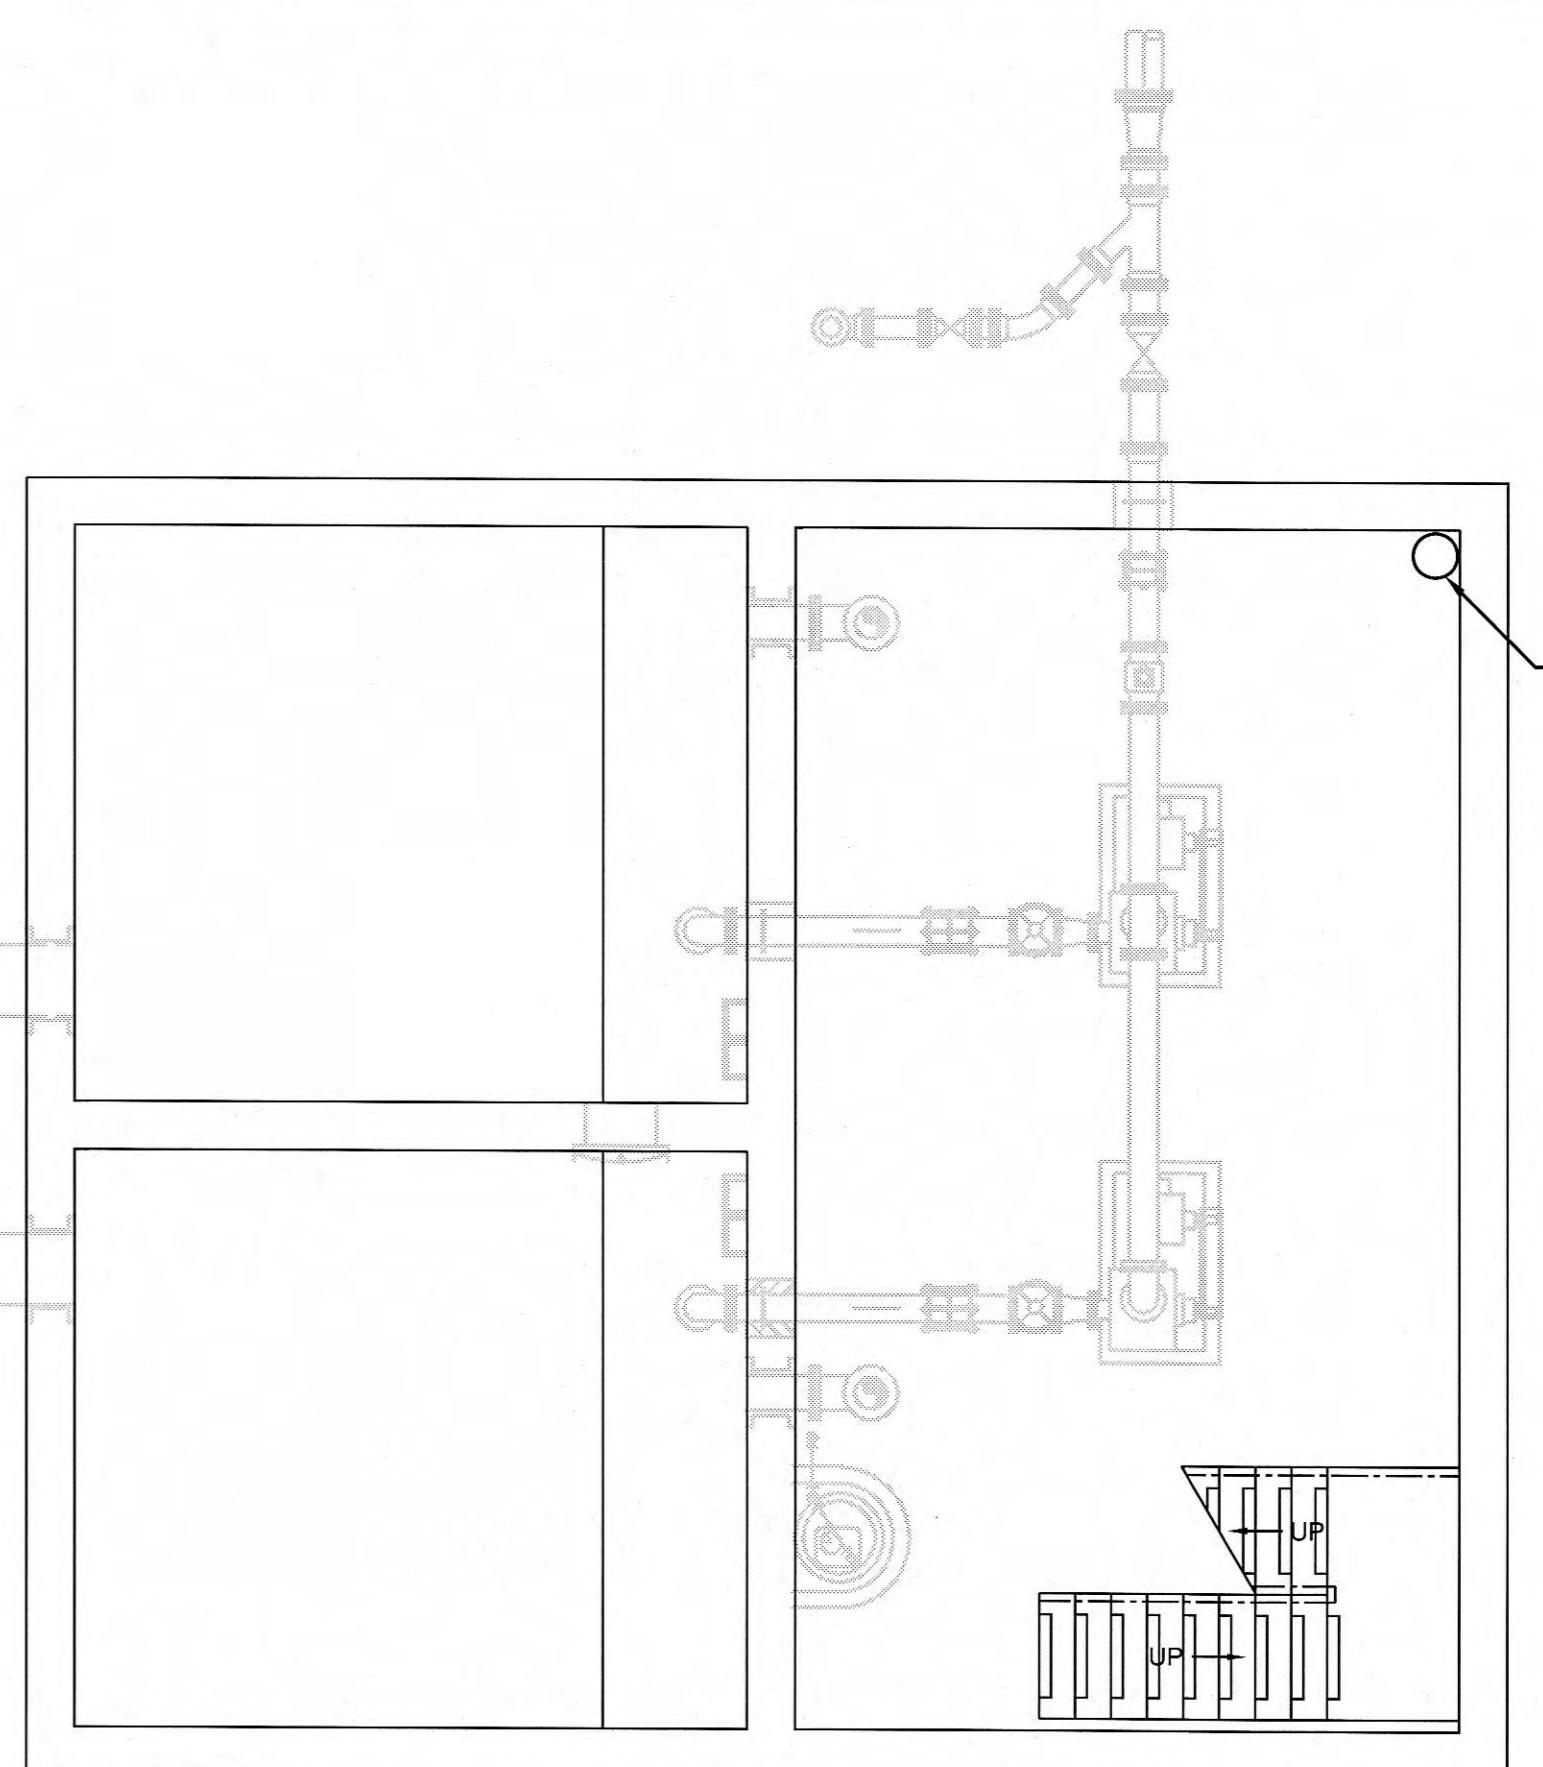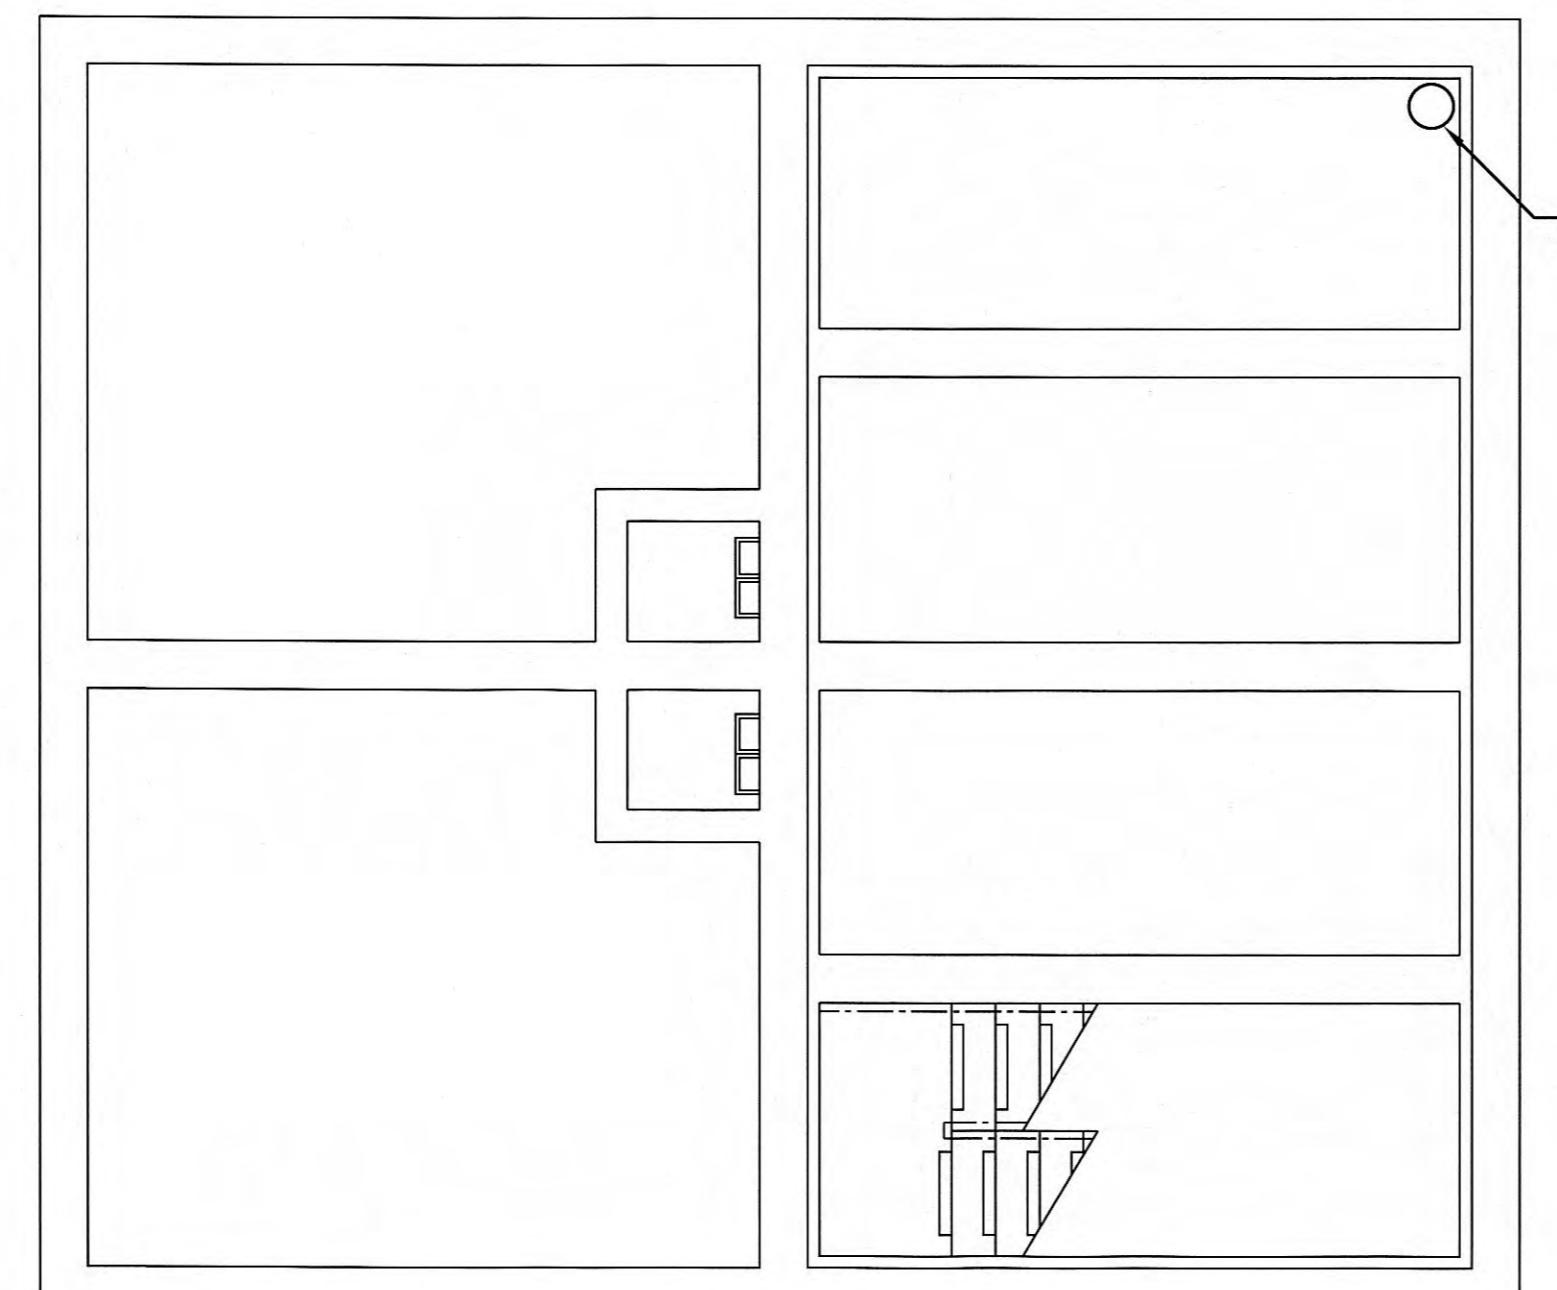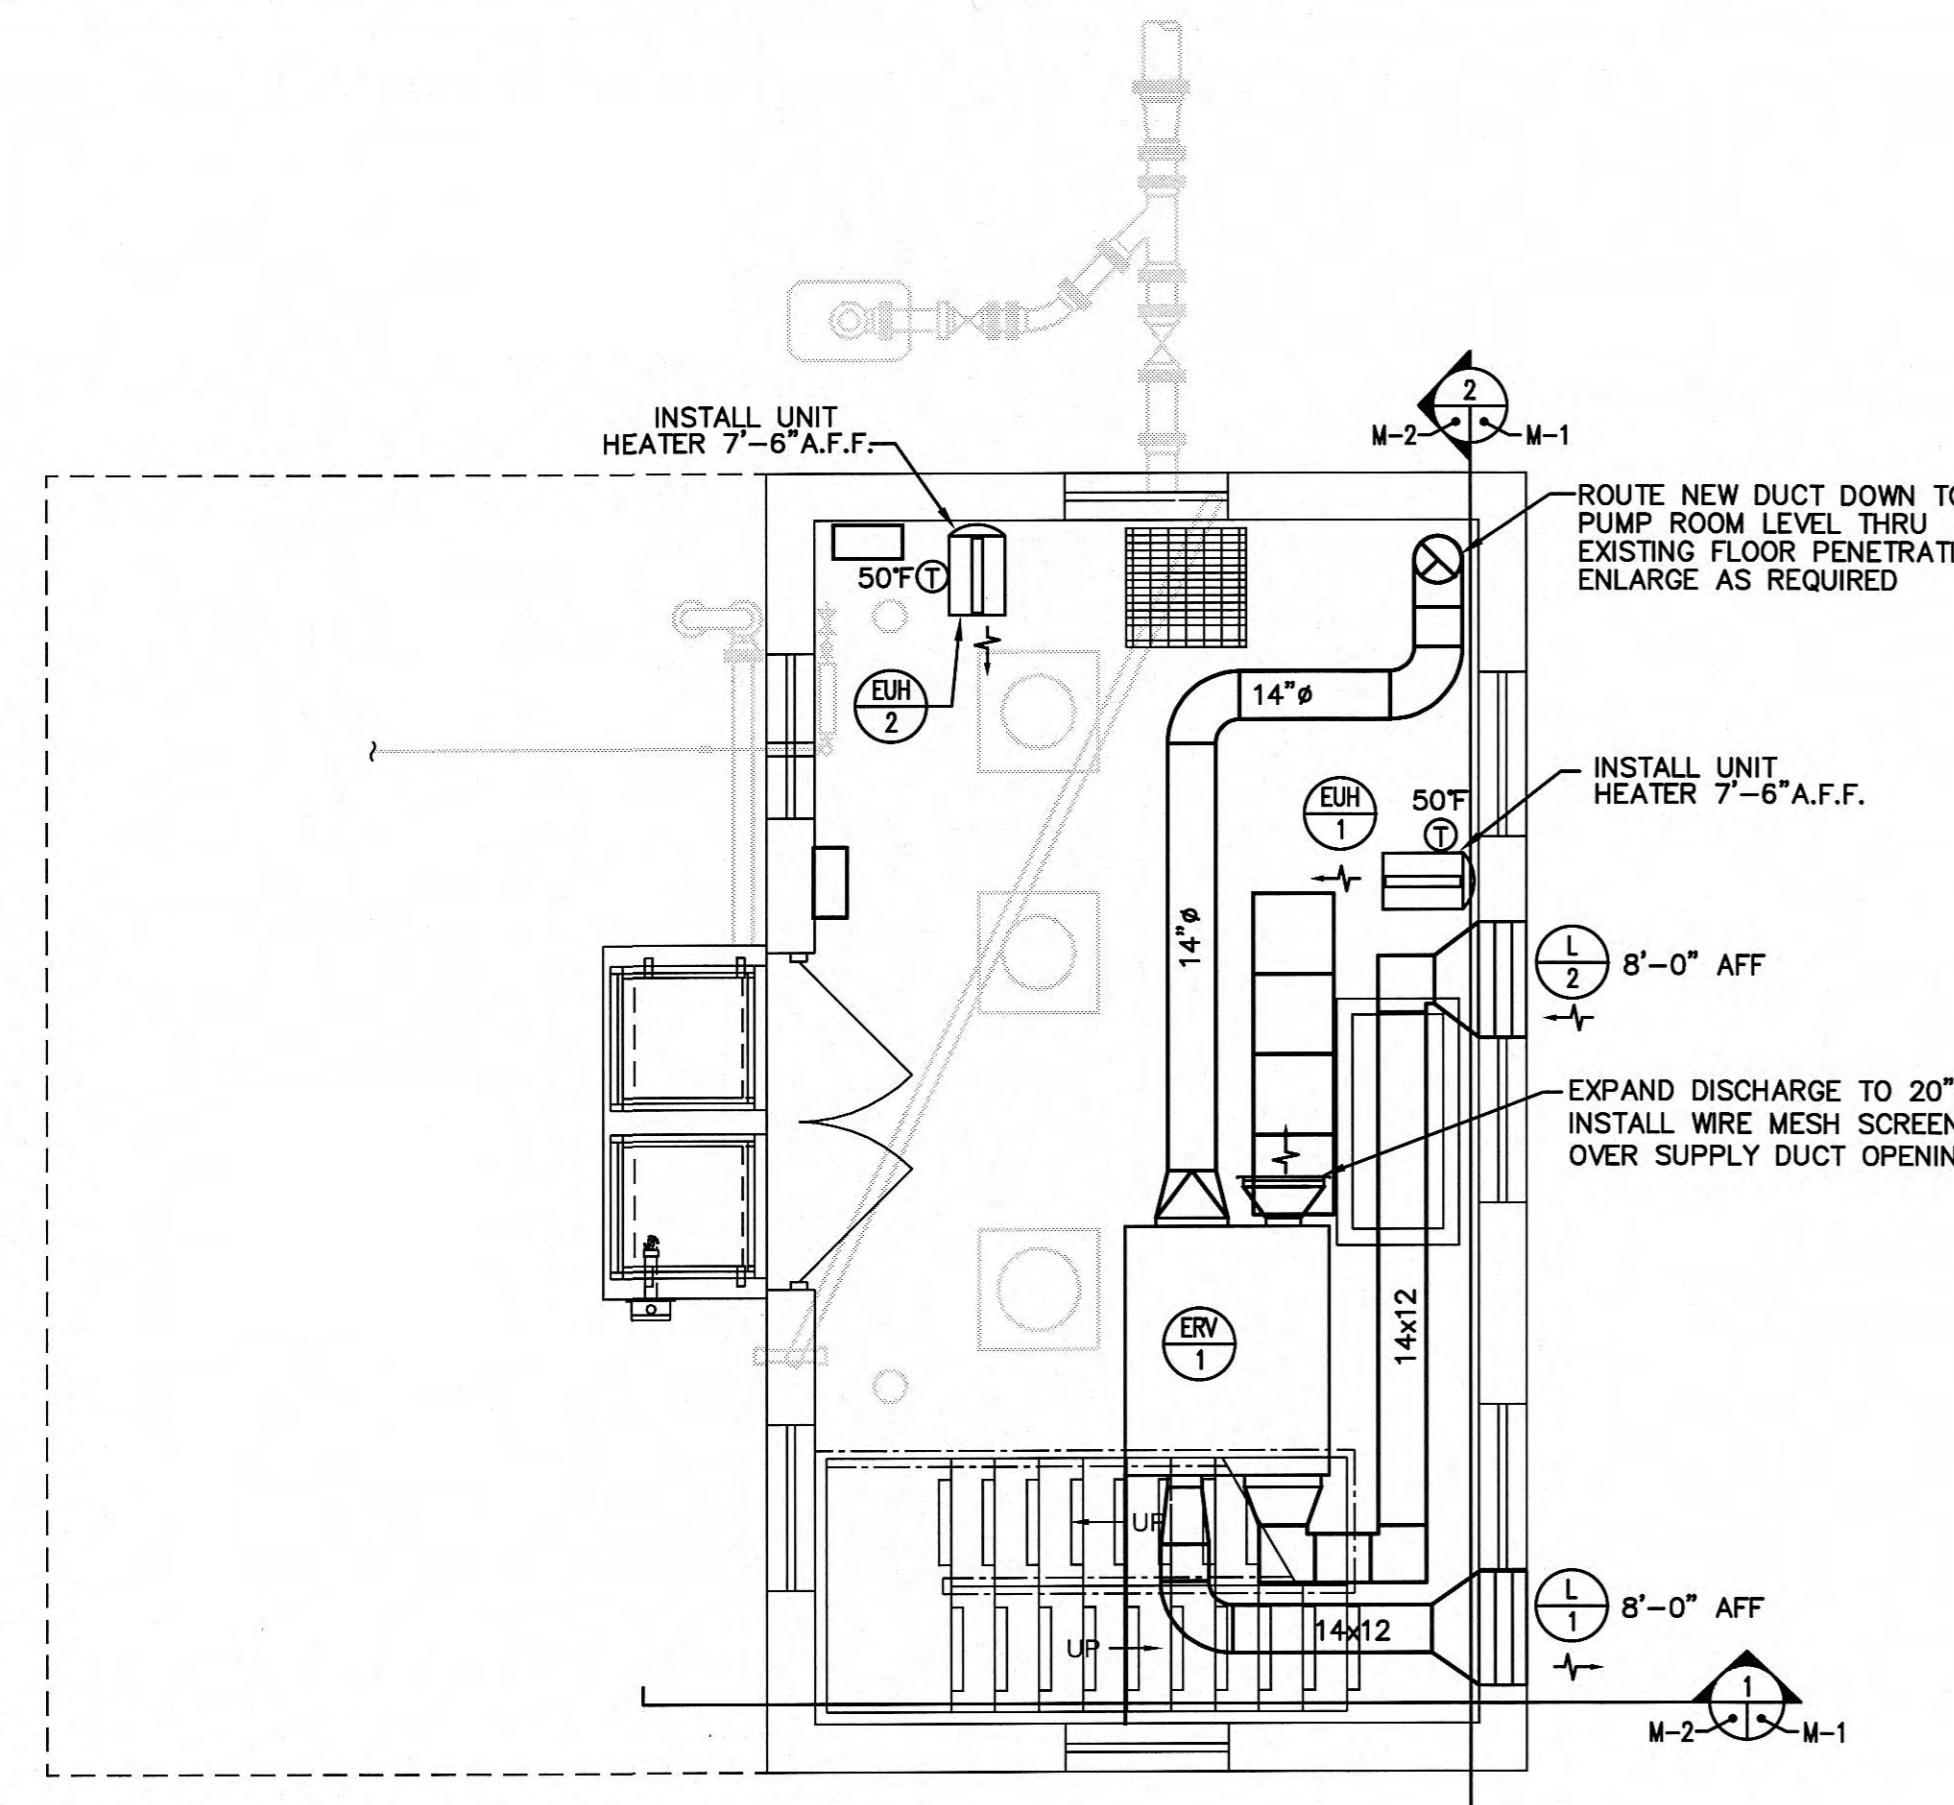
C-1-103



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LADD PUMP STATION FLOOR PLANS - HVAC
PUMP STATION REHABILITATION
CITY OF HARRIMAN, TENNESSEE

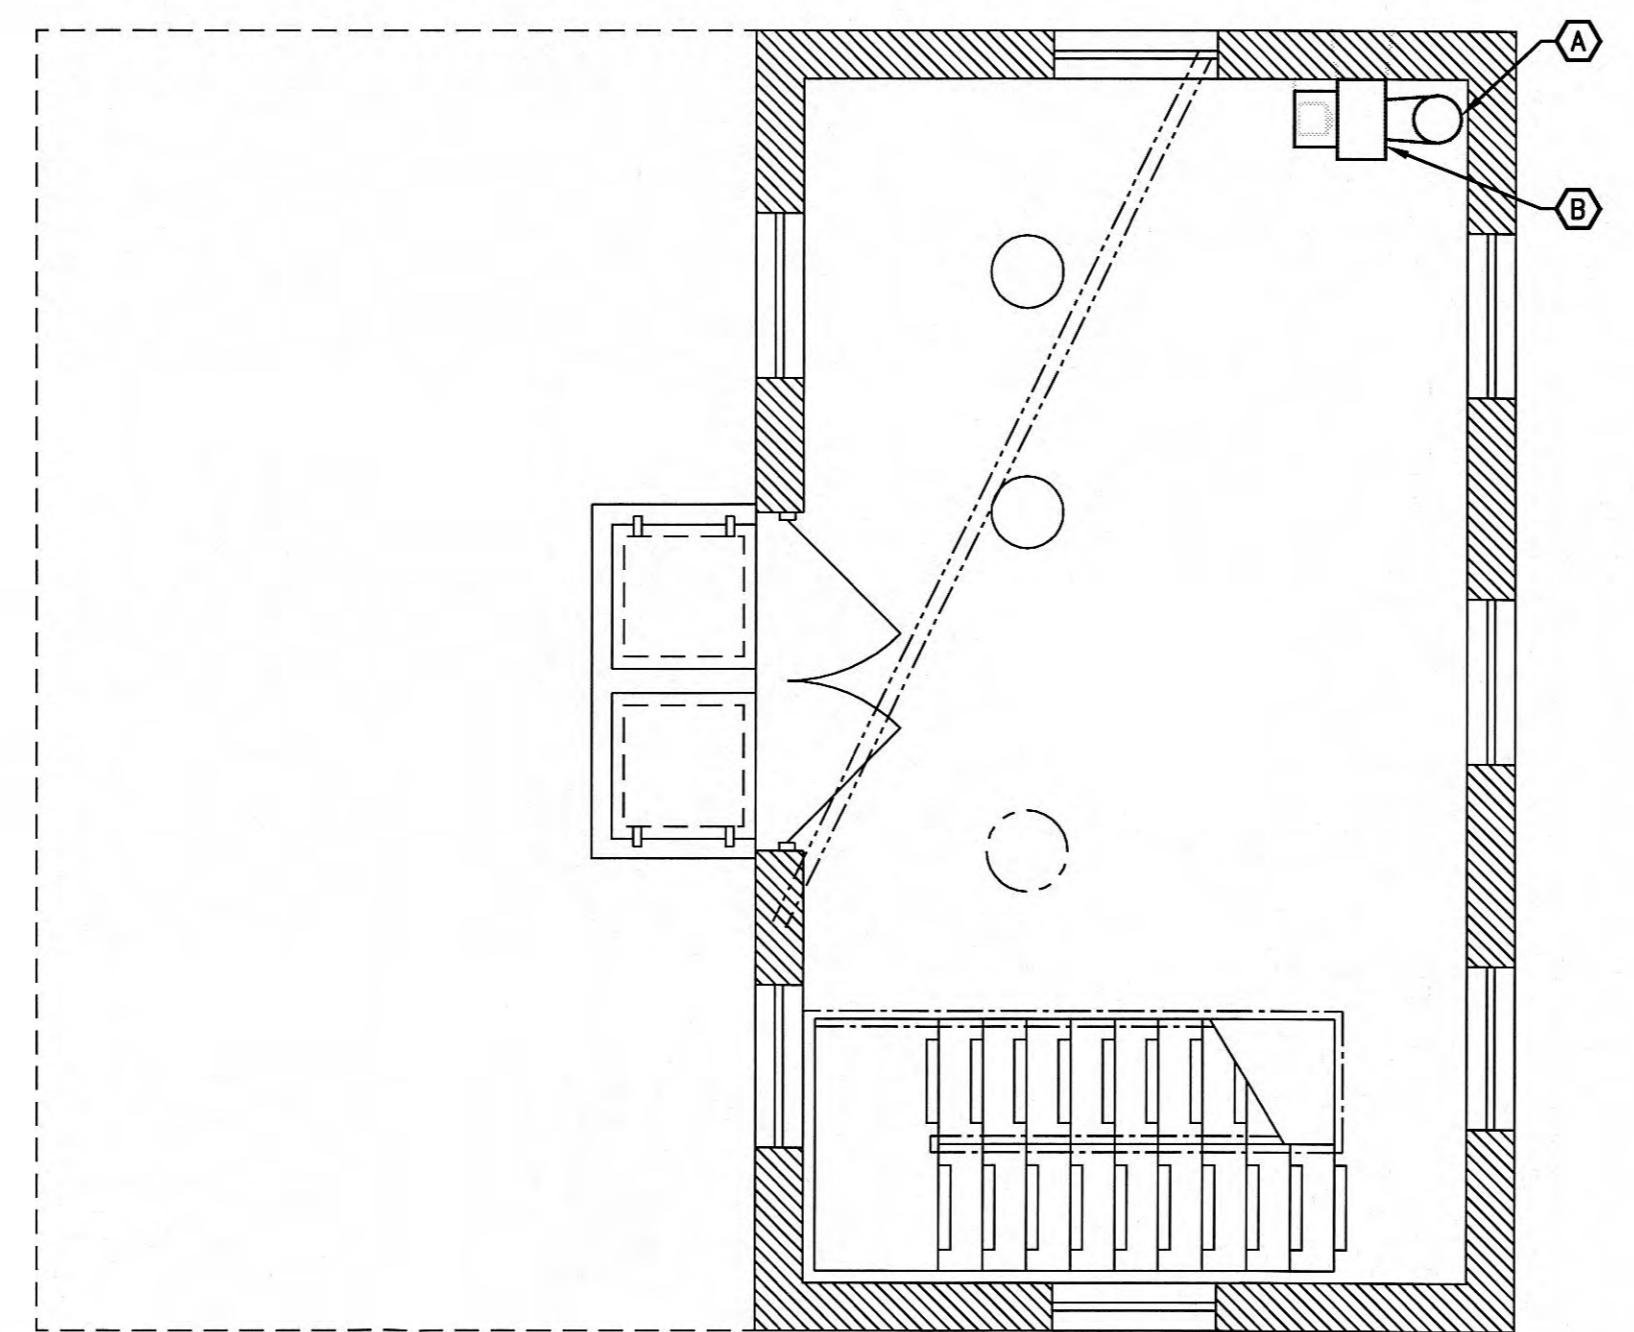- DEMOLITION NOTES:**
- (A) REMOVE ENTIRE LENGTH OF EXISTING EXHAUST DUCT.
 - (B) REMOVE EXISTING EXHAUST FAN DUCT AND WALL LOUVER. SEE ARCHITECTURAL DRAWINGS FOR INFILL.








ENTRANCE FLOOR PLAN - DEMOLITION
SCALE: 1/4=1'-0"

WWR
West, Welch, Reed Engineers, Inc.
WWR PROJECT# 112025
5417 Ball Camp Pike
Knoxville, Tn 37921
Phone: (865) 588-2431
Fax: (865) 588-2434

THIS DRAWING IS GENERALLY DIAGRAMMATIC AND, EXCEPT WHERE SPECIFICALLY DIMENSIONED OR DETAILED, INDICATES THE GENERAL ARRANGEMENT OF THE WORK. THE CONTRACTOR SHALL MAKE HIS WORK TO CONFORM AS NEARLY AS POSSIBLE TO THE LOCATIONS AND REQUIREMENTS SHOWN, BUT ONLY SUCH MINOR ADJUSTMENTS AS NECESSARY TO COORDINATE THE WORK WITH ALL OTHER TRADES TO AVOID INTERFERENCES.

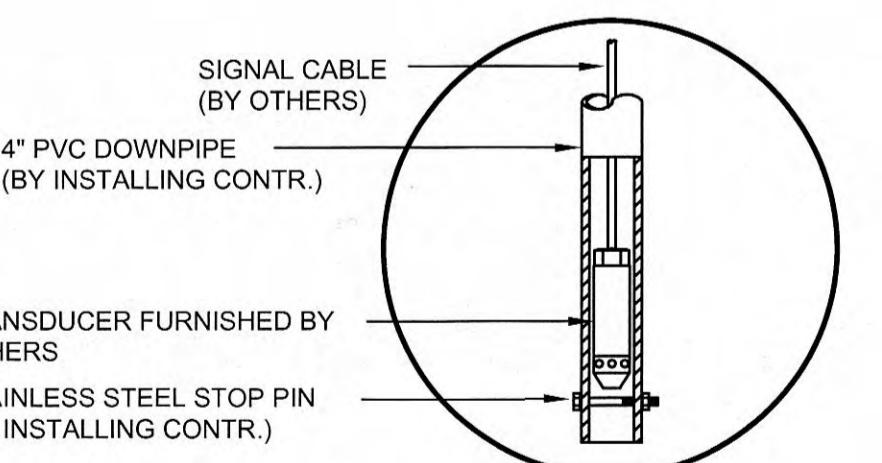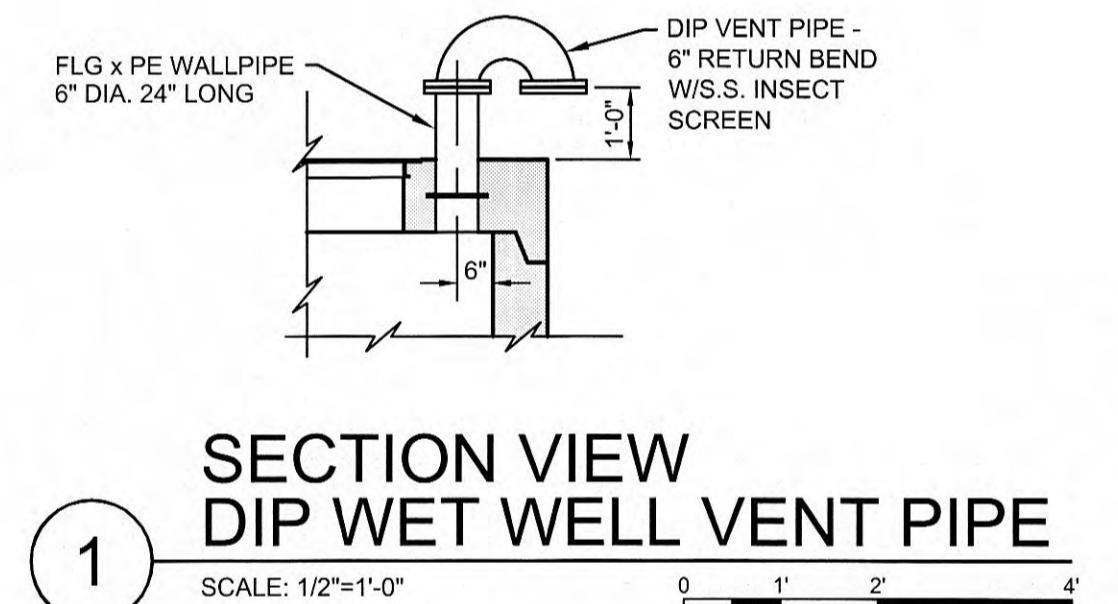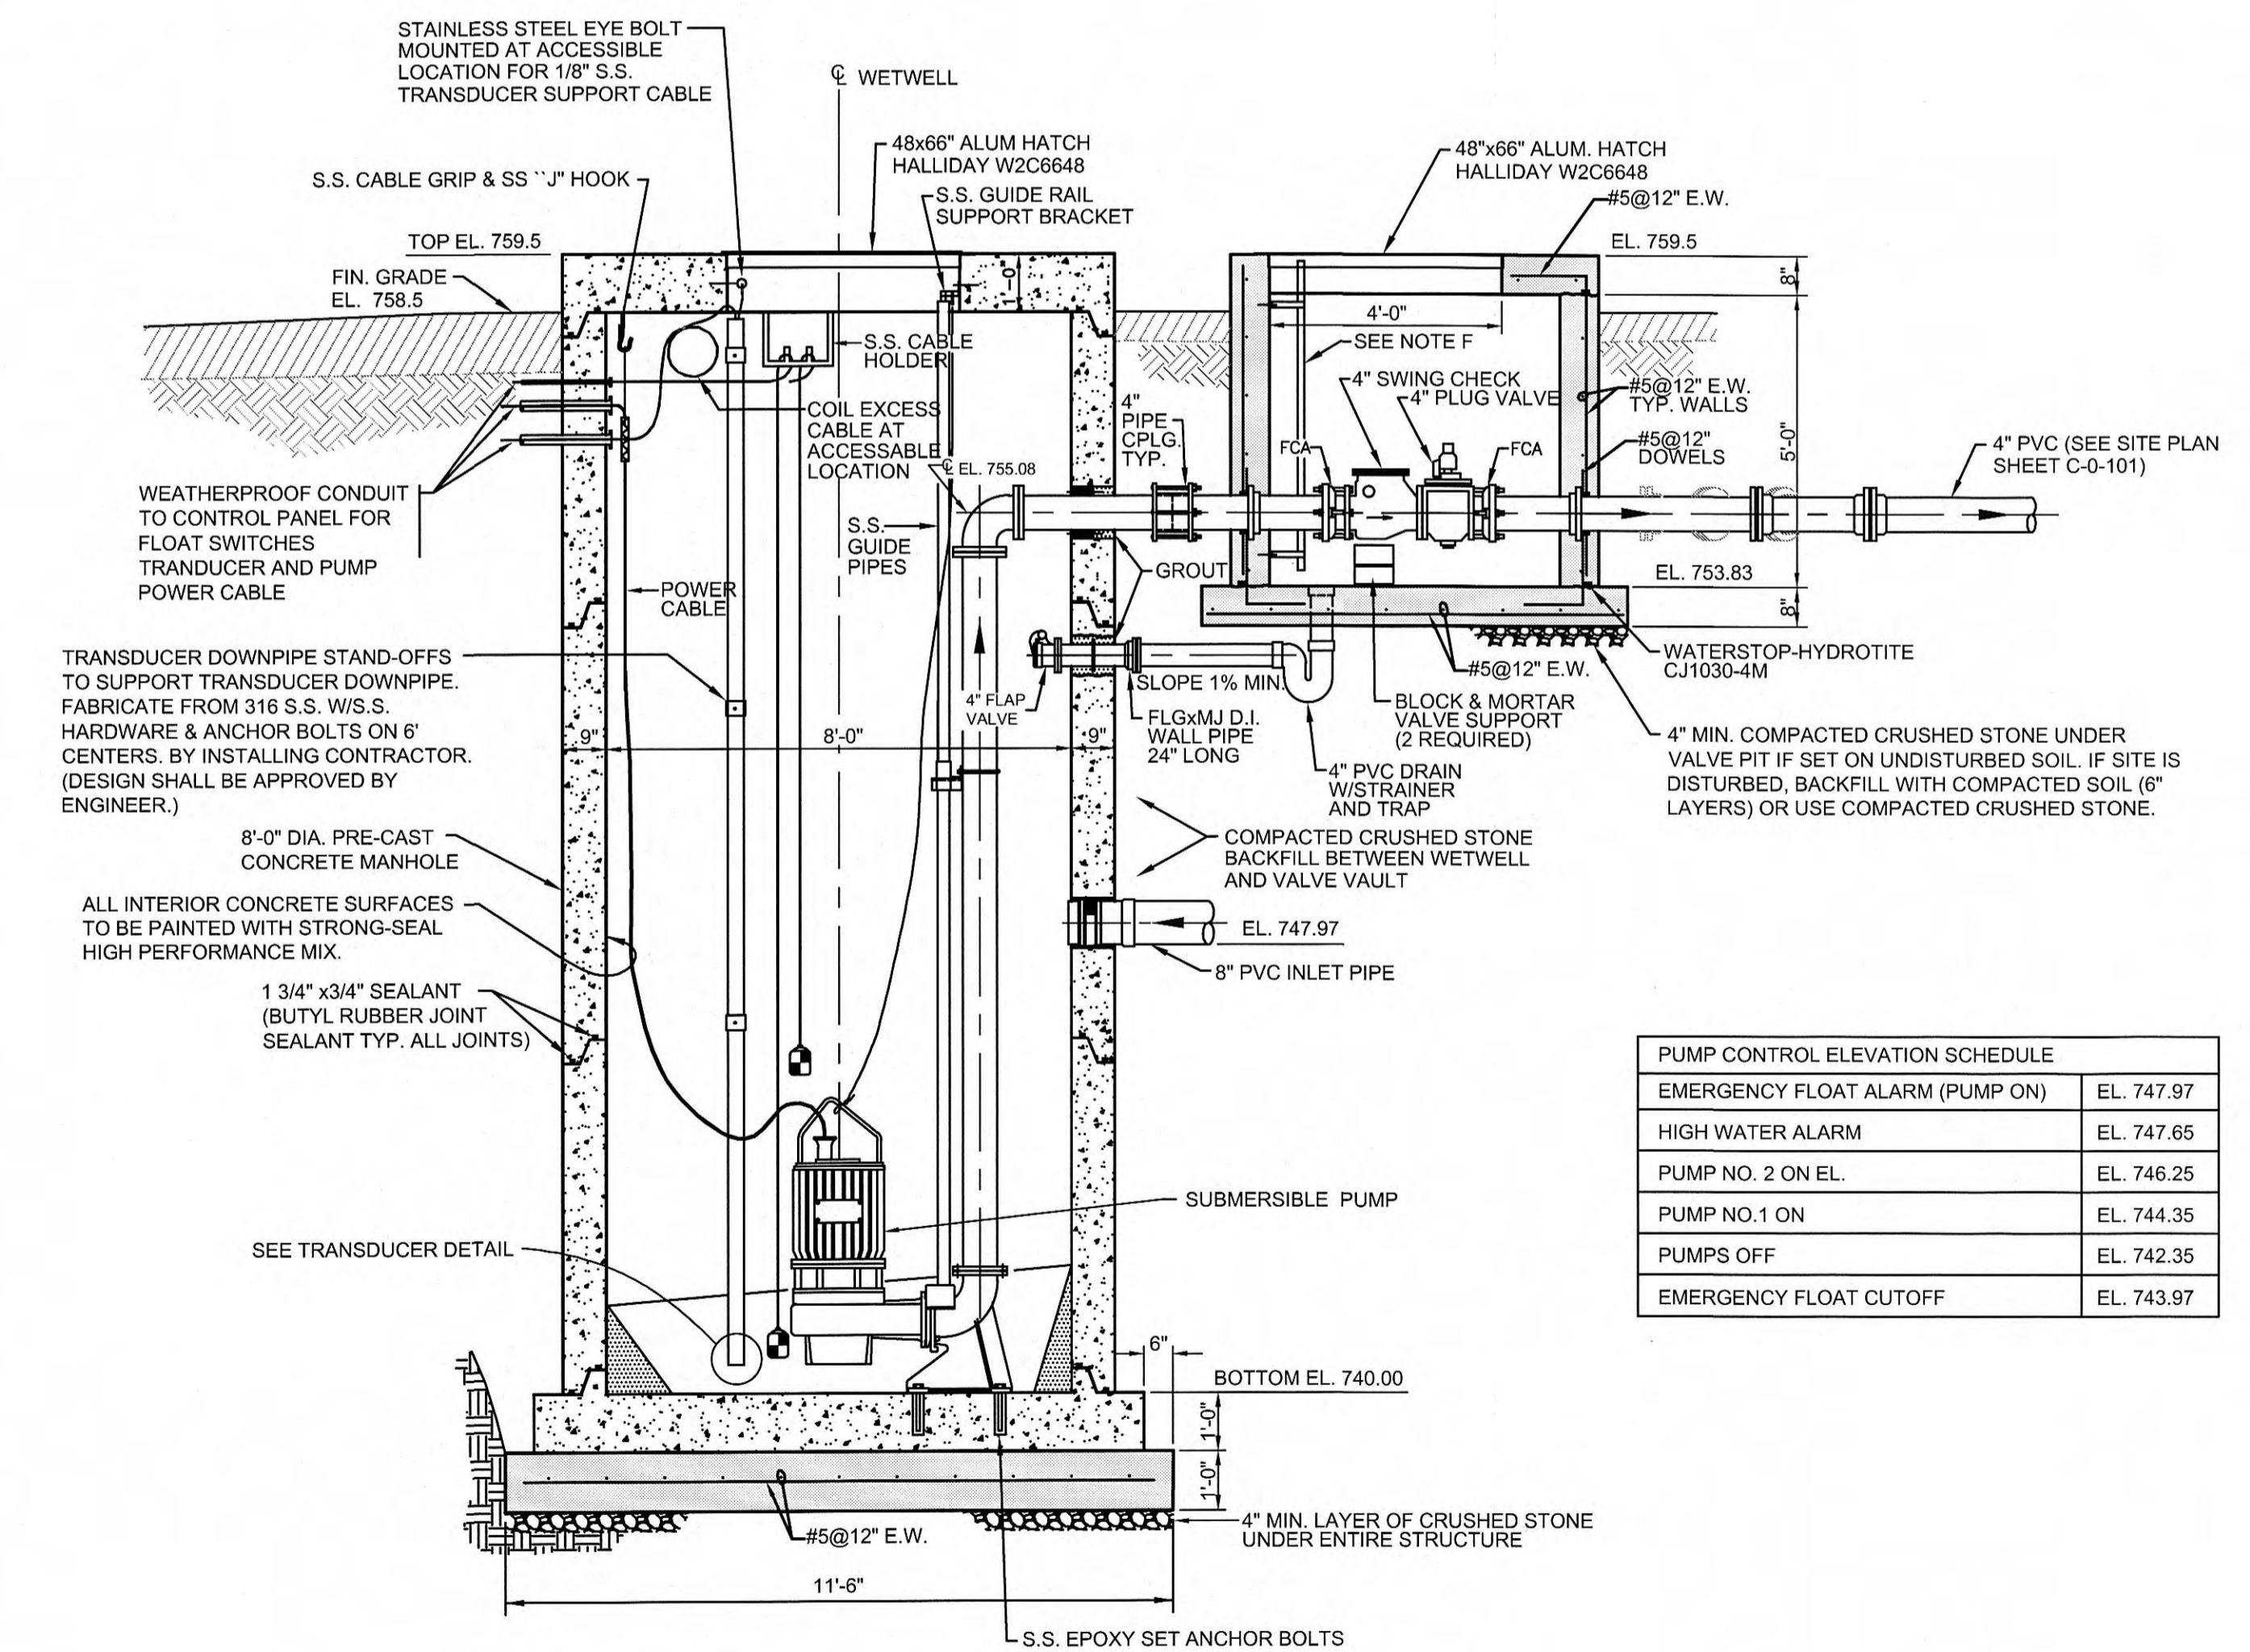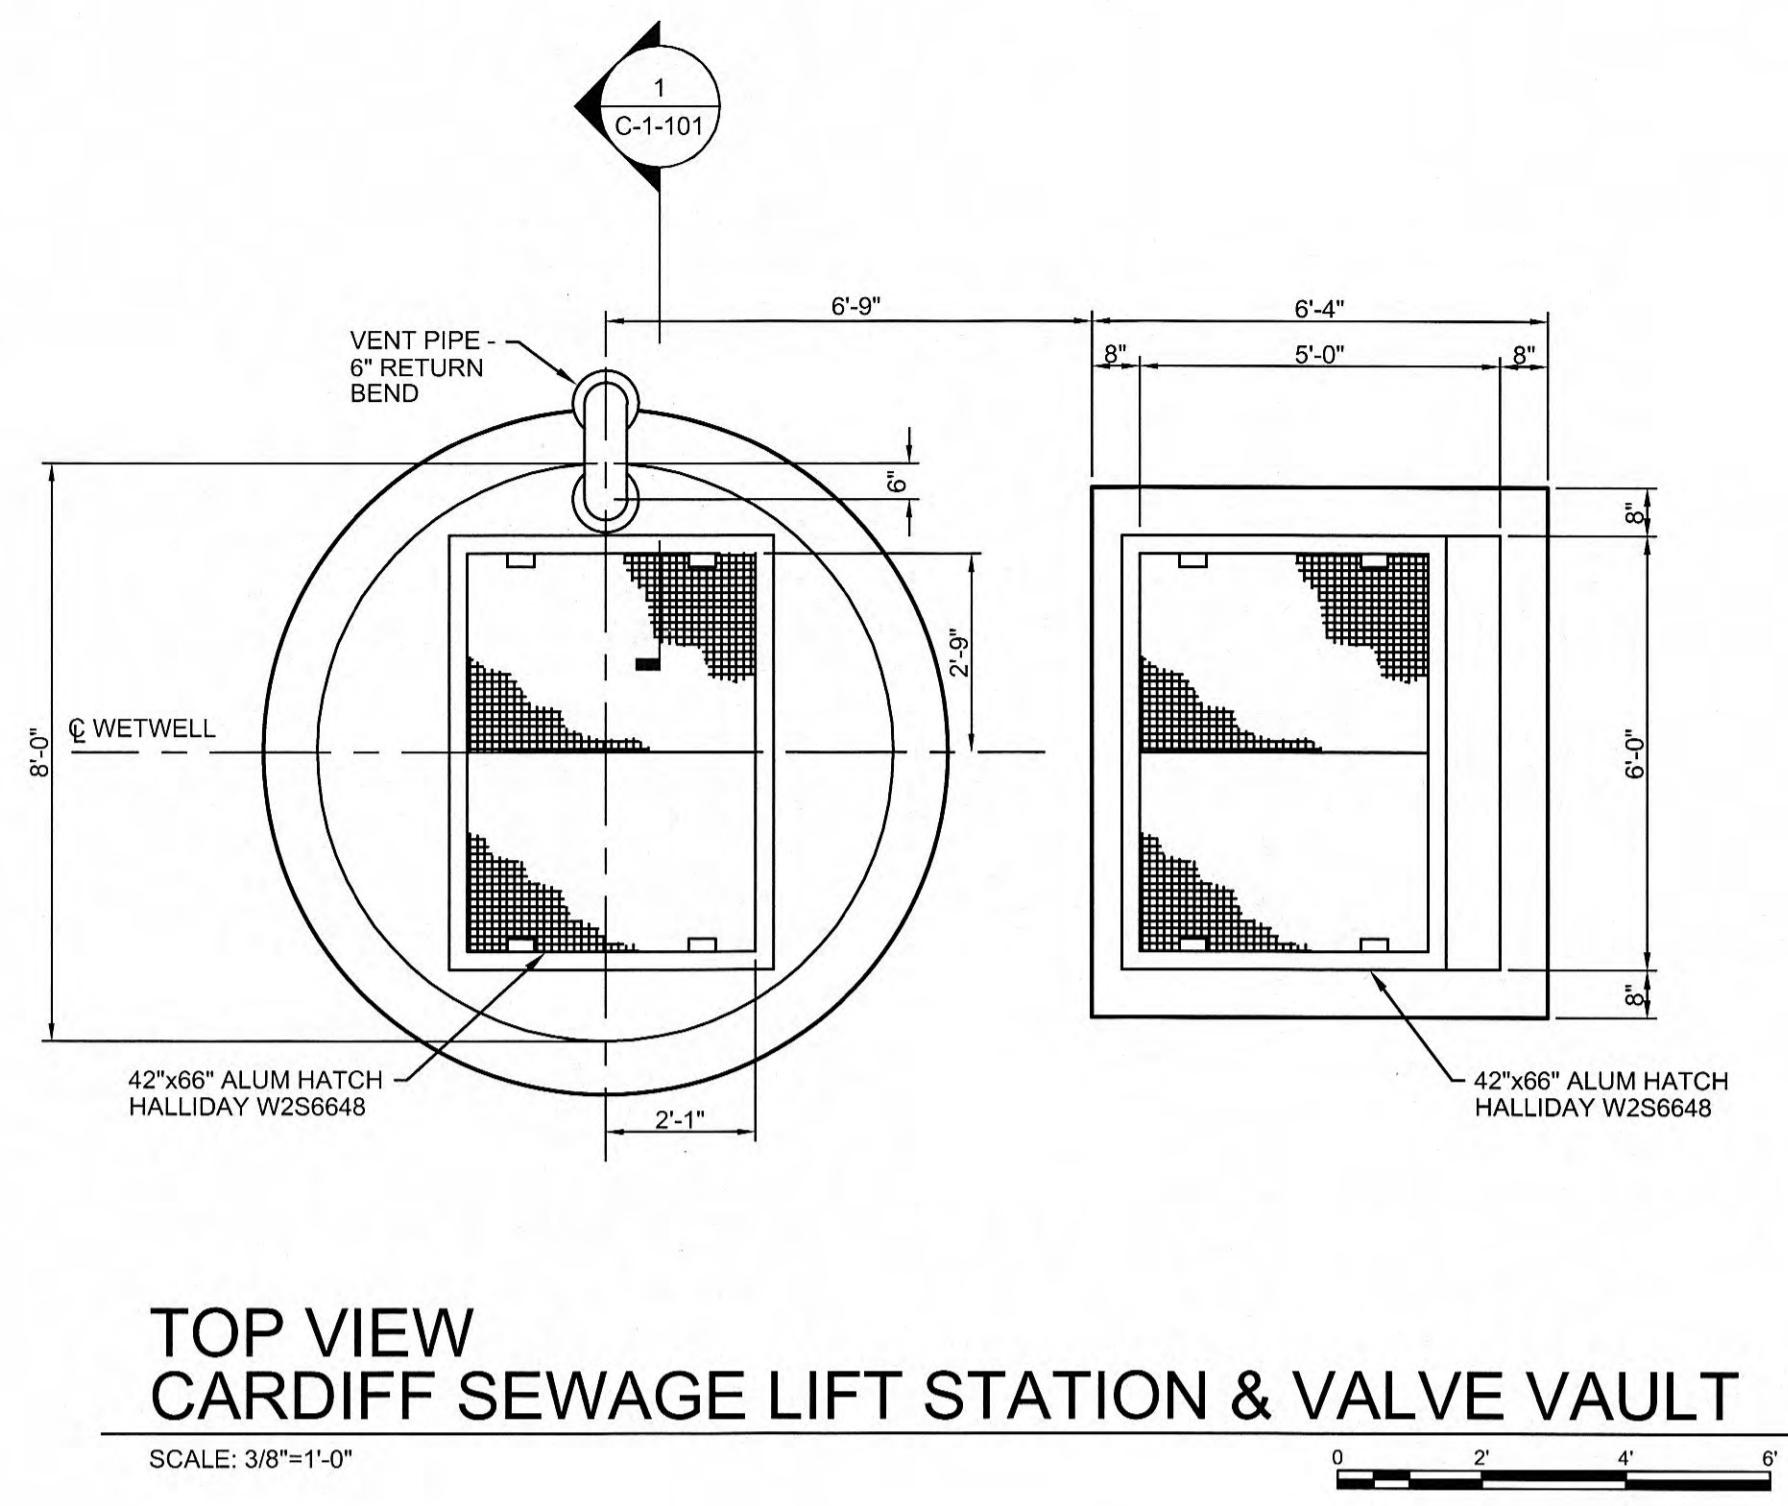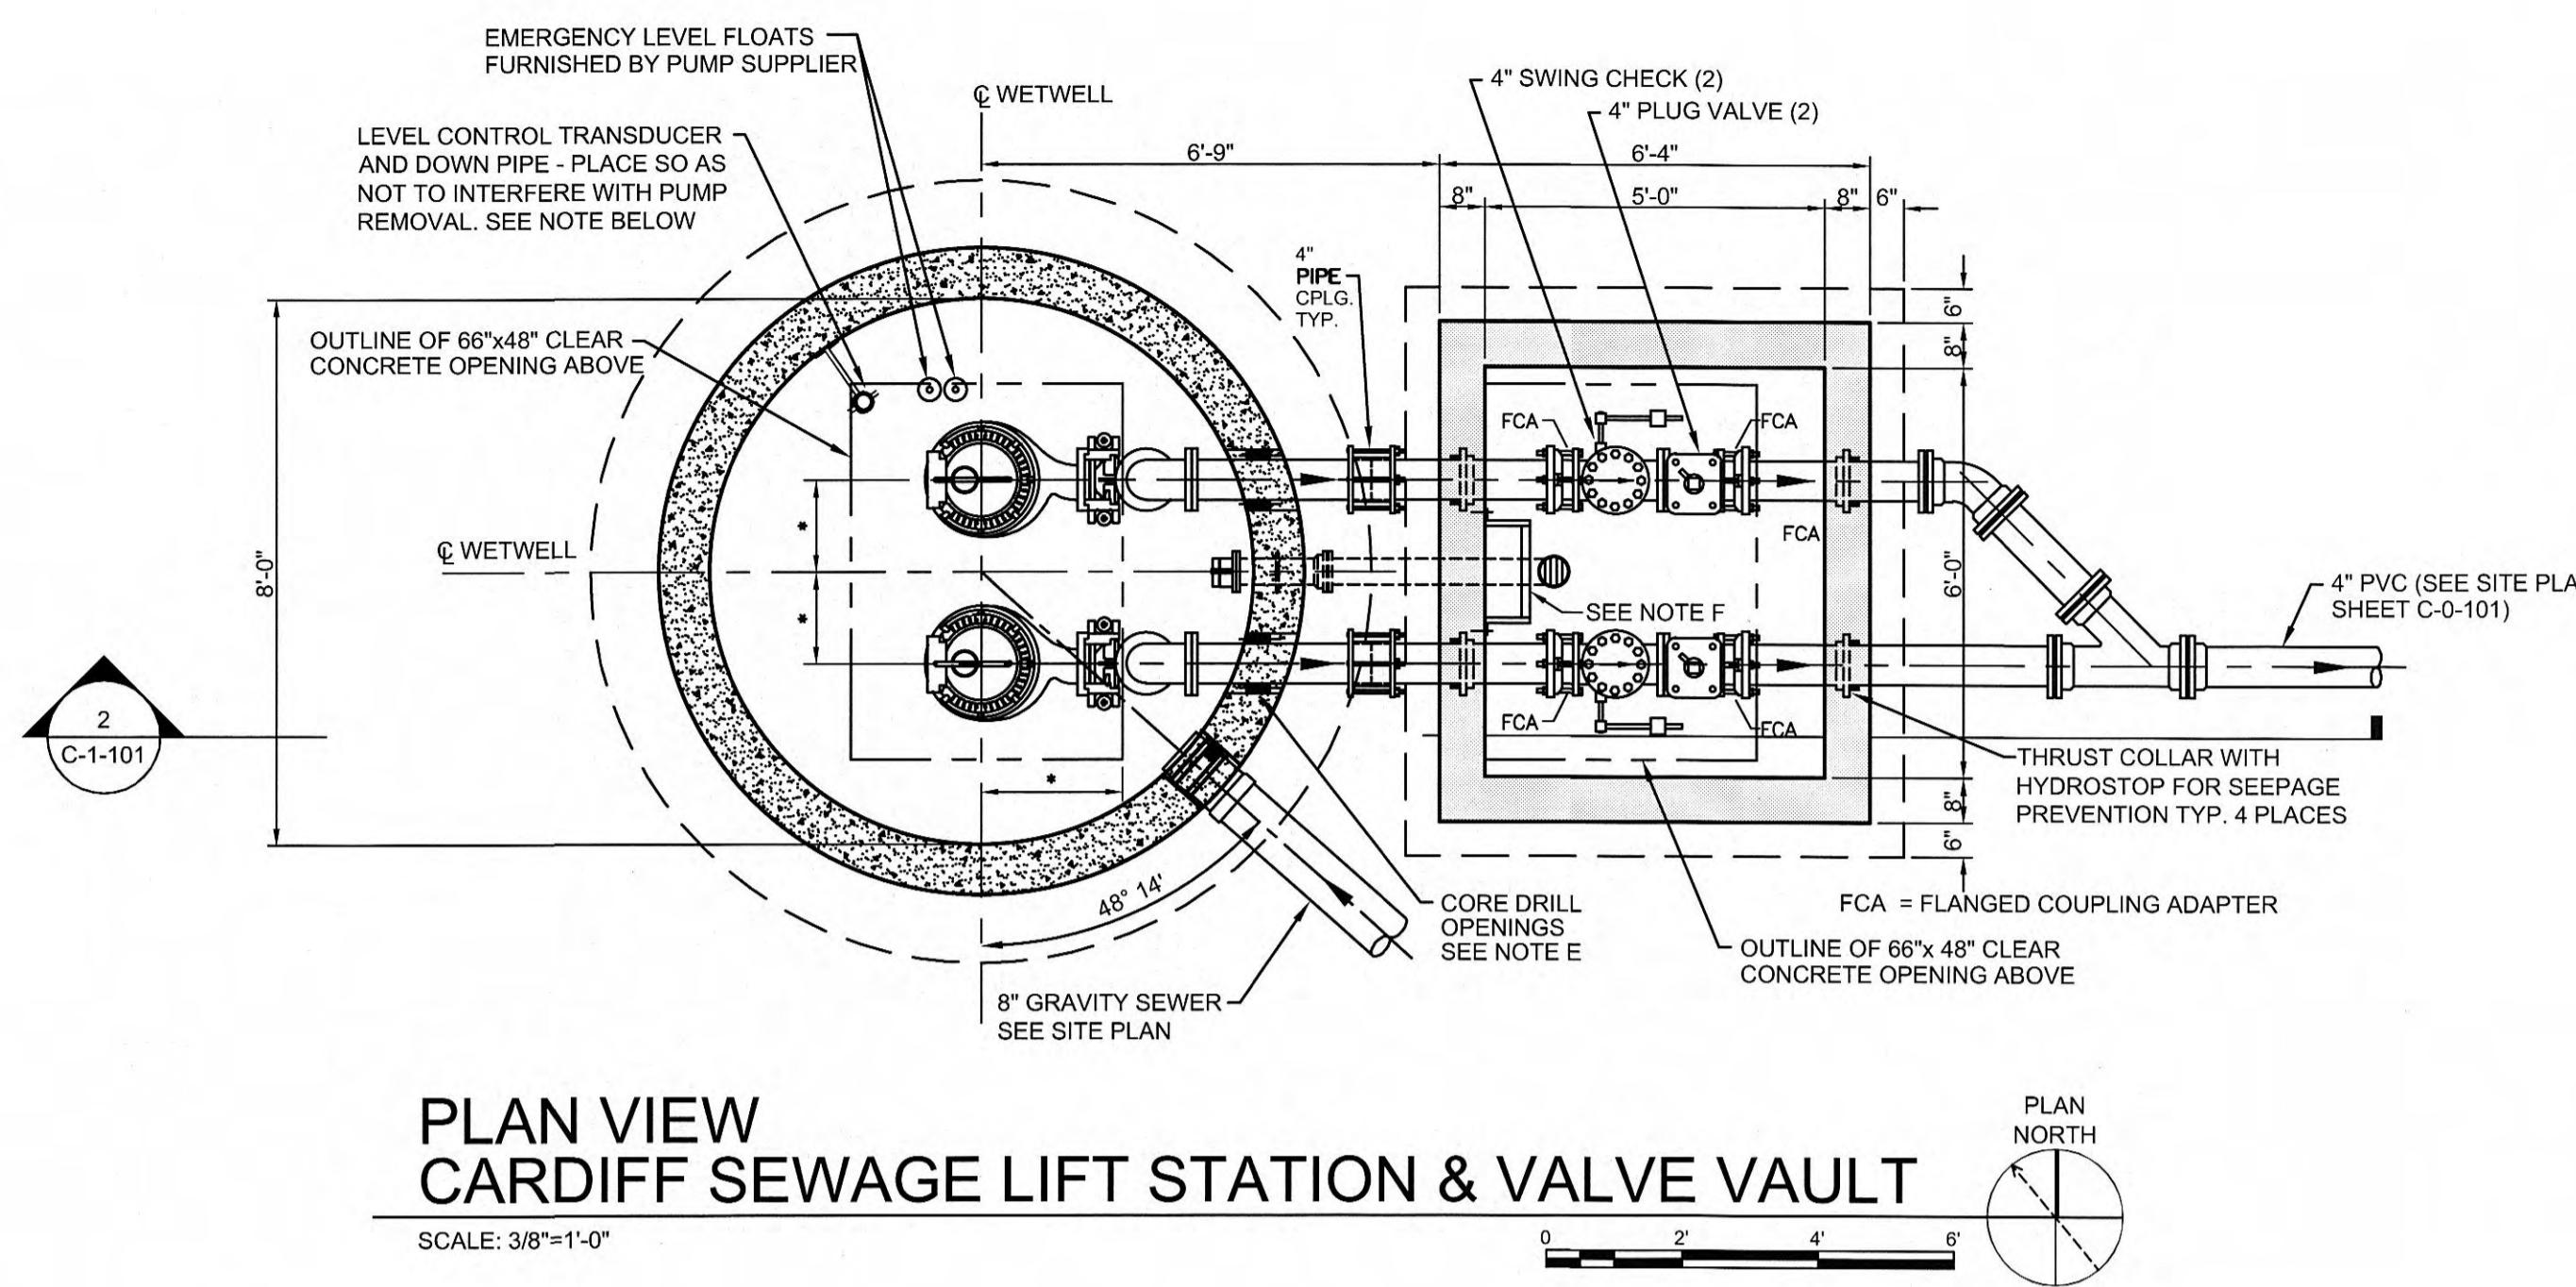DATE: DECEMBER 2012
SCALE: AS NOTED
SHEET NO. M-2



TRANSDUCER DETAIL

NOT TO SCALE

- NOTE:
- (A) ALL ANCHOR BOLTS AND FASTNERS USED IN PUMP STATION WET WELL & VALVE VAULT SHALL BE STAINLESS STEEL
 - (B) PUMPS AND STATION HATCH SHALL BE LOCATED AND INSTALLED AS RECOMMENDED BY PUMP MANUFACTURER.
 - (C) ALL PRECAST ELEMENTS OF PUMP STATION SHALL MEET OR EXCEED LATEST A.S.T.M. SPEC'S.
 - (D) PROVIDE INTERMEDIATE GUIDE RAIL SUPPORT BRACKET AS RECOMMENDED BY PUMP MANUF.
 - (E) PROPOSED PIPE HOLES THRU WET WELL WALL SHALL BE CORE DRILLED AND SEALED WATERTIGHT WITH LINK-SEAL - BY THUNDERLINE.
 - (F) PROVIDE ALUM. LADDER WITH SAF-T-CLIMB REMOVABLE EXTENSION KIT.
 - (G) NEW WET WELL AND MANHOLE TO BE COATED INSIDE WITH STRONG-SEAL HIGH PERFORMANCE MIX 100% PURE FUSED CALCIUM ALUMINATE WITH ALKALINE-RESISTANT FIBERGLASS REINFORCEMENT.

GRW PROJECT NO 3947-01	CLIENT PROJECT NO
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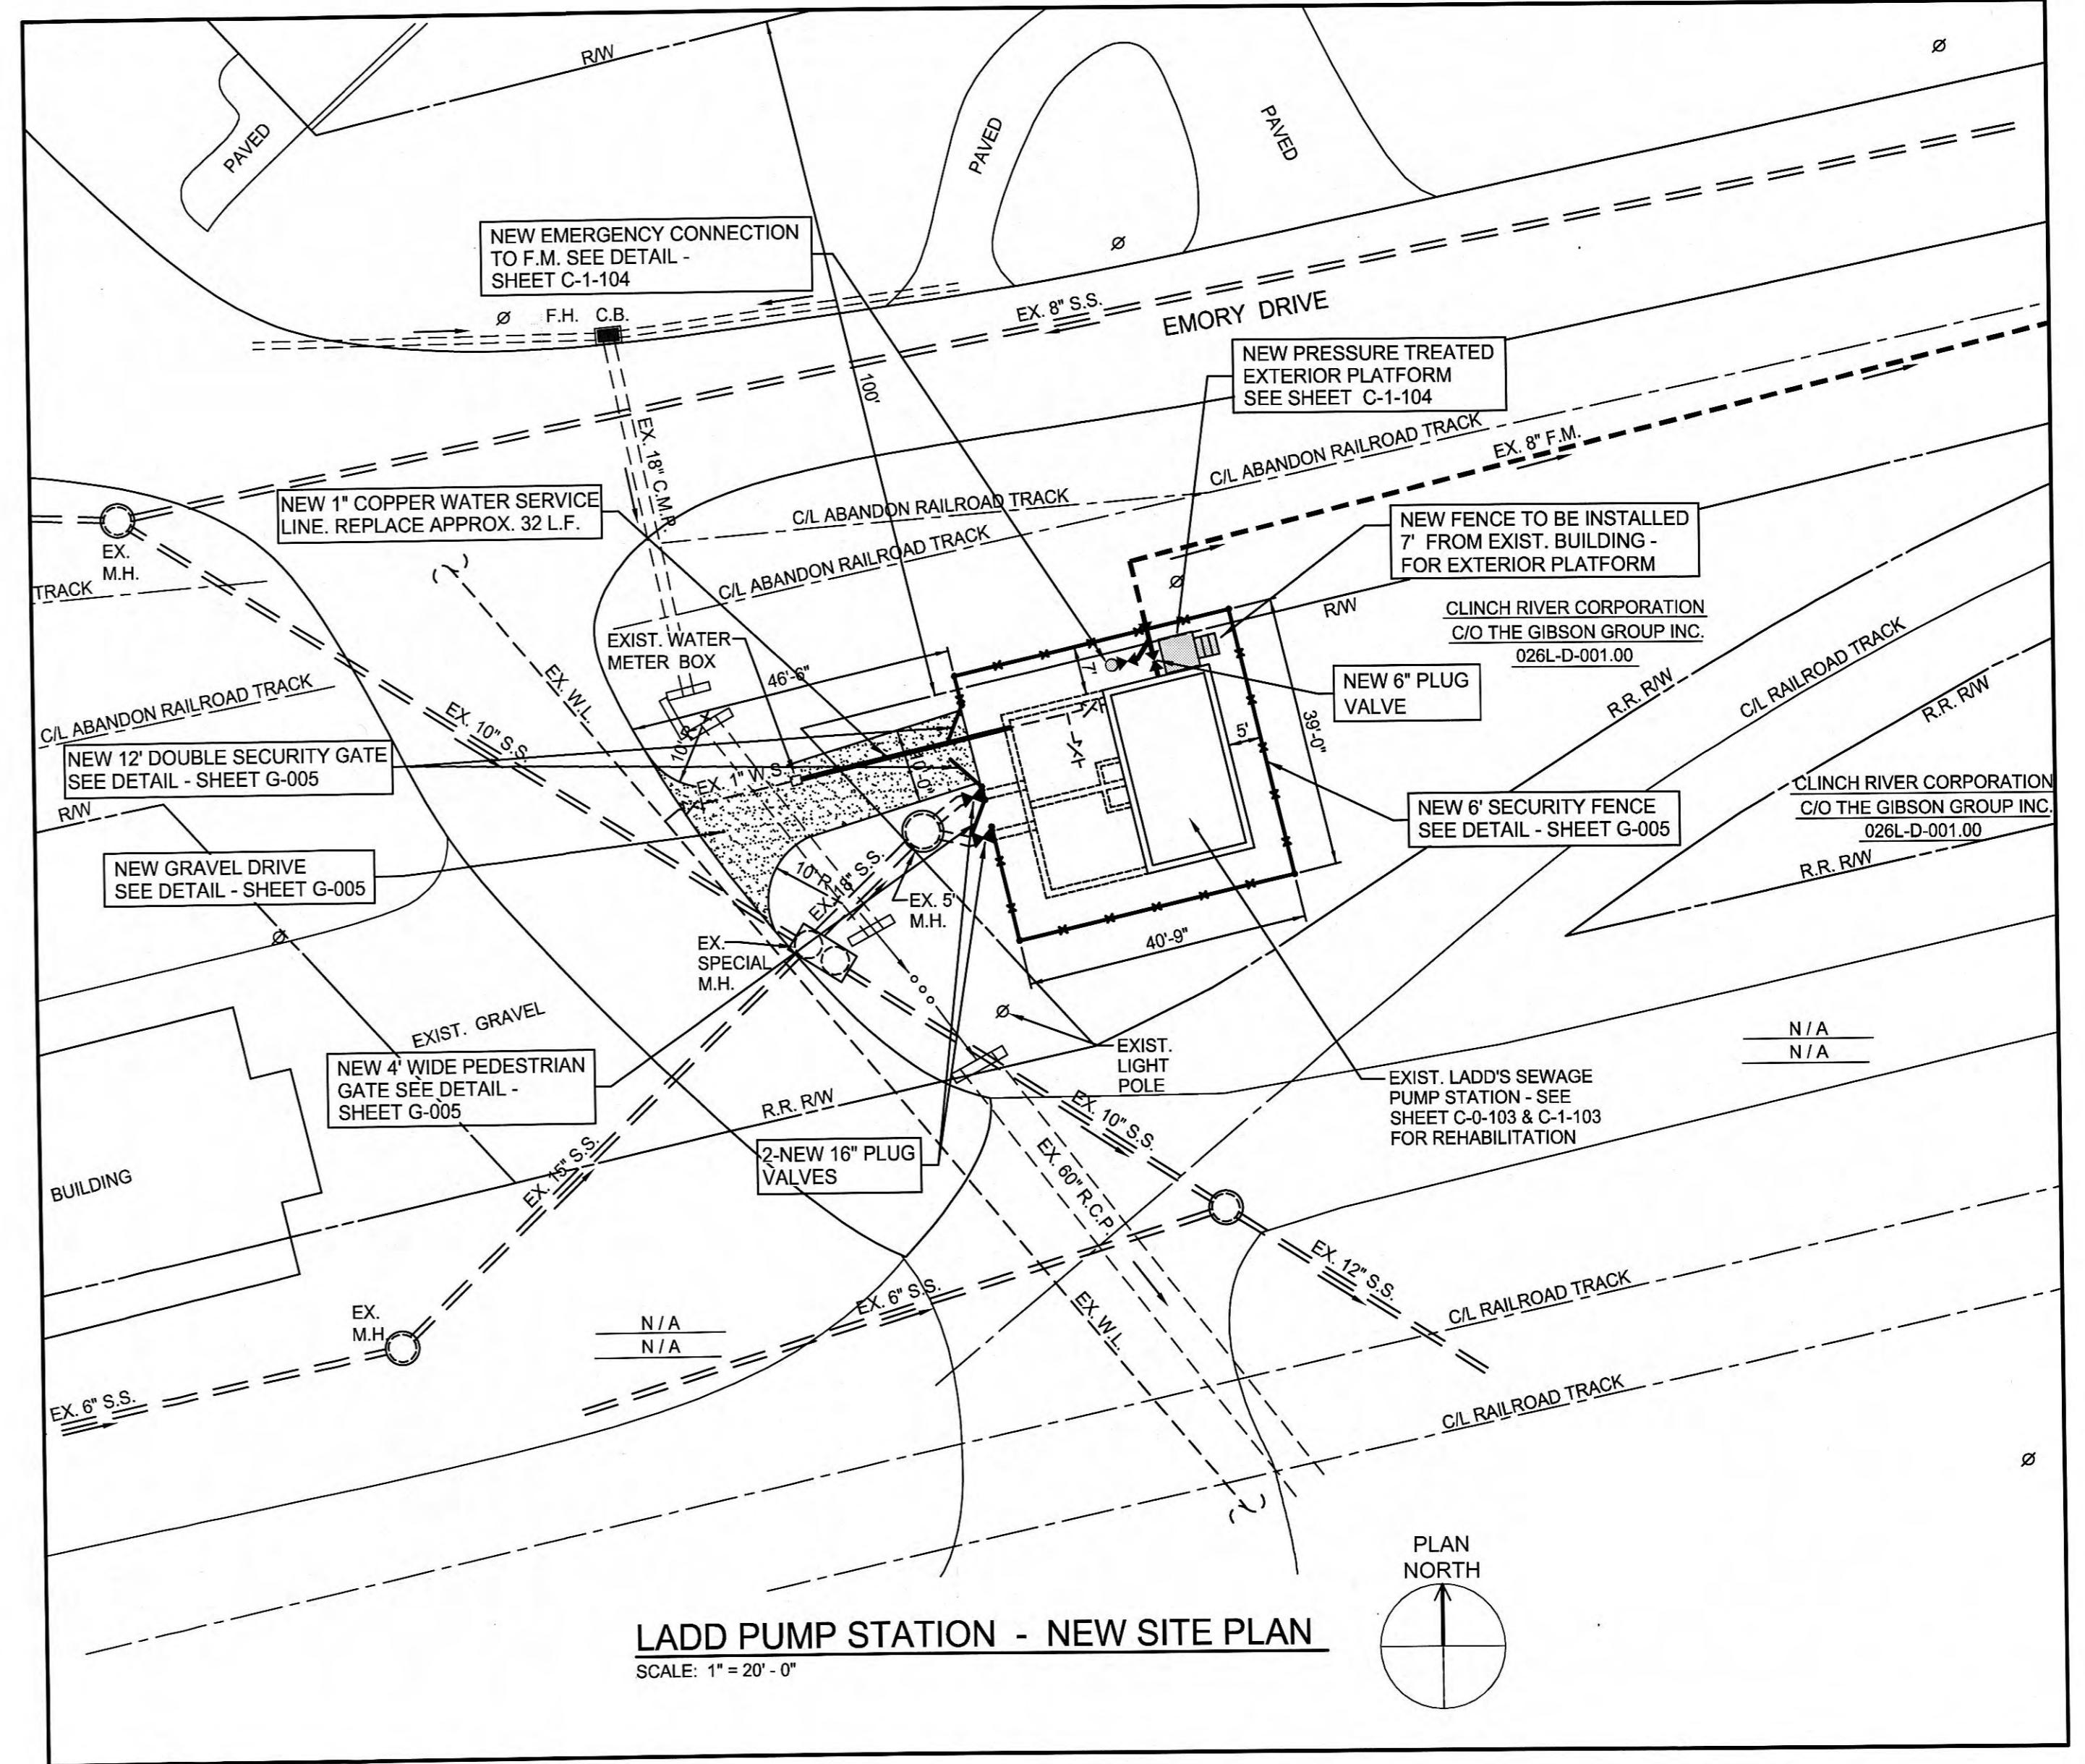
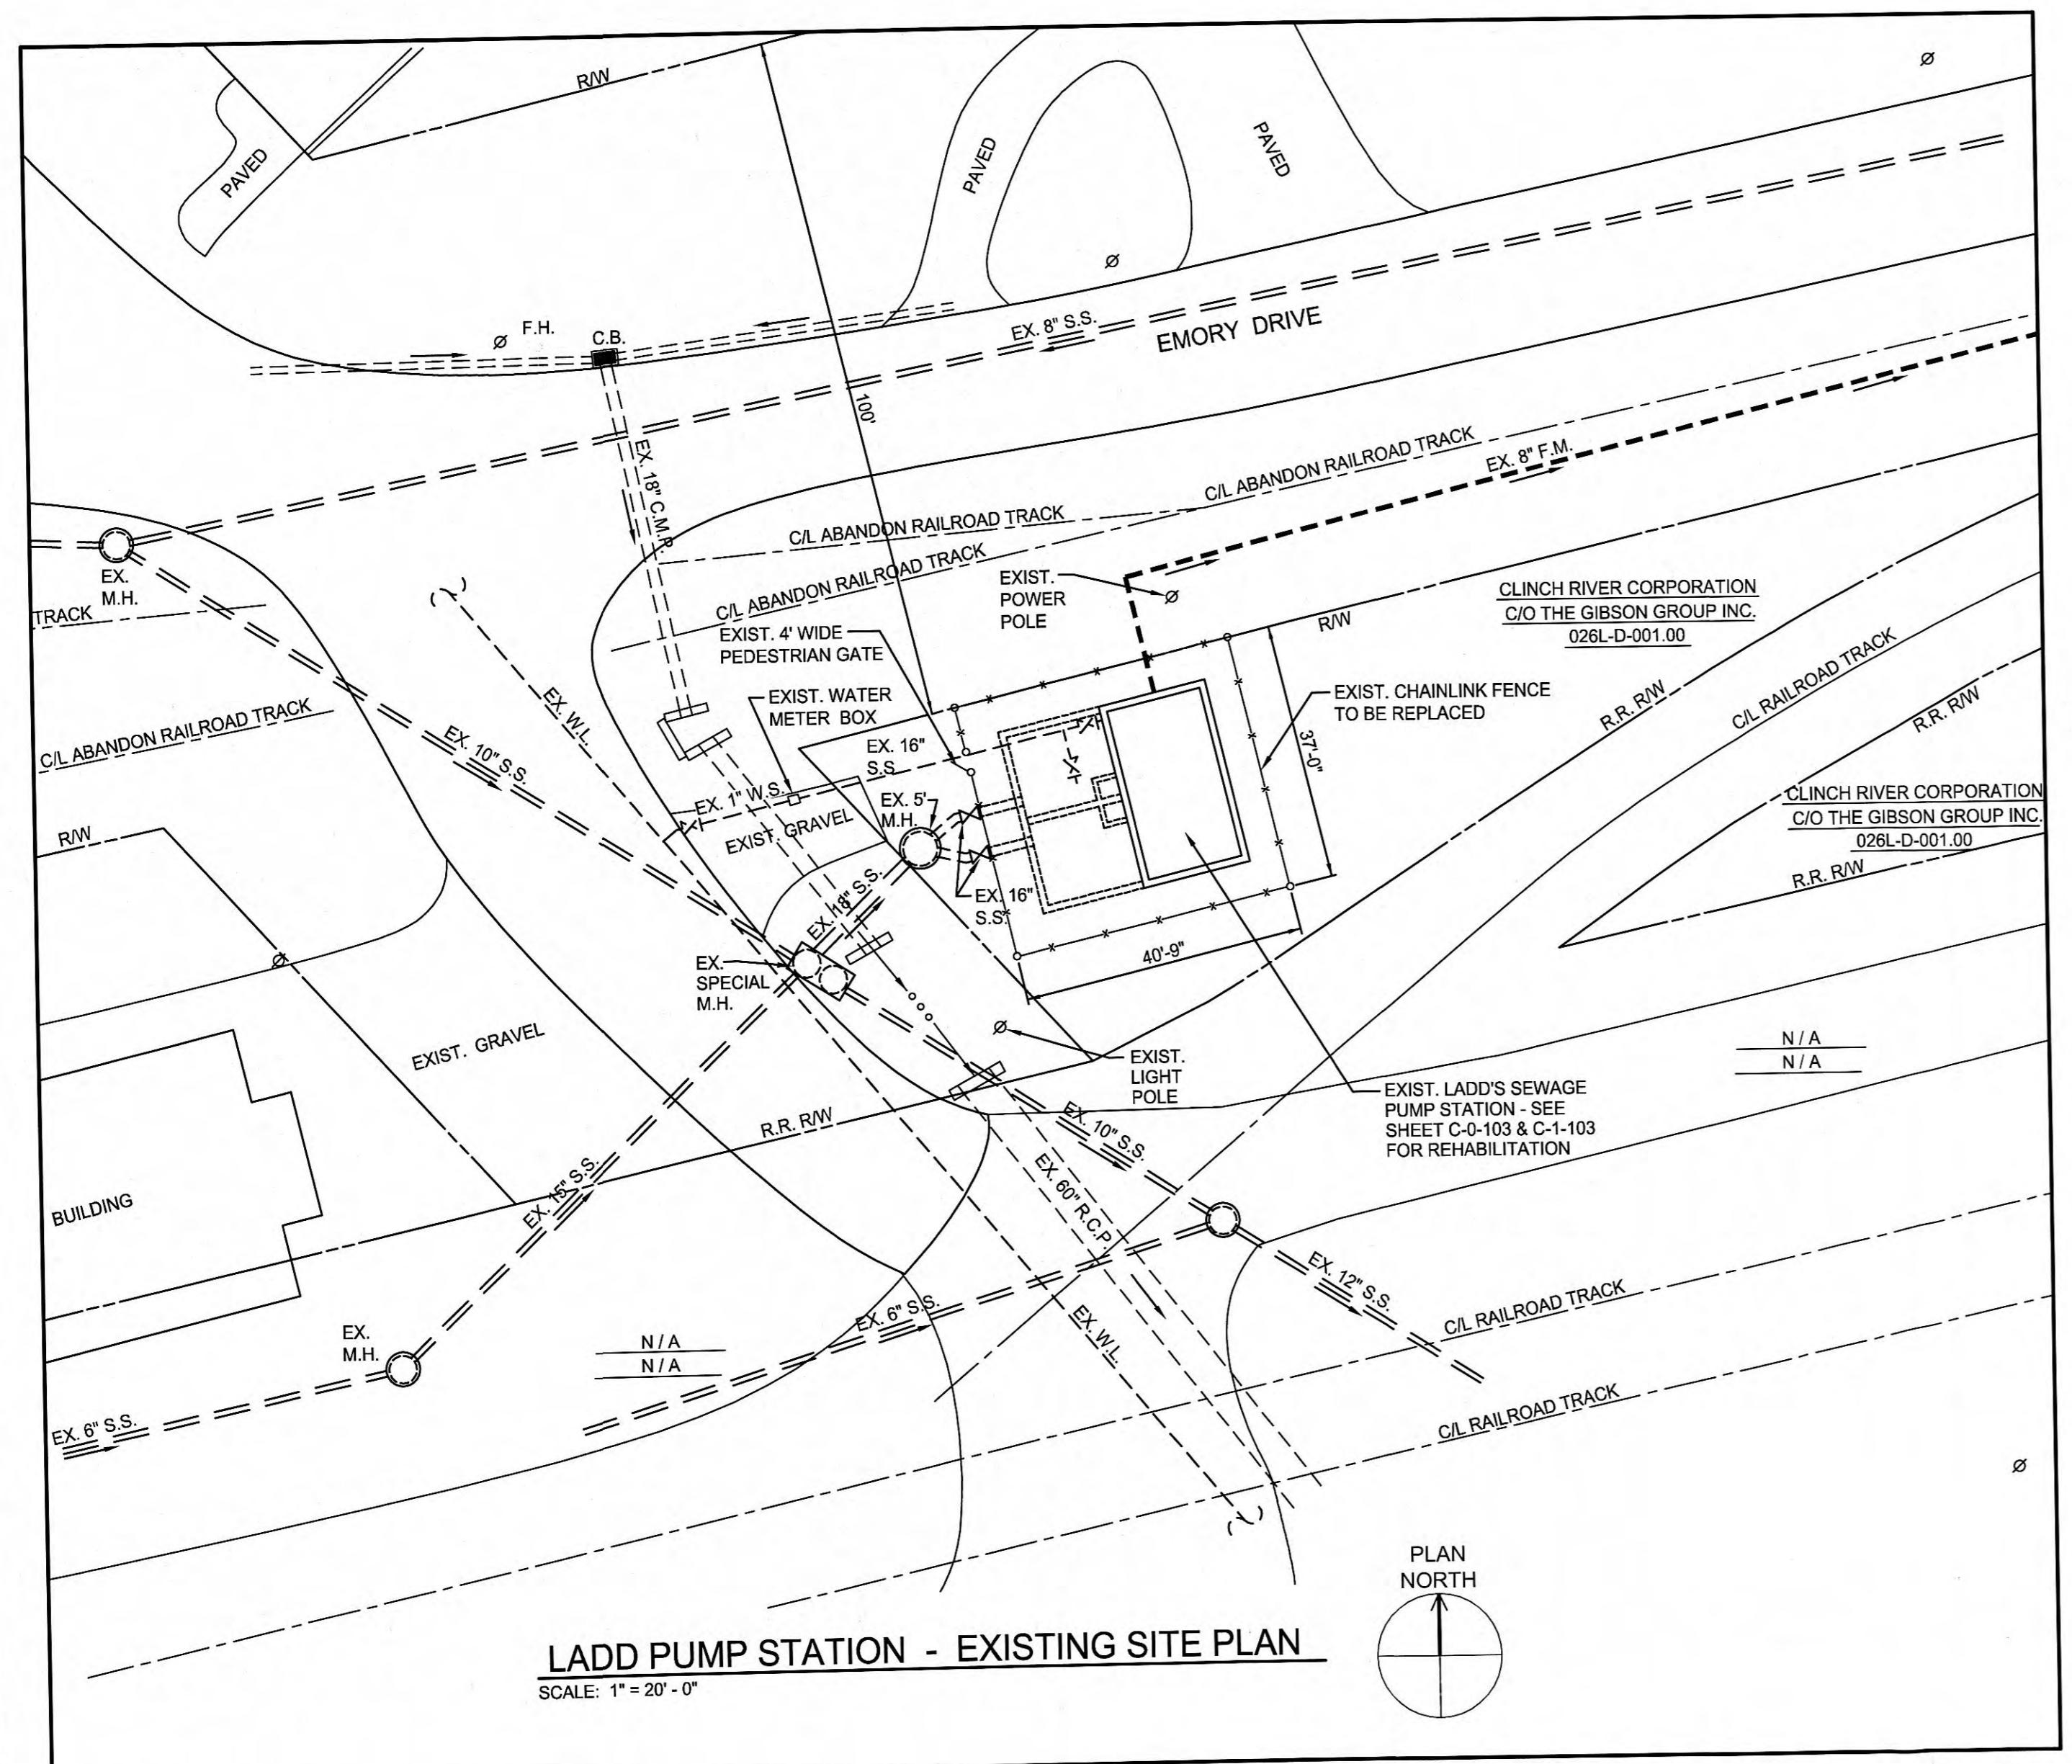
GRW

**NEW CARDIFF PUMP STATION
NEW EQUIPMENT, PLAN AND SECTIONS**
PUMP STATION REHABILITATION
CITY OF HARRIMAN, TENNESSEE

REVISIONS	RECORDED	RGT
DESCRIPTION	DATE	DRAWN
		CJSH
		REVISED
		RGT
		APPROVED
		RGT

DATE: DECEMBER 2012
SCALE: AS NOTED
SHEET NO. C-1-101

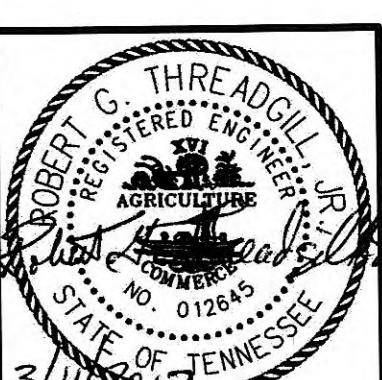
C-1-101



1. REMOVE EXISTING CHAINLINK FENCE AND RETURN MATERIALS TO OWNER FOR REUSE. INSTALL NEW CHAINLINK FENCE AND WALK GATE. (SEE DETAIL ON THIS SHEET).
2. RESTORE GRAVEL ACCESS DRIVE TO APPROX. 4" THICKNESS AS SHOWN.
3. RESTORE GRASSY AREAS BOTH INSIDE AND OUTSIDE FENCE w/SEED & SOD.

LADD PUMP STATION - EXISTING SITE PLAN LADD PUMP STATION - NEW SITE PLAN

PUMP STATION REHABILITATION
CITY OF HARRIMAN, TENNESSEE



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CLIENT PROJECT NO.
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REVISIONS		DESIGNED:	RGT
NO.	DESCRIPTION	DATE	DRAWN
			SH
			REVISED:
			RGT
			APPROVED:
			RGT

THIS MARK SHOULD MEASURE EXACTLY 1" WHEN PLOTTED

DATE: DECEMBER 2012
SCALE: AS NOTED
SHEET NO.

SCALE CHECK


DATE: DECEMBER 2012
SCALE: AS NOTED
SHEET NO.

SCALE CHECK

DATE: DECEMBER 2012
SCALE: AS NOTED
SHEET NO.






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EXISTING McDONALD PUMP STATION DEMOLITION / NEW SITE PLAN AND DETAILS

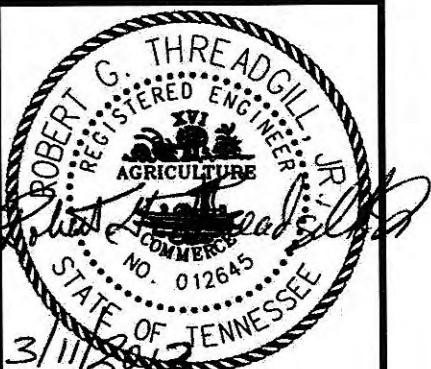PUMP STATION IMPROVEMENTS CITY OF HARRIMAN, TENNESSEE




SERVICE POLE DETAIL

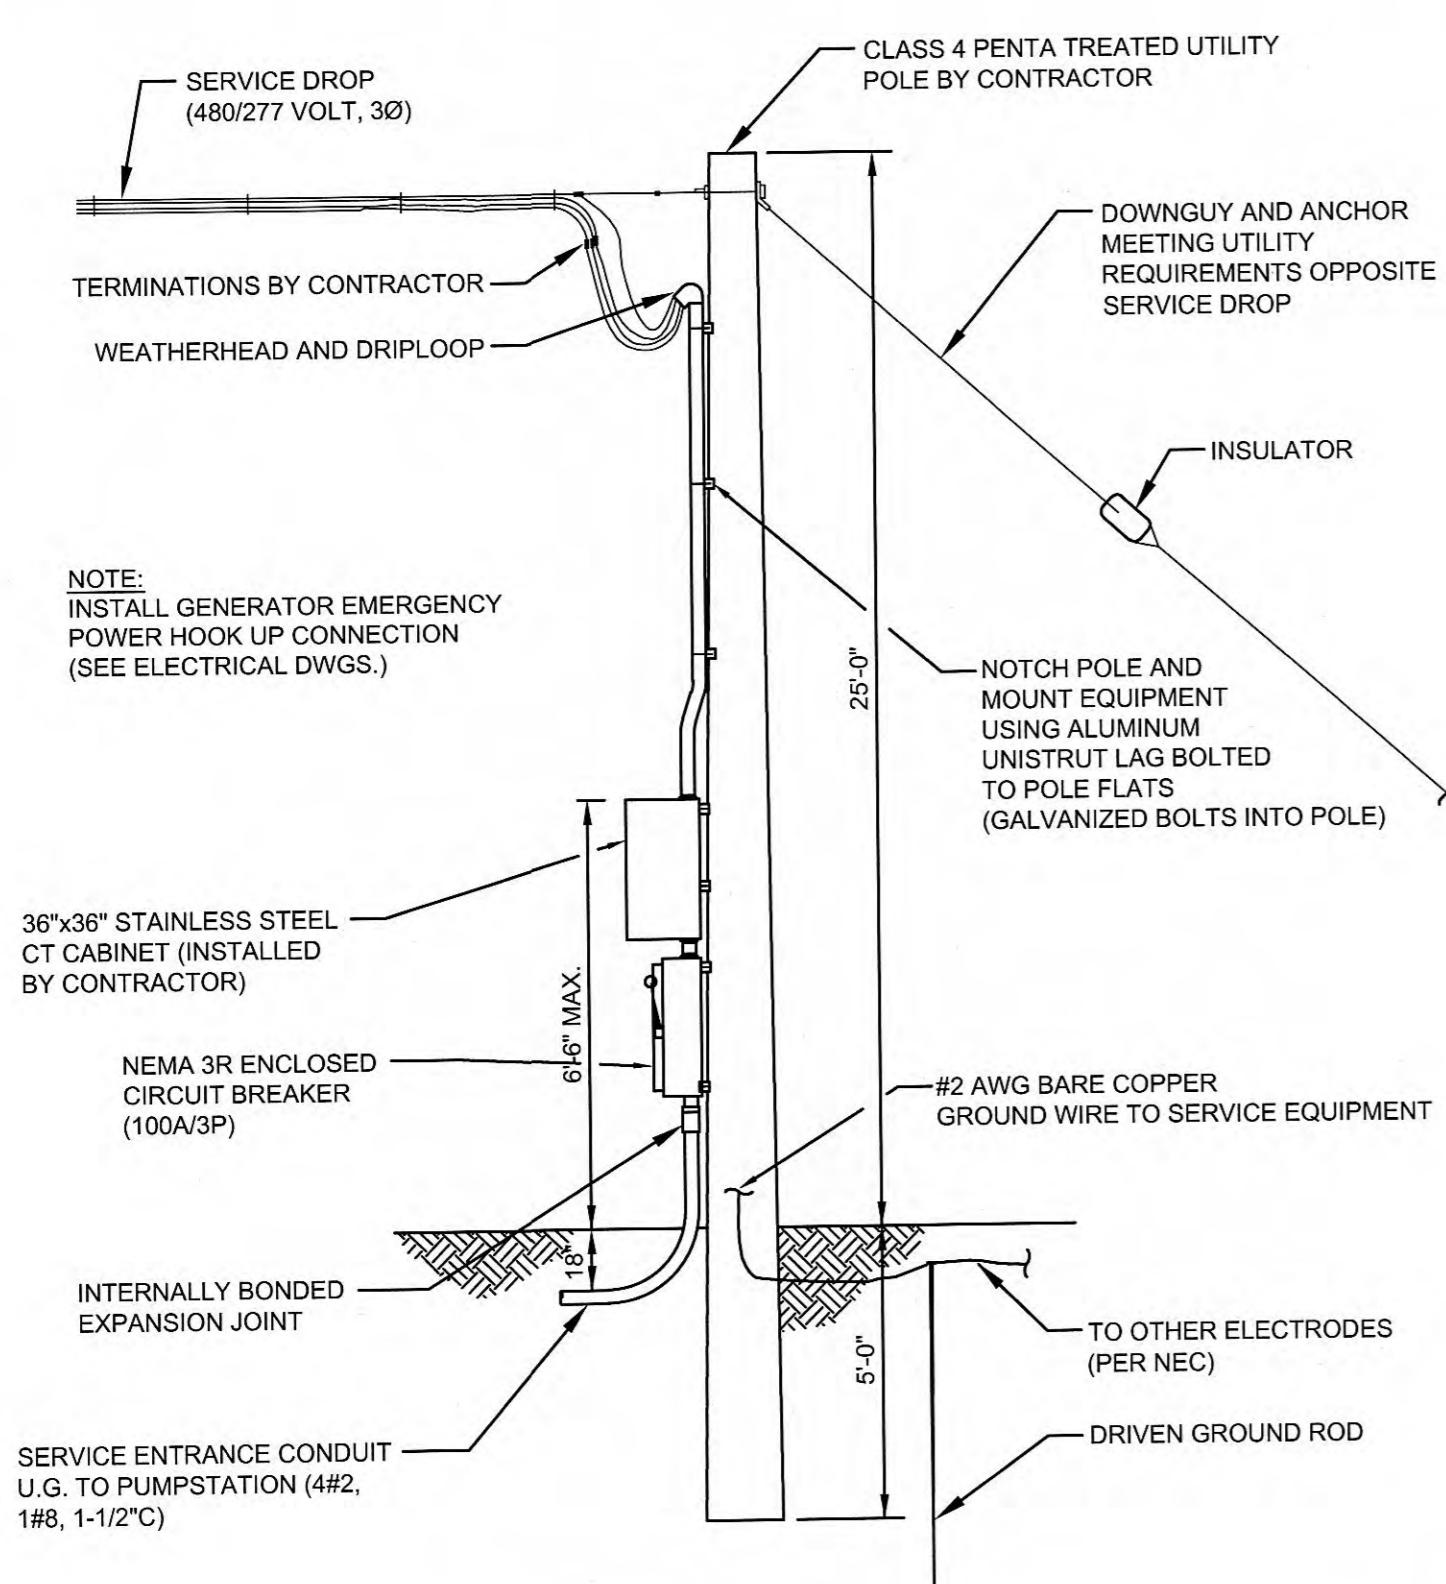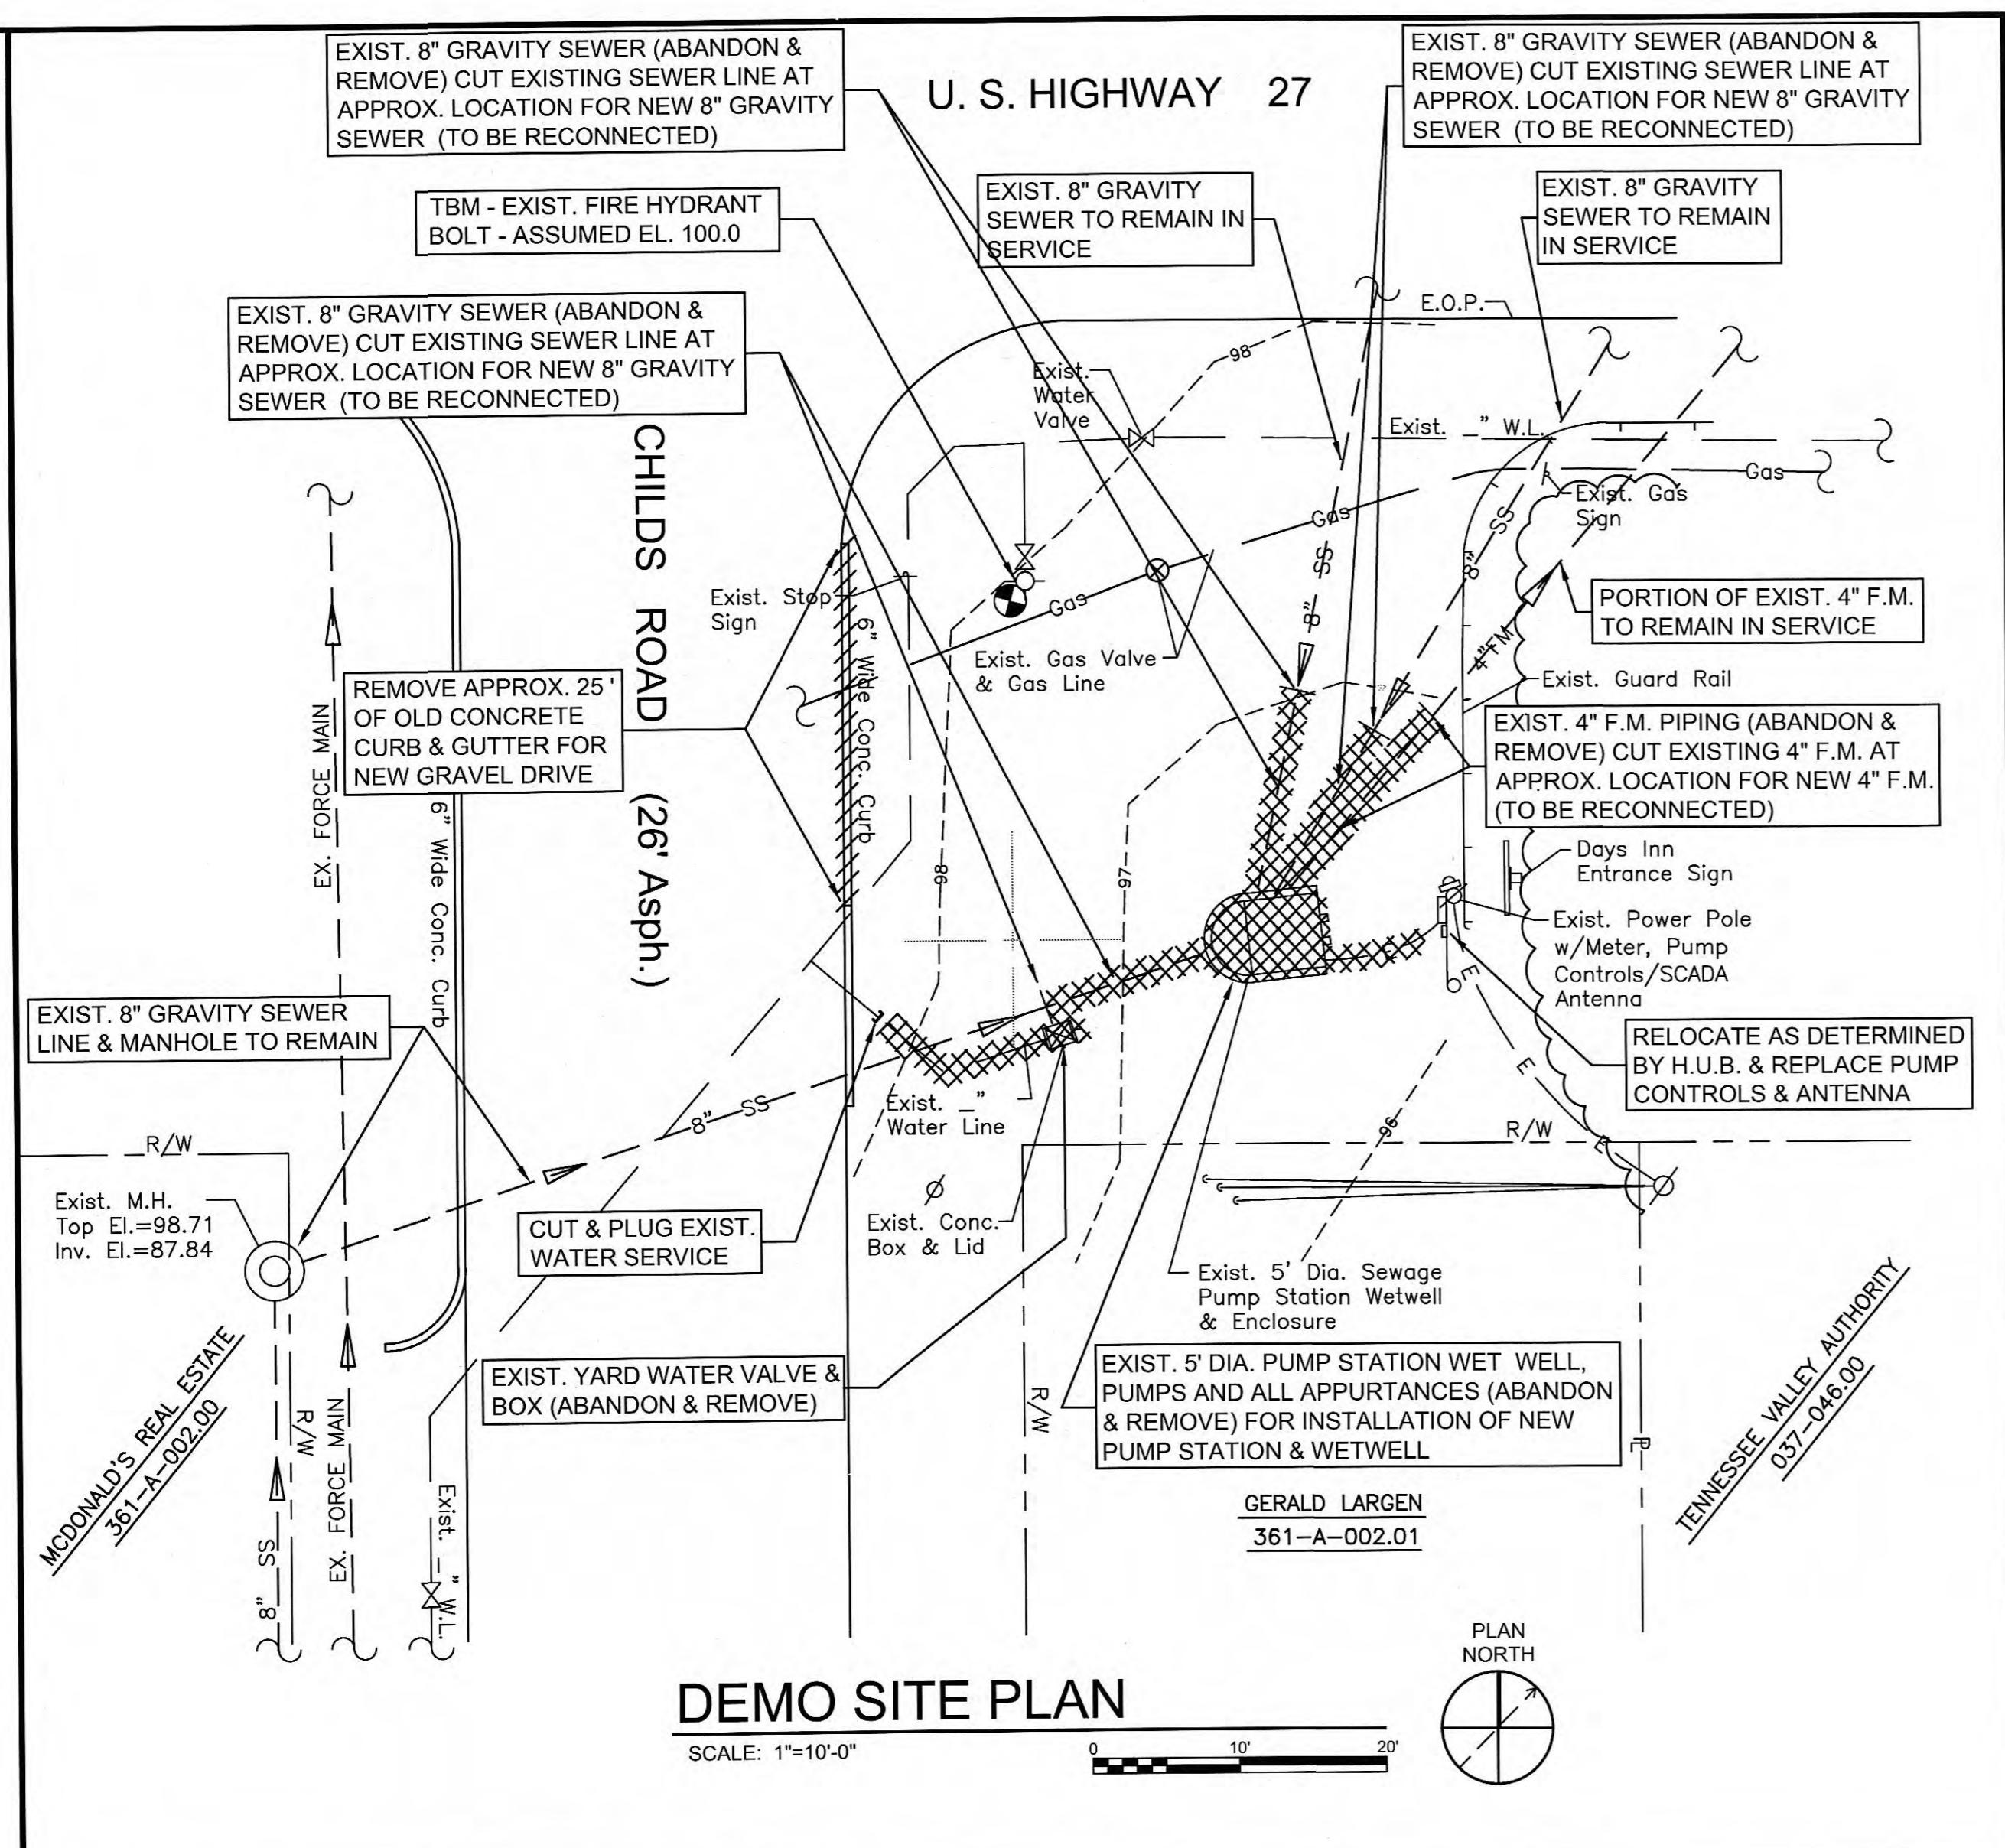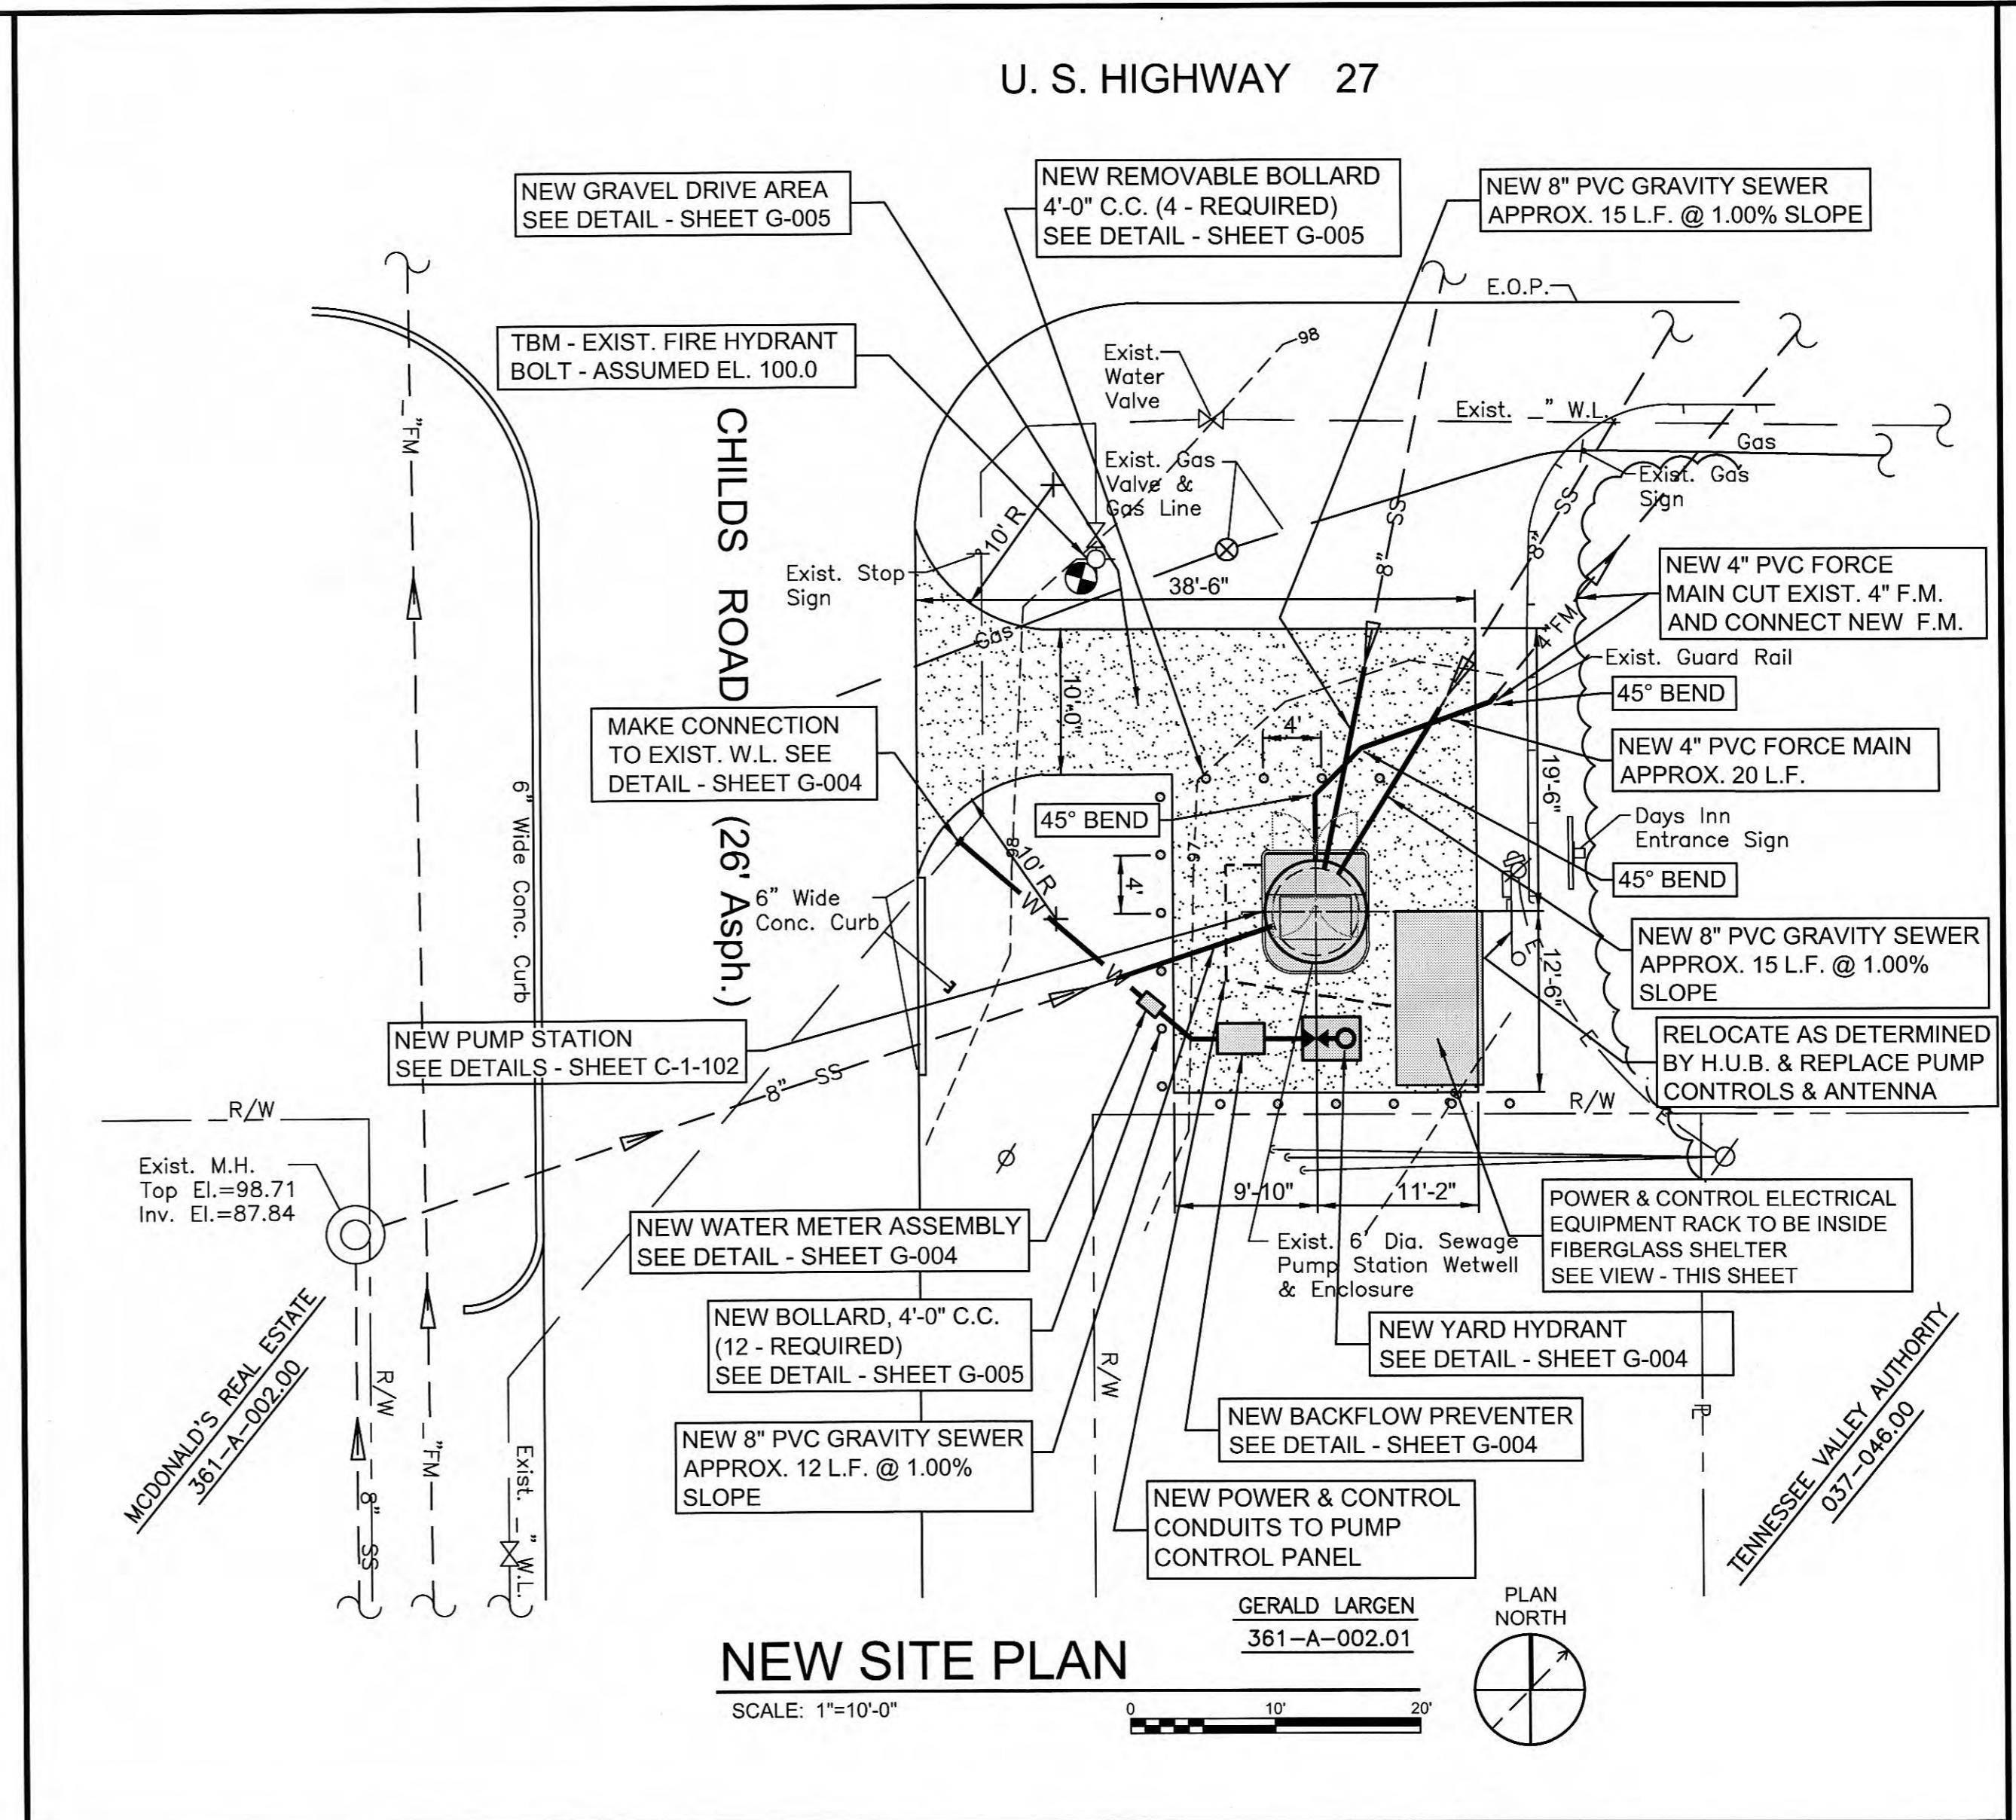CONSTRUCTION NOTE


BEFORE DEMO OF EXISTING PUMP STATION CONTRACTOR SHALL
INSTALL TEMPORARY 4' DIA. MANHOLE AND CONNECTIONS w/BYPASS
PUMPING AND NOT TO DAMAGE OR INTERFERE WITH ALL EXISTING
OVERHEAD AND UNDERGROUND UTILITIES ACCORDINGLY AS SHOWN
ON SHEET C-003.

EXISTING PUMP STATION, WETWELL AND APPURTENANCES SHALL BE
DEMOLISHED AND REMOVED WITH CARE.

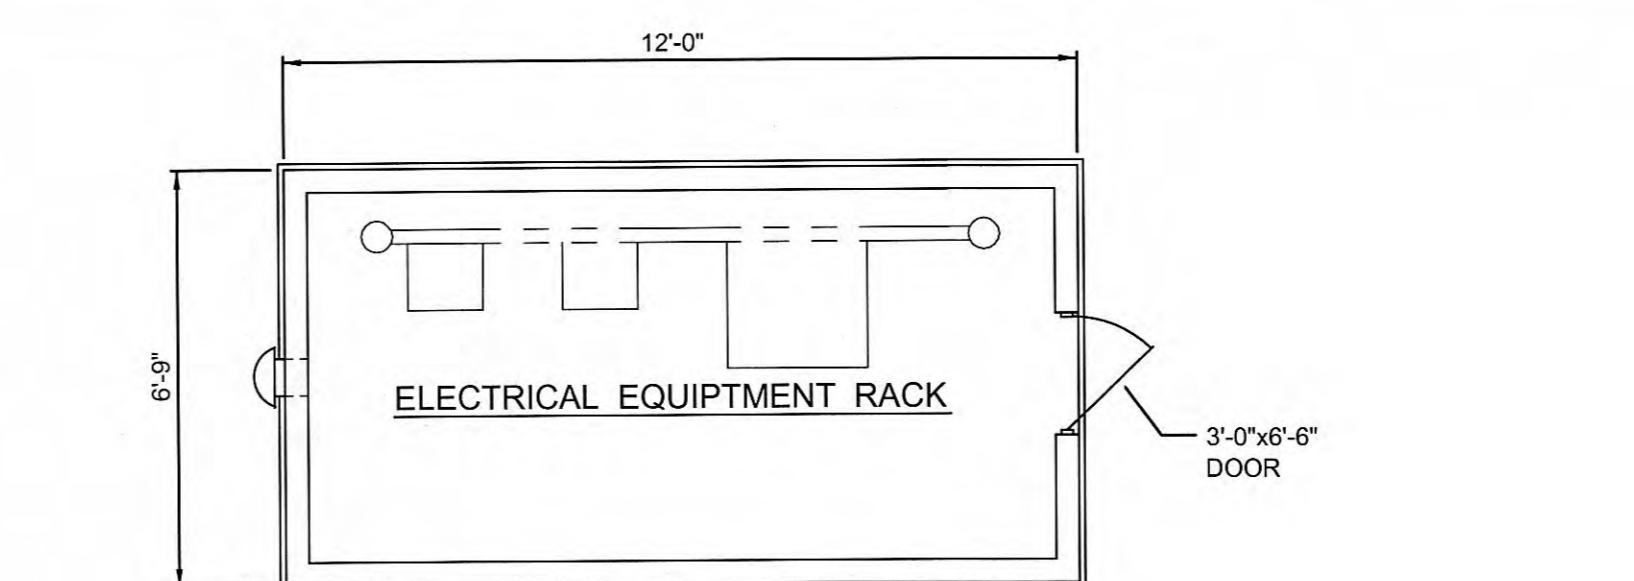THE NEW PUMP STATION WITH THE CENTER OF NEW WETWELL TO BE PLACED AT THE SAME CENTER POINT OF THE EXISTING WETWELL.



SHELTER - PLAN VIEW

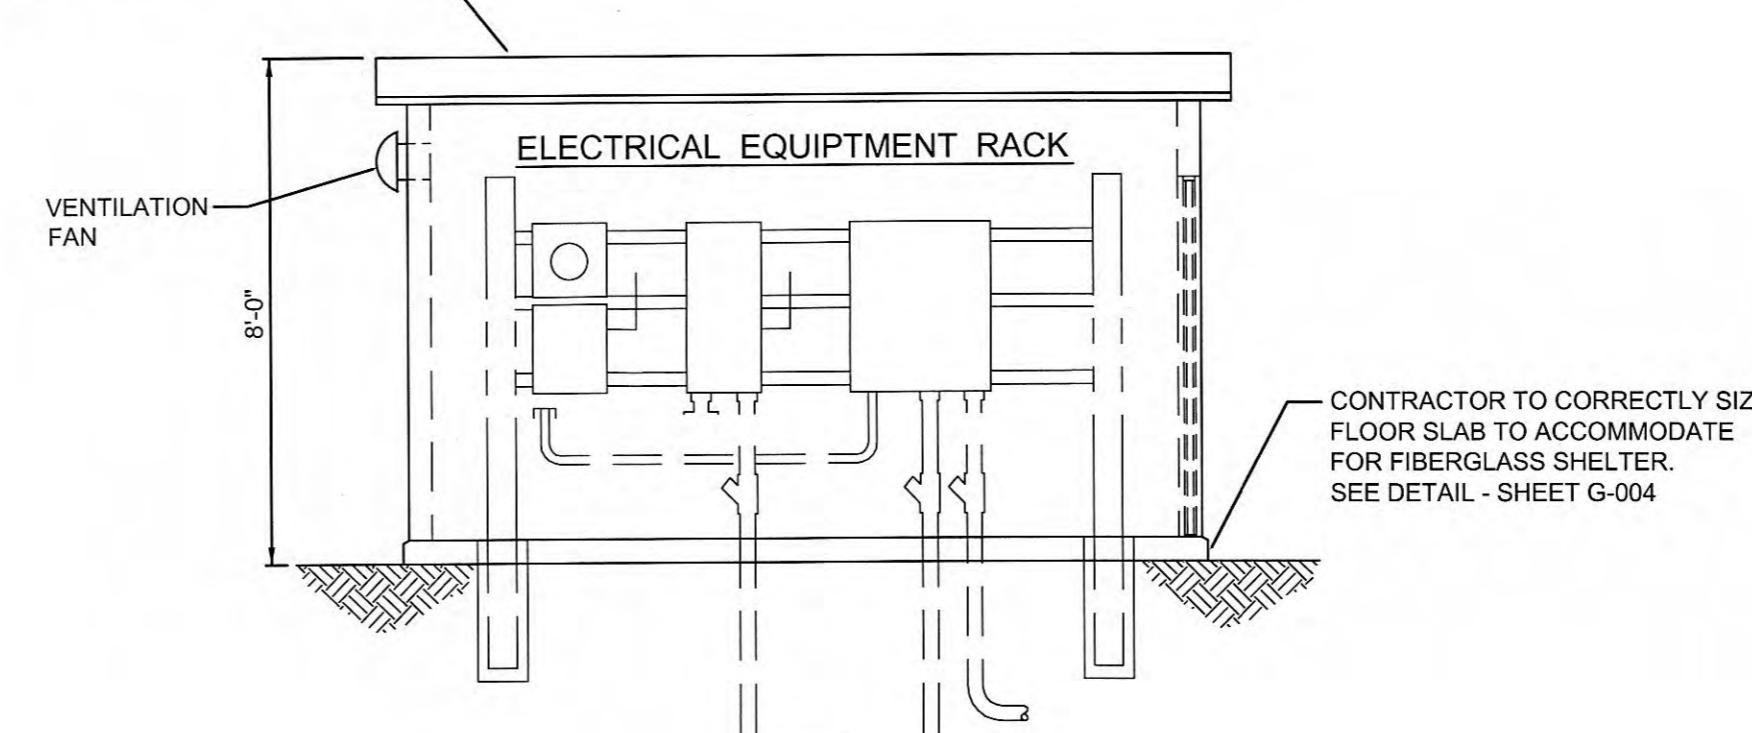

SHELFER - SIDE VIEW



CALL BEFORE YOU DIG

IT IS THE CONTRACTORS RESPONSIBILITY TO CONTACT UTILITIES COMPANIES PRIOR TO ANY CONSTRUCTION. THE LOCATION OF UTILITIES SHOWN ON THESE PLANS ARE APPROXIMATE AND POSSIBLY INCOMPLETE, THEREFORE CERTIFICATION TO THE LOCATION OF ALL UNDERGROUND UTILITIES IS WITHHELD.

IN TENNESSEE DIAL 811
OR 1-800-351-1111
THREE WORKING DAYS BEFORE YOU DIG



GRI

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EXISTING CARDIFF PUMP STATION DEMOLITION / NEW SITE PLAN, GRAVITY LINE PROFILE AND DETAILS PUMP STATION REHABILITATION CITY OF HARRIMAN, TENNESSEE

LEGEND

756	EXISTING CONTOUR
756	NEW CONTOUR
	EXISTING STRUCTURE
	NEW STRUCTURE / POURED IN PLACE CONC.
	EXISTING ASPH. ROAD
	NEW GRAVEL DRIVE
	EXISTING FARM FENCE
	NEW FENCE
	EXISTING POWER POLE
	NEW POWER POLE
— E —	NEW U.G. ELECTRICAL SERVICE
— 8 SS —	EXISTING GRAVITY SEWER
— 6 FM —	NEW GRAVITY SEWER
— NEW 6 FM —	EXISTING FORCE MAIN
XXXXXX	NEW FORCE MAIN
O	EXISTING EQUIPMENT / PIPING TO BE ABANDON OR REMOVED
●	EXISTING MANHOLE
— X —	EXISTING VALVE
■	NEW VALVE

GRW PROJECT NO. 3947-741

CLIENT PROJECT NO.

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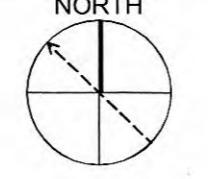
www.gwininc.com

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SITE PLAN

SCALE: 1"=20'-0"

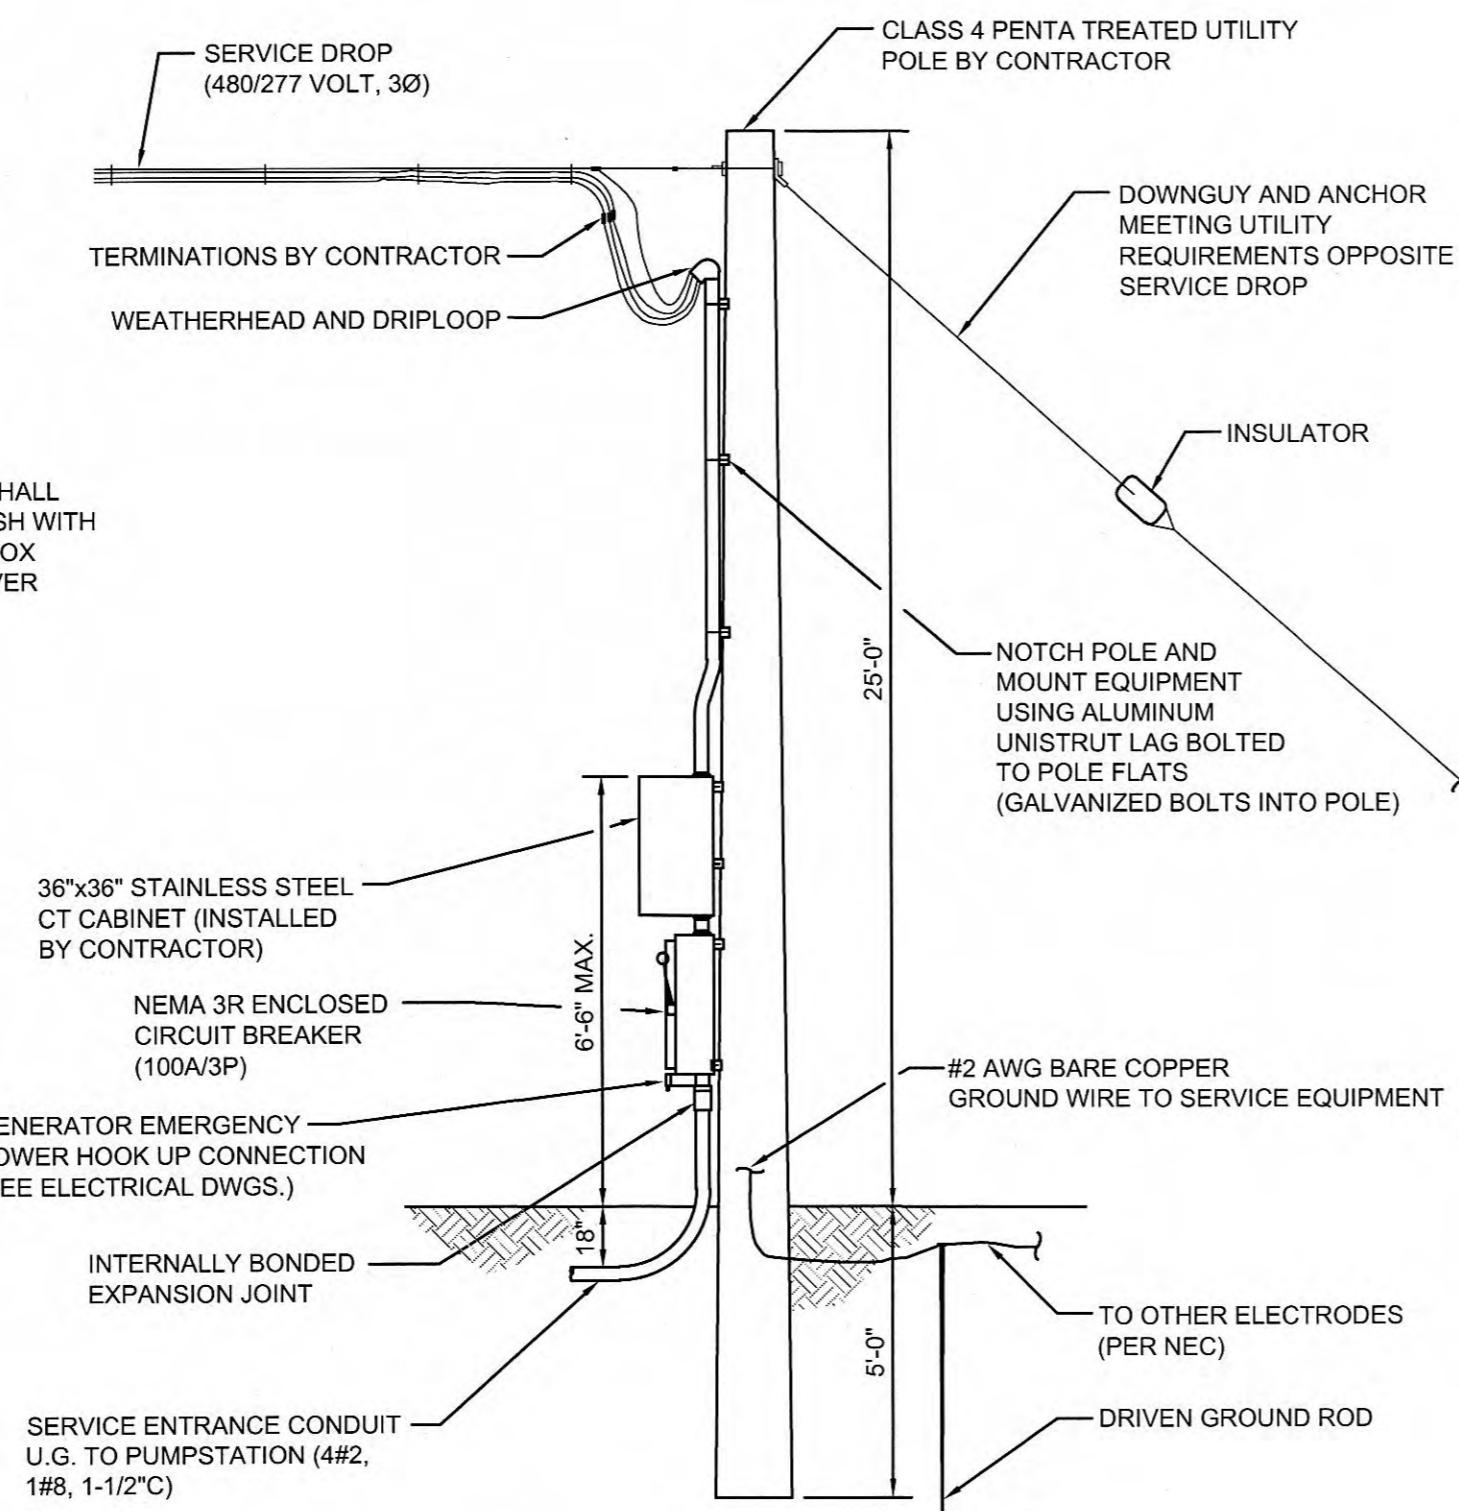
0 20' 40' 60' 80' 100' 120'



PROFILE GRAVITY LINE

SCALE: 1"=20'-0" Vert. 0 20' 40'
1"=2'-0" Horz.

- CONSTRUCTION NOTES:
- 1) CONTRACTOR SHALL LEAVE EXISTING SEWER AND PUMP STATION IN SERVICE UNTIL NEW STATION IS INSTALLED.
 - 2) AFTER NEW STATION IS IN SERVICE CONTRACTOR SHALL DEMOLISH THE EXISTING MANHOLE AND BACKFILL.
 - 3) REMOVED ABOVE GROUND PUMP STATION SHALL BE REMOVED WITH CARE AND PLACED AT LOCATION SELECTED BY THE HARRIMAN UTILITY BOARD. EXISTING PUMP STATION WILL BE USED IN THE FUTURE AT A DIFFERENT LOCATION. CARE SHOULD BE TAKEN NOT TO DAMAGE EXISTING PUMP STATION WHEN DISMANTLING OR TRANSPORTING.
 - 4) EXISTING ABOVE GROUND PUMP STATIONS CONCRETE SLAB TO BE DEMOLISH & REMOVED
 - 5) EXISTING OLD BELOW GROUND WETWELL, PUMP STATION AND ENTRANCE TUBE SHALL BE FILLED WITH EXCAVATED MATERIAL FROM NEW WETWELL.
 - 6) THE EXISTING OVERFLOW PIPE AND HEADWALL SHALL BE ABANDONED.
 - 7) AT NEW PRECAST BOX CULVERT CONTRACTOR SHALL ADJUST DRAINAGE DITCH BOTTOM TO FLOW FLUSH WITH UPPER AND LOWER INVERTS OF NEW PRECAST BOX CULVERT. CONTRACTOR NEEDS MIN. 2'-0" OF COVER ON TOP OF NEW PRECAST BOX CULVERT.



EMERGENCY CONNECTION DETAIL

SCALE: 1/2"-1'-0"
0 1' 2' 4'

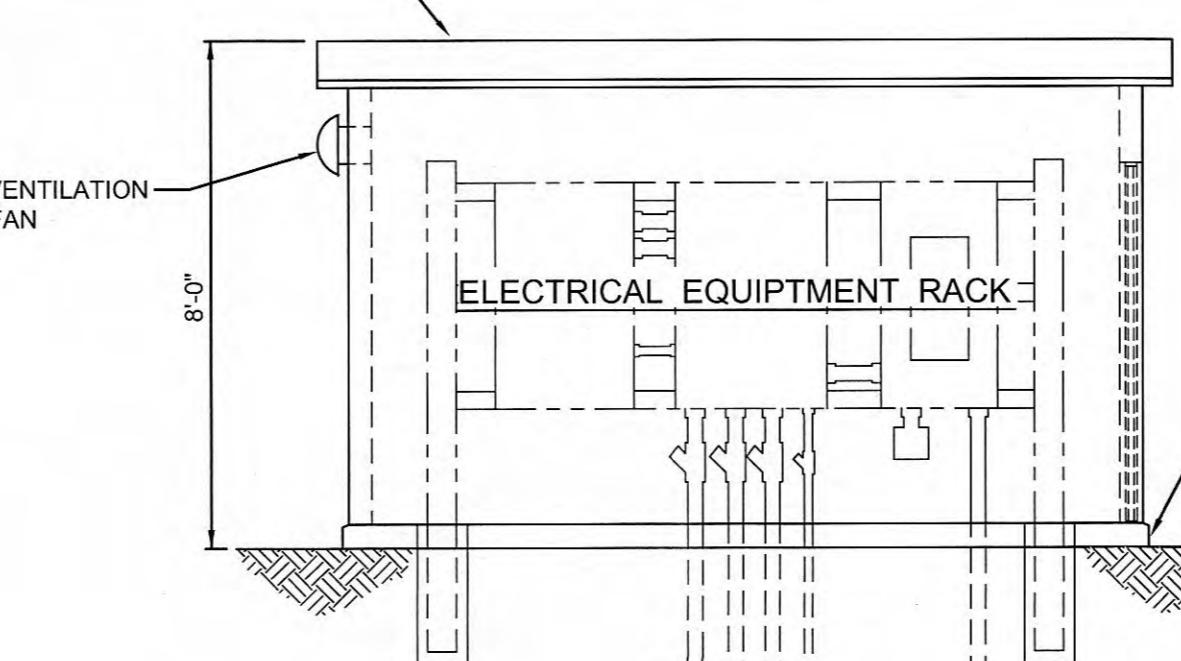
SERVICE POLE DETAIL

NOT TO SCALE

FIBERGLASS SHELTER FOR ELECTRICAL EQUIPMENT RACK - WARMINSTER


7'-9" x 14'-0" OR APPROVED EQUAL.

NOT TO SCALE



SHELTER - SIDE VIEW

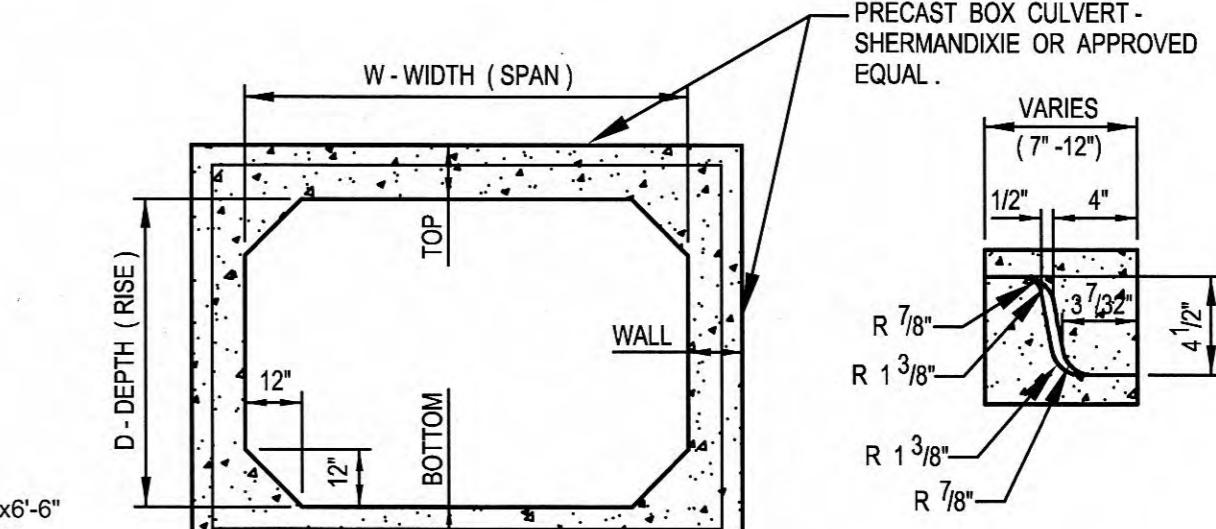NOT TO SCALE



ASTM C-850 PRECAST BOX (0'-2" OF COVER)
OR ASTM C-1433 (LATEST REVISION)

SECTION VIEW

SIZE W x D	TOP SLAB	BOTTOM & WALLS	WT./ 6' SECT.	AREA (SQ. FT.)
6' x 3'	8"	7"	2,170	13,020

BOX CULVERT DETAIL

NOT TO SCALE



CALL BEFORE YOU DIG

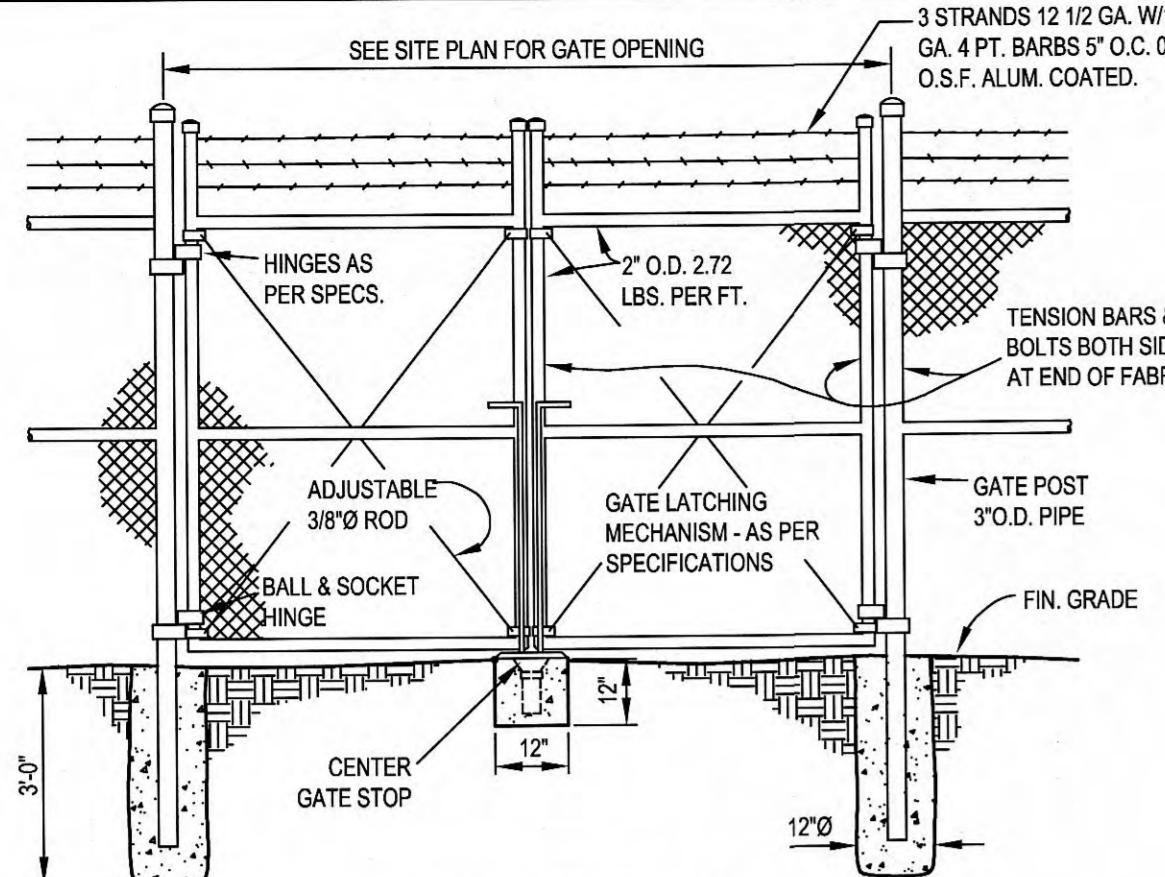
IT IS THE CONTRACTOR'S RESPONSIBILITY TO CONTACT UTILITY COMPANIES PRIOR TO ANY CONSTRUCTION. THE LOCATION OF UNDERGROUND UTILITIES IS UNKNOWN AND CAN BE POSSIBLY INCOMPLETE. THEREFORE CERTIFICATION TO THE LOCATION OF ALL UNDERGROUND UTILITIES IS WITHHELD.

IN TENNESSEE DIAL 811
OR 1-800-351-1111
THREE WORKING DAYS BEFORE YOU DIG


AS NOTED

SHEET NO.


C-0-101




GATE DETAIL

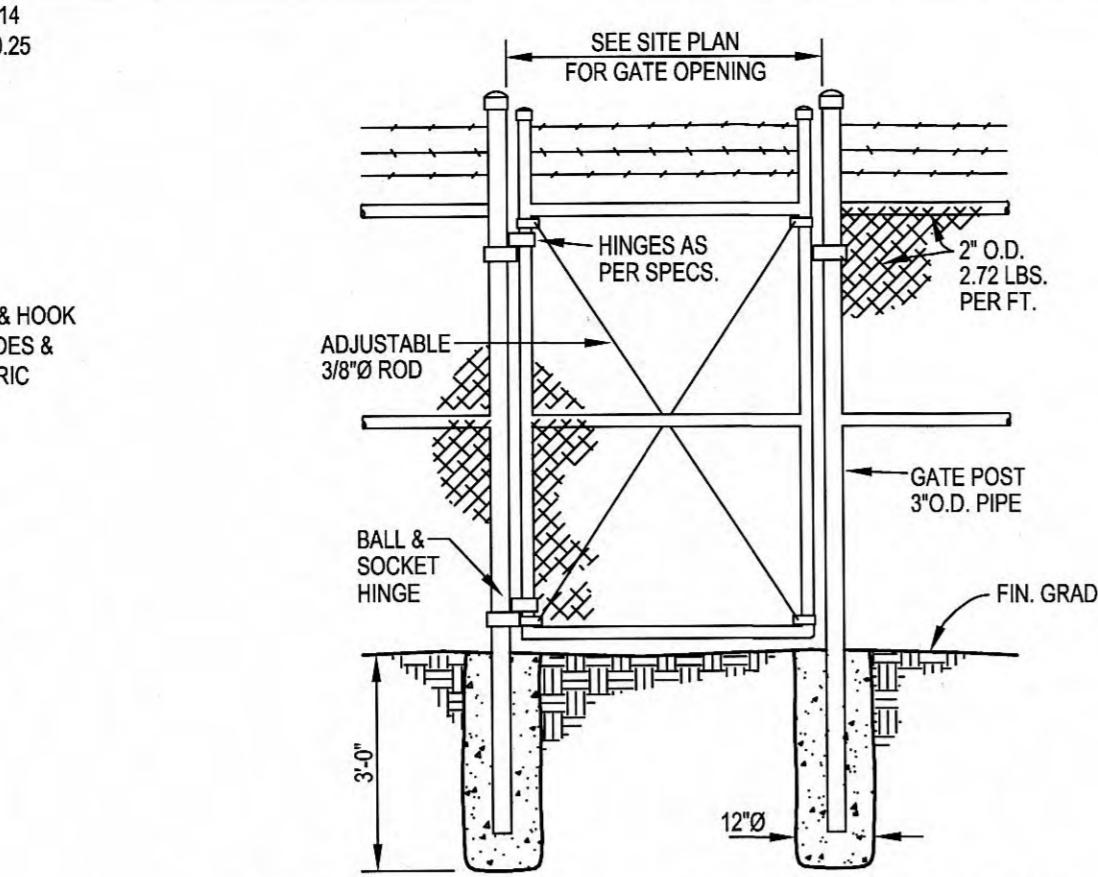


PEDESTRIAN GATE DETAIL

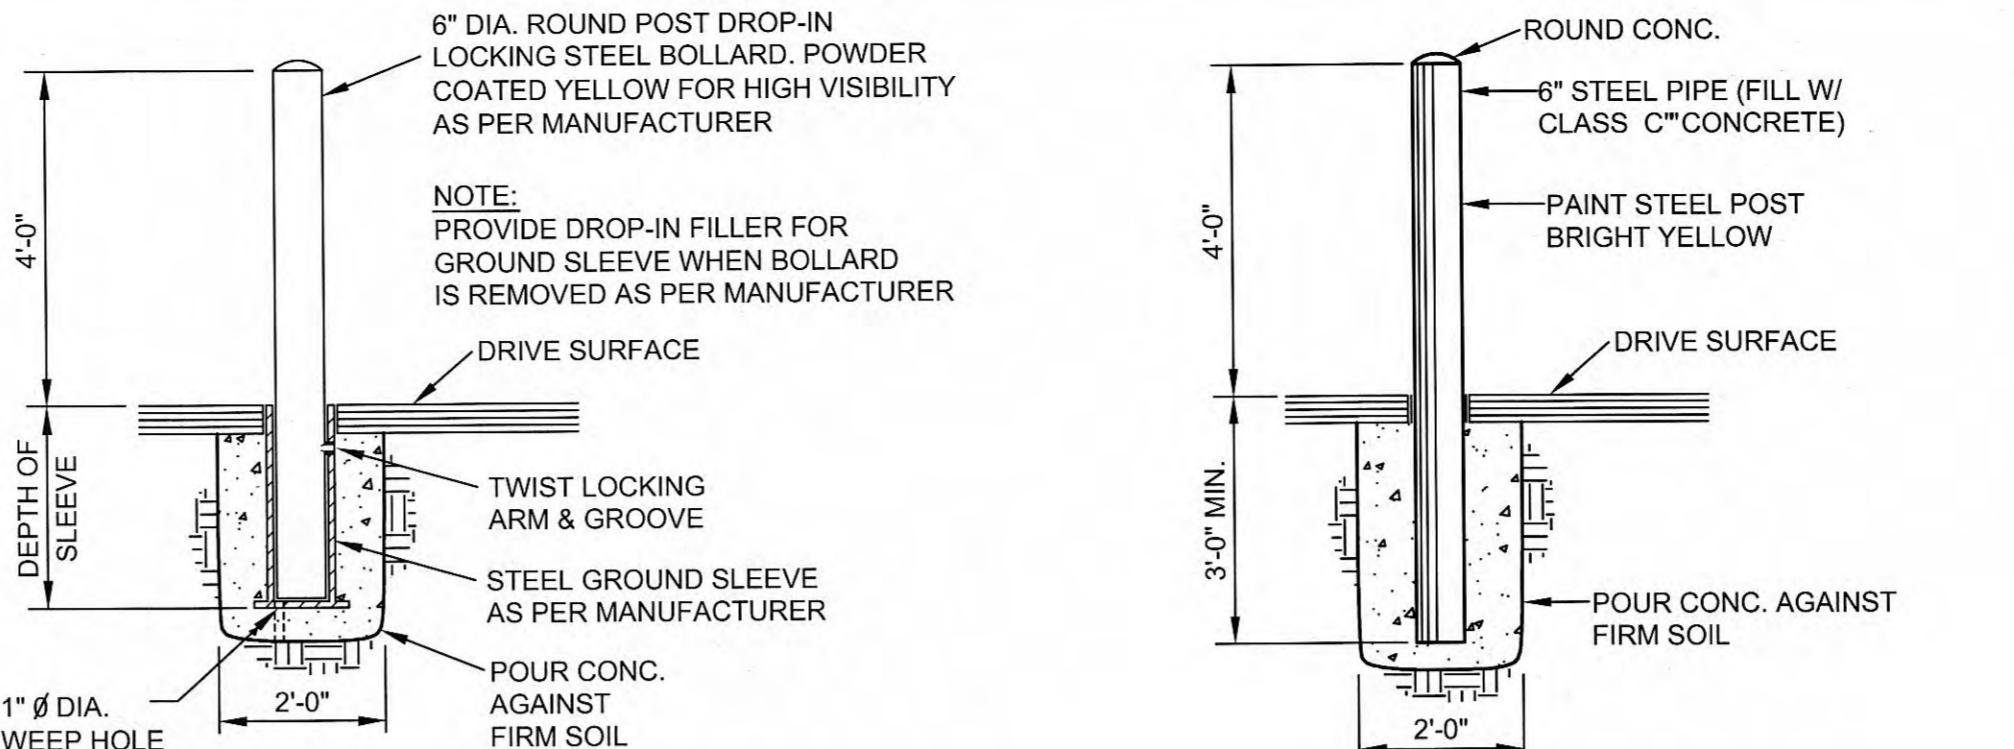


REMOVABLE BOLLARD DETAIL

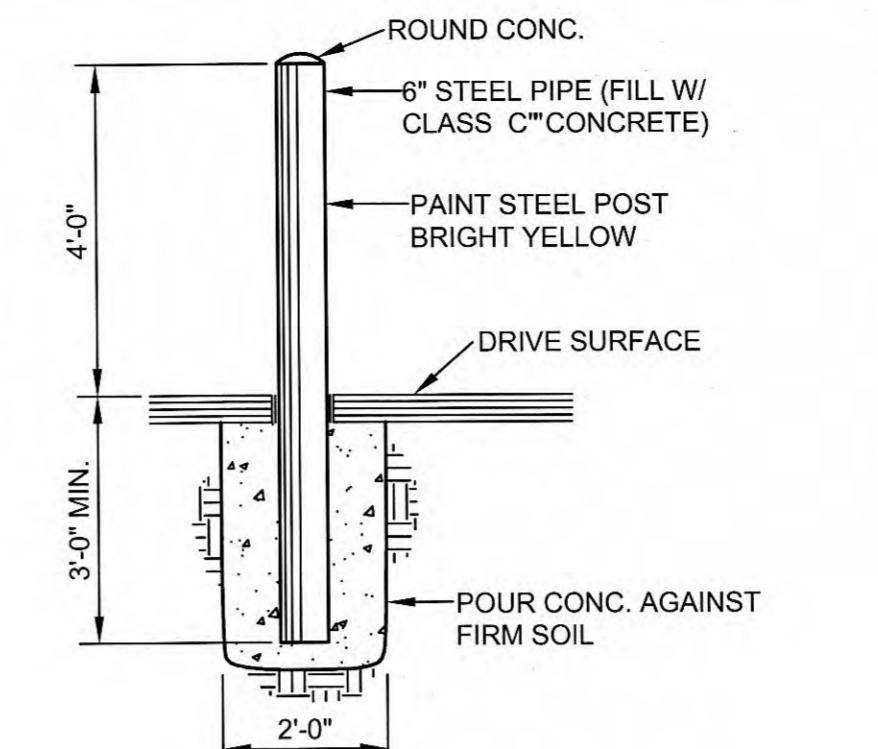


BOLLARD DETAIL

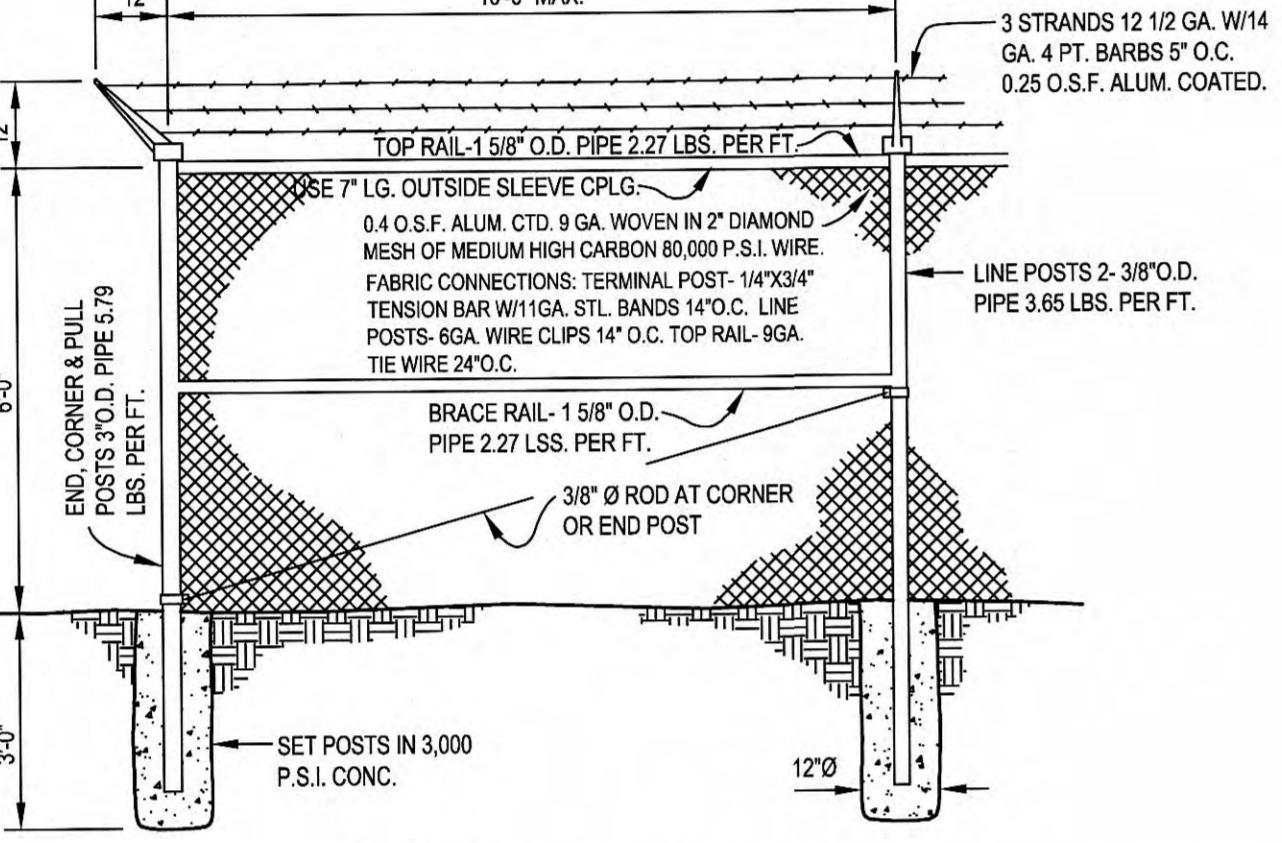


FENCE DETAIL

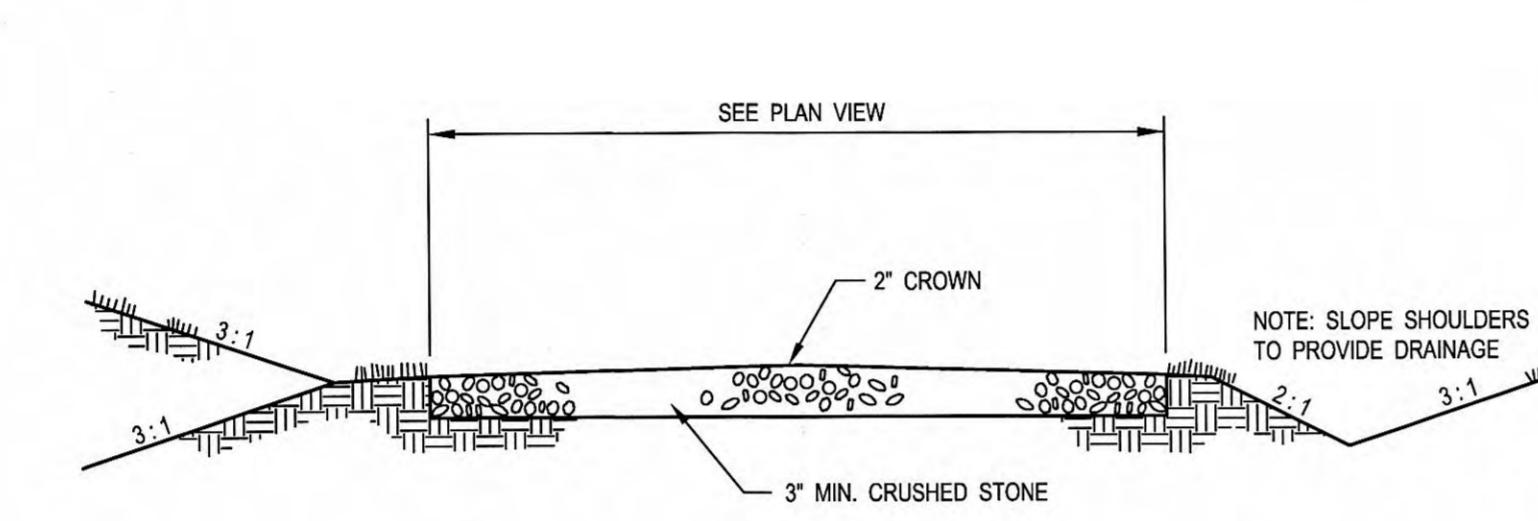

GRAVEL PARKING AREA AND DRIVE DETAIL

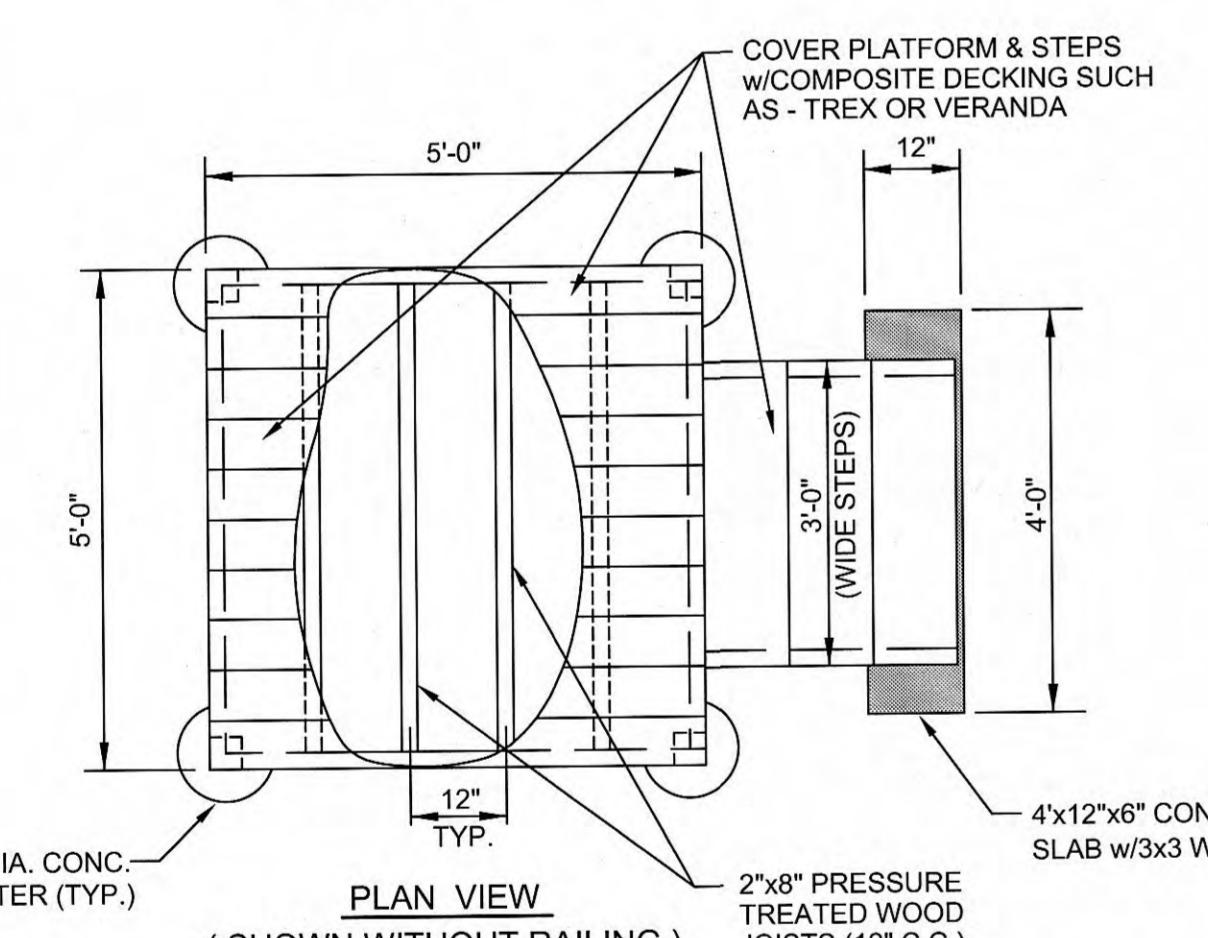


PAVED PARKING AREA AND DRIVE DETAIL

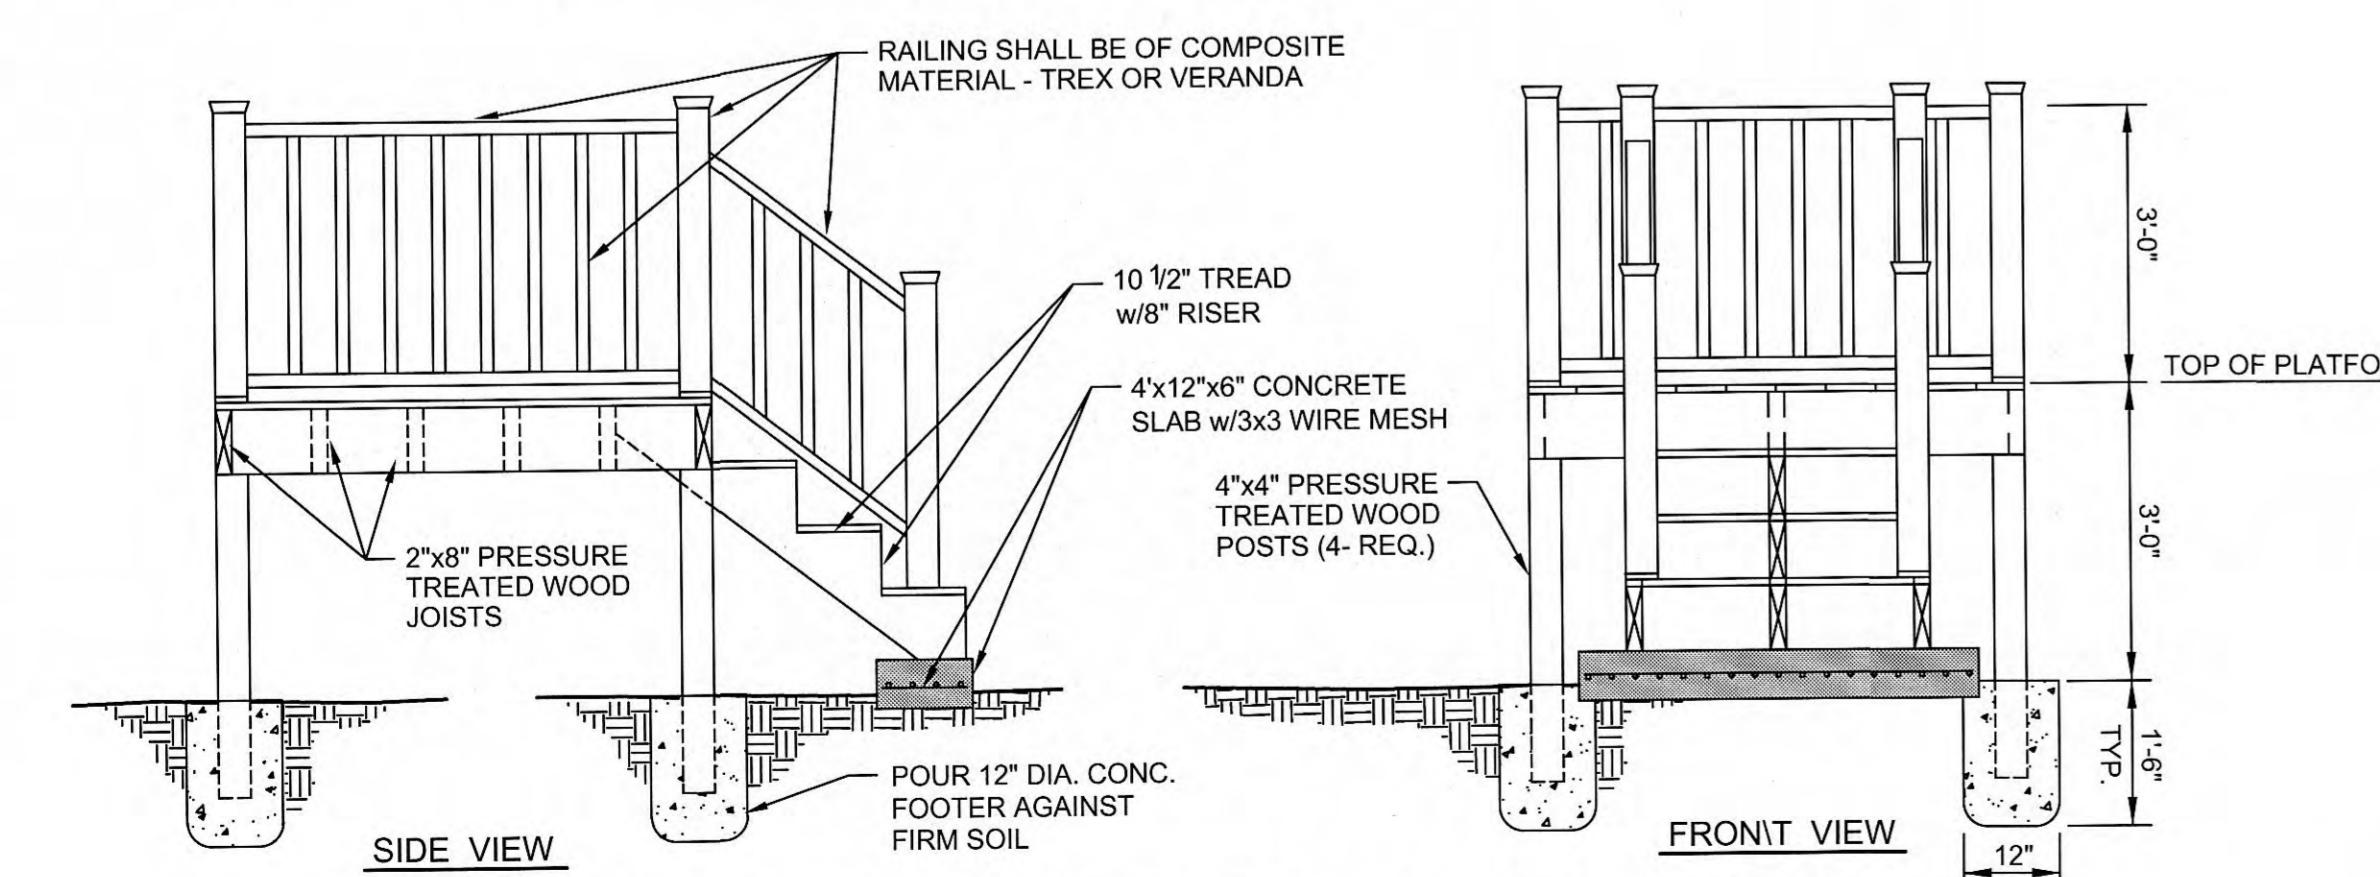

PRESSURE TREATED EXTERIOR PLATFORM

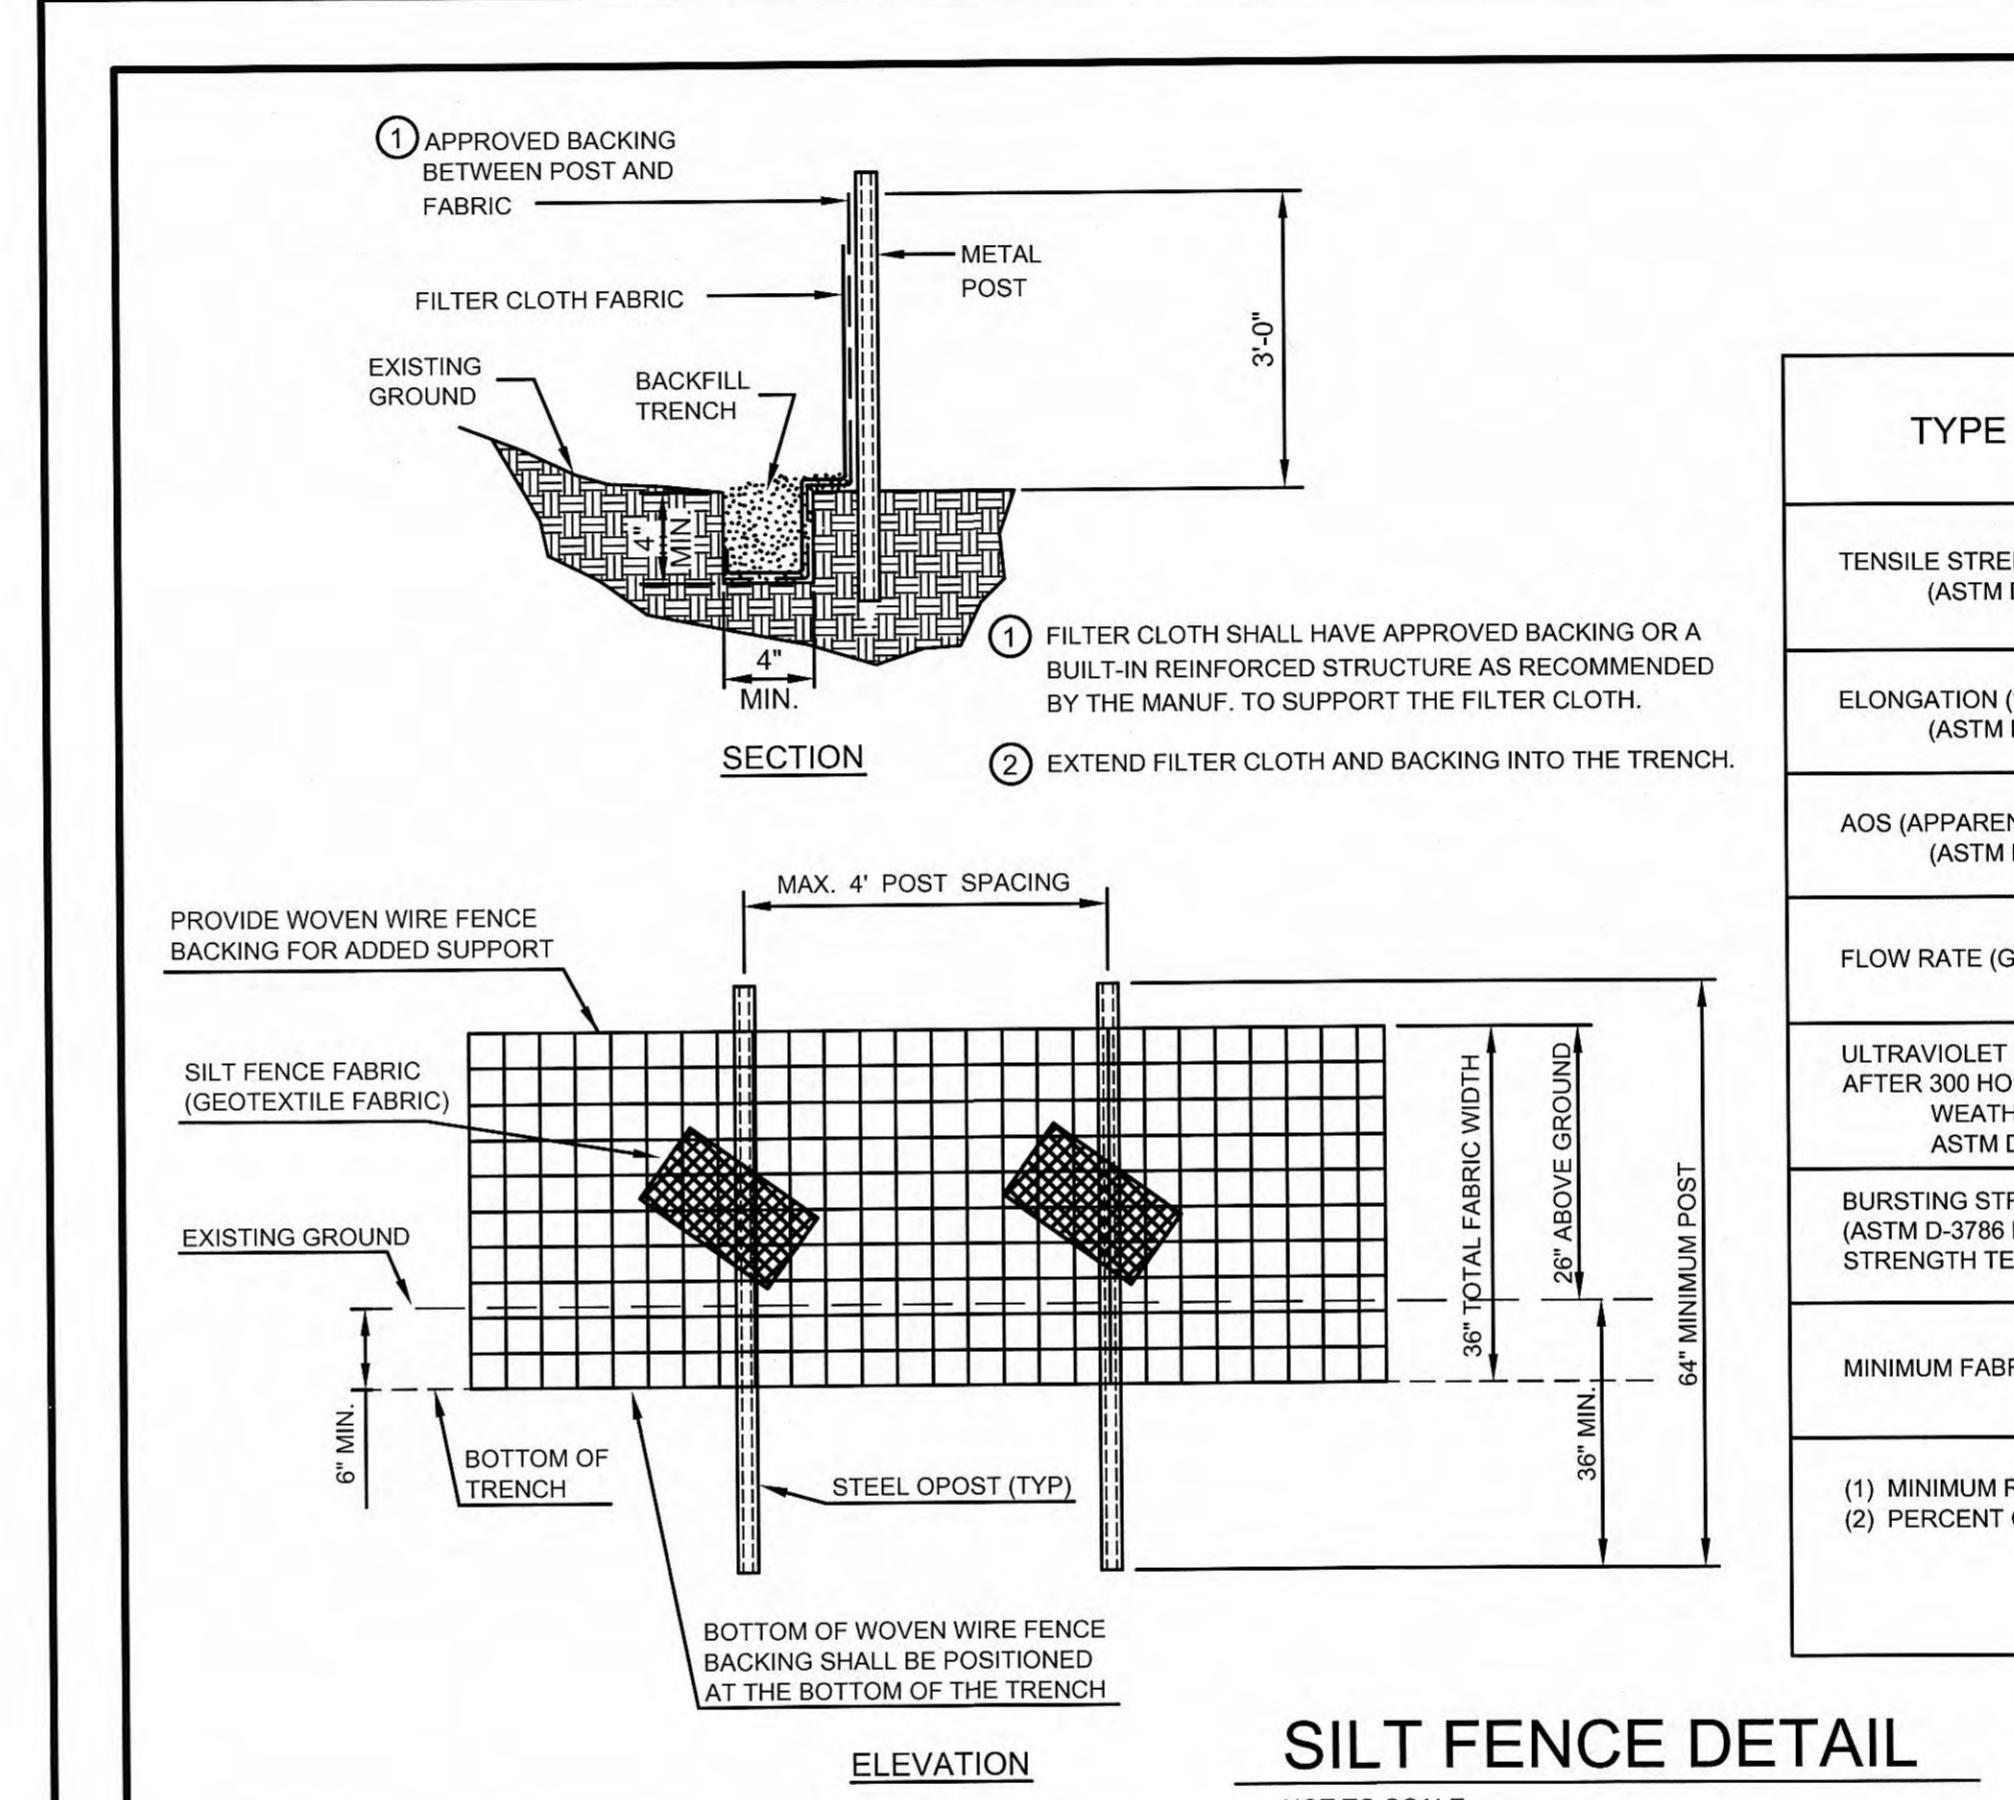SITE DETAILS



SILT FENCE SPECIFICATIONS


TYPE FENCE	A	B	C
TENSILE STRENGTH (LBS. MIN.) (1) (ASTM D-4632)	WARP - 120 FILL - 100	WARP - 120 FILL - 100	WARP - 260 FILL - 180
ELONGATION (% MAX.) (ASTM D-4632)	40	40	40
AOS (APPARENT OPENING SIZE) (ASTM D-4751)	#30	#30	#30
FLOW RATE (GAL/MIN/SQ. FT.) (GDT-87)	25	25	70
ULTRAVIOLET STABILITY (2) AFTER 300 HOURS WEATHERING IN ACCORDANCE WITH ASTM D-4355	80	80	80
BURSTING STRENGTH (PSI MIN.) (ASTM D-3786 DIAPHRAGM BURSTING STRENGTH TESTER)	175	175	175
MINIMUM FABRIC WIDTH (INCHES)	36	22	36

(1) MINIMUM ROLL AVERAGE OF FIVE SPECIMENS.
(2) PERCENT OF REQUIRED INITIAL MINIMUM TENSILE STRENGTH.

SILT FENCE DETAIL

EROSION & SEDIMENT CONTROL NOTES:

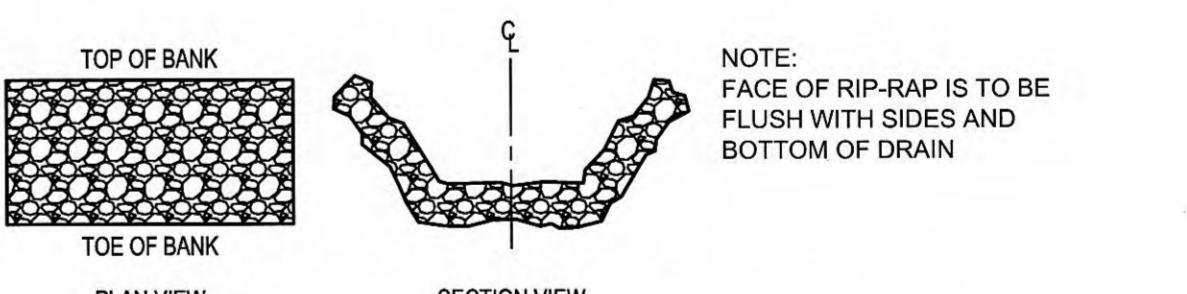- ALL WORK SHALL BE DONE IN ACCORDANCE WITH THE STORM WATER POLLUTION PREVENTION PLAN (SWPPP).
- NO WORK MAY PROCEED UNTIL A NOTICE OF COVERAGE (NOC) HAS BEEN ISSUED BY THE STATE OF TENNESSEE DEPARTMENT OF ENVIRONMENT AND CONSERVATION.
- THE SWPPP SHALL BE AVAILABLE AT THE SITE FOR REVIEW AT ALL TIMES.
- AT A MINIMUM, THE CONTRACTOR SHALL INSTALL SILT FENCE ON THE DOWNSHILL SIDE OF THE PROPOSED CONSTRUCTION AREA.
- CONTRACTOR SHALL PROVIDE DITCH CHECKS AS REQUIRED.
- CONTRACTOR SHALL FURNISH AND INSTALL TEMPORARY EROSION CONTROL BLANKET/MATTING ON ALL SLOPES GREATER THAN 4:1 UNLESS NOTED OTHERWISE.
- ALL AREAS TO REMAIN BARE MORE THAN 15 DAYS SHALL BE TEMPORARILY STABILIZED IN ACCORDANCE WITH THE CURRENT BEST MANAGEMENT PRACTICES (BMPs).
- TDEC REGULATIONS REQUIRE THAT STABILIZATION MEASURES BE INITIATED WITHIN 7 DAYS AFTER CONSTRUCTION OR LAND DISTURBANCE ACTIVITIES HAVE BEEN TEMPORARILY OR PERMANENTLY TERMINATED.
- THE ONLY EXCEPTIONS, FOR NOTE 8, ARE FOR CASES WHERE SNOW COVER, FROZEN GROUND, OR EXCESSIVELY WET CONDITIONS PRECLUDE INITIATION OF STABILIZATION OR WHERE LAND DISTURBANCE ACTIVITIES WILL BE RESUMED ON THAT PORTION OF THE SITE WITHIN 15 DAYS.
- EROSION CONTROL MEASURES SHALL BE CHECKED AND REPAIRED IF NECESSARY AT LEAST TWICE EACH CALENDAR WEEK IN ACCORDANCE WITH THE SWPPP.
- ALL EROSION CONTROL MEASURES UTILIZED WITHIN STATE OF TENNESSEE ROW'S SHALL MEET OR EXCEED THE TDOT REQUIREMENTS.
- EROSION AND SEDIMENT CONTROL MEASURES AND STRUCTURES SHALL BE INSPECTED TWICE A WEEK 72 HOURS APART.




NOTE: FACE OF RIP-RAP IS TO BE FLUSH WITH SIDES AND BOTTOM OF DRAIN

RIP-RAP STABILIZATION WHERE NOTED WILL CONSIST OF HAND-PLACED NATIVE LIMESTONE, HAVING A MAXIMUM LENGTH/WIDTH DIMENSION OF 12" IN EITHER DIRECTION AND A MAXIMUM THICKNESS OF 6". TREATMENT WILL BE PLACED IN TWO INTERLOCKING (NESTING) LAYERS. RIP-RAP SHALL BE PLACED FOR THE FULL WIDTH OF AREA DISTURBED BY PIPE LAYING OPERATIONS. LIMIT OF WIDTH FOR PAYMENT OF RIP-RAP SHALL BE AS FOLLOWS:

PIPE DIAMETER	RIP-RAP WIDTH
8"	5'
10"	5.5'
12"	6'
15-16"	8'
18"	8.5'
21"	9'
24"	10'

RIP - RAP DETAIL

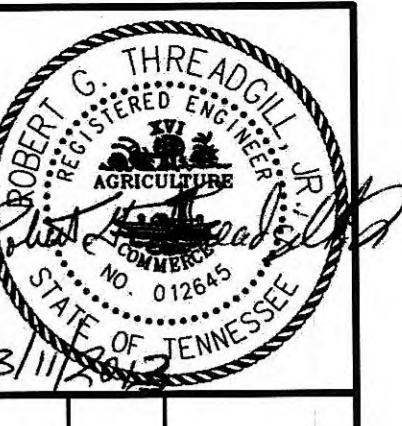EROSION DETAILS



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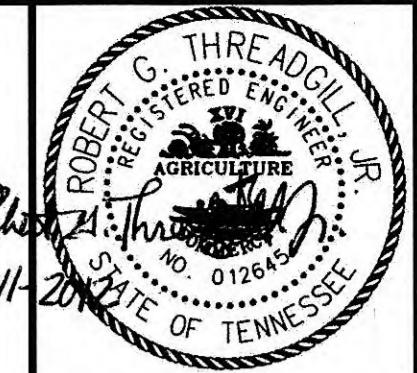


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STANDARD SITE DETAILS AND
EROSION DETAILS
PUMP STATION REHABILITATION
CITY OF HARRIMAN, TENNESSEE

REVISIONS
DATE: DECEMBER 2012
SCALE: AS NOTED
SHEET NO.: G-005
THIS DRAWING SHOULD BE READ FROM BACK TO FRONT
SCALE CHECK

G-005



GRW/PROJECT NO.	3947-01
CLIENT PROJECT NO.	

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PUMP STATION REHABILITATION CITY OF HARRIMAN, TENNESSEE

STANDARD PRESSURE PIPE DETAILS

90° BEND							
SIZE	16"	12"	10"	8"	6"	4"	2"
A	85	67	60	54	42	34	30
B	85	67	60	54	42	34	18
C	80	63	56	50	38	30	16
D	76	66	60	48	48	36	24

45° BEND							
SIZE	16"	12"	10"	8"	6"	4"	2"
A	72	60	50	46	35	30	24
B	72	60	50	46	35	28	24
C	68	56	46	42	30	24	18
D	72	60	60	48	48	36	24

22 1/2° BEND							
SIZE	16"	12"	10"	8"	6"	4"	2"
A	58	50	42	38	30	24	18
B	58	48	42	38	30	24	18
C	54	44	38	34	26	20	14
D	60	48	48	36	36	30	24

11 1/4° BEND							
SIZE	16"	12"	10"	8"	6"	4"	2"
A	42	36	30	29	24	20	18
B	42	36	30	29	24	20	18
C	38	32	26	24	20	16	14
D	60	48	48	36	30	24	24

DIMENSIONS ARE IN INCHES							
--------------------------	--	--	--	--	--	--	--

NOTES:							
1. THRUST BLOCKS DESIGNED FOR 200 PSI PRESSURE AND 2000 PSI SOIL BEARING. FOR GREATER PRESSURE OR LESS SOIL BEARING QUANTITIES WILL HAVE TO BE RECALCULATED.							
2. THRUST BLOCKING TO BE POURED AGAINST UNDISTURBED EARTH.							
3. IF EXACT SIZE PIPE BLOCKING IS NOT SHOWN, USE NEXT LARGER SIZE.							
4. THRUST BLOCKING TO BE POURED IN PLACE CLASS "C" CONCRETE.							

TYPICAL SECTION							
A	8	4	12	12	12	12	12

DIMENSIONS ARE IN INCHES

90° BEND							
SIZE	16"	12"	10"	8"	6"	4"	2"
A	84	60	51	42	32	24	18
B	72	60	51	42	32	24	18
C	30	18	16	12	12	9	9
D	34	30	24	17	13	9	9

45° BEND							
SIZE	16"	12"	10"	8"	6"	4"	2"
A	58	43	38	32	24	18	12
B	58	43	38	32	24	18	12
C	24	16	14	12	10	8	8
D	24	18	15	12	9	6	6


22 1/2° BEND							
SIZE	16"	12"	10"	8"	6"	4"	2"
A	42	32	27	24	18	12	9
B	42	32	27	24	18	12	9
C	18	16	14	12	10	8	8
D	18	13	11	9	6	4	4



11 1/4° BEND							
SIZE	16"	12"	10"	8"	6"	4"	2"
A	30	24	21	17	12	9	9
B	30	24	21	17	12	9	9
C	18	16	14	12	10	8	8
D	12	9	8	6	5	4	4

PLUG							
SIZE	16"	12"	10"	8"	6"	4"	2"
A	66	52	43	34	27	20	18
B	66	52	43	34	43	26	26
C	30	12	12	12	12	12	12
D	44	32	22	15	11	11	11

TEE							
SIZE	MAIN	12"	12"	12"	12"	6"	2"
BRANCH	16"	12"	8"	6"	10"	6"	2"
A	66	52	43	34	43	26	26
B	66	52	43	34	43	26	26
C	30	12	12	12	12	12	12
D	30	26	21	14	21	13	13

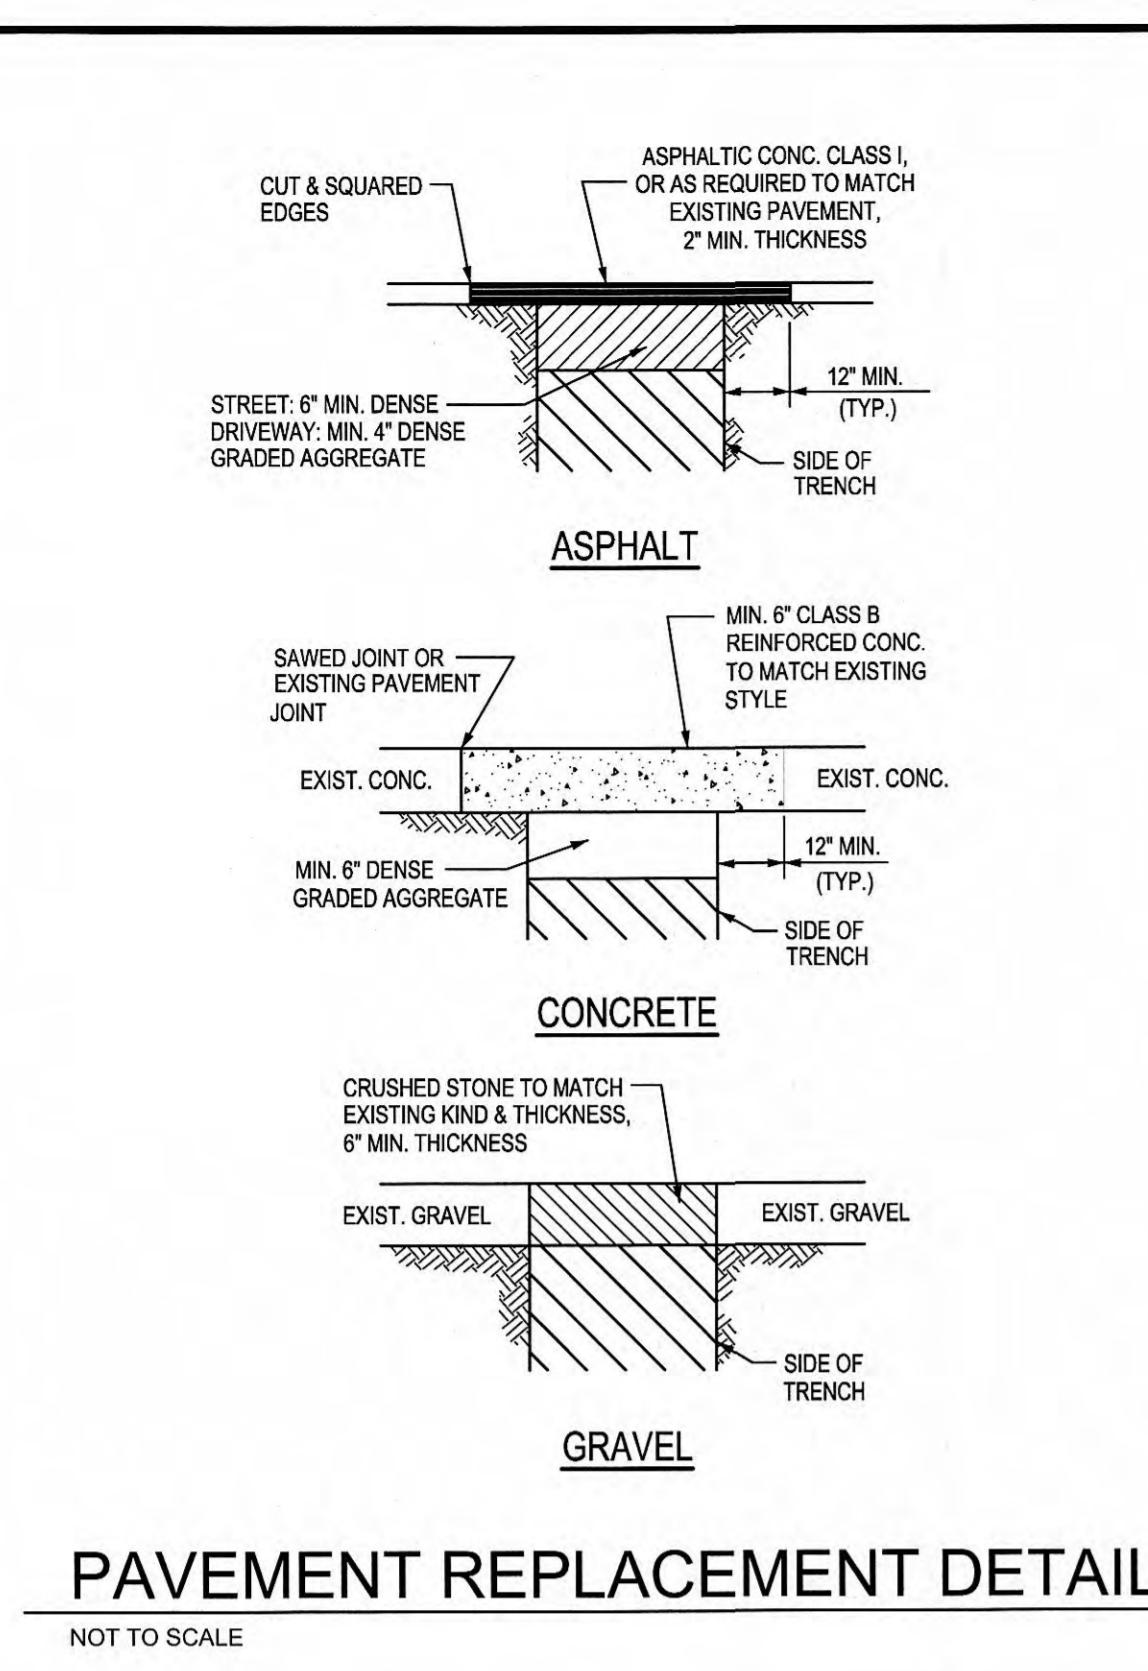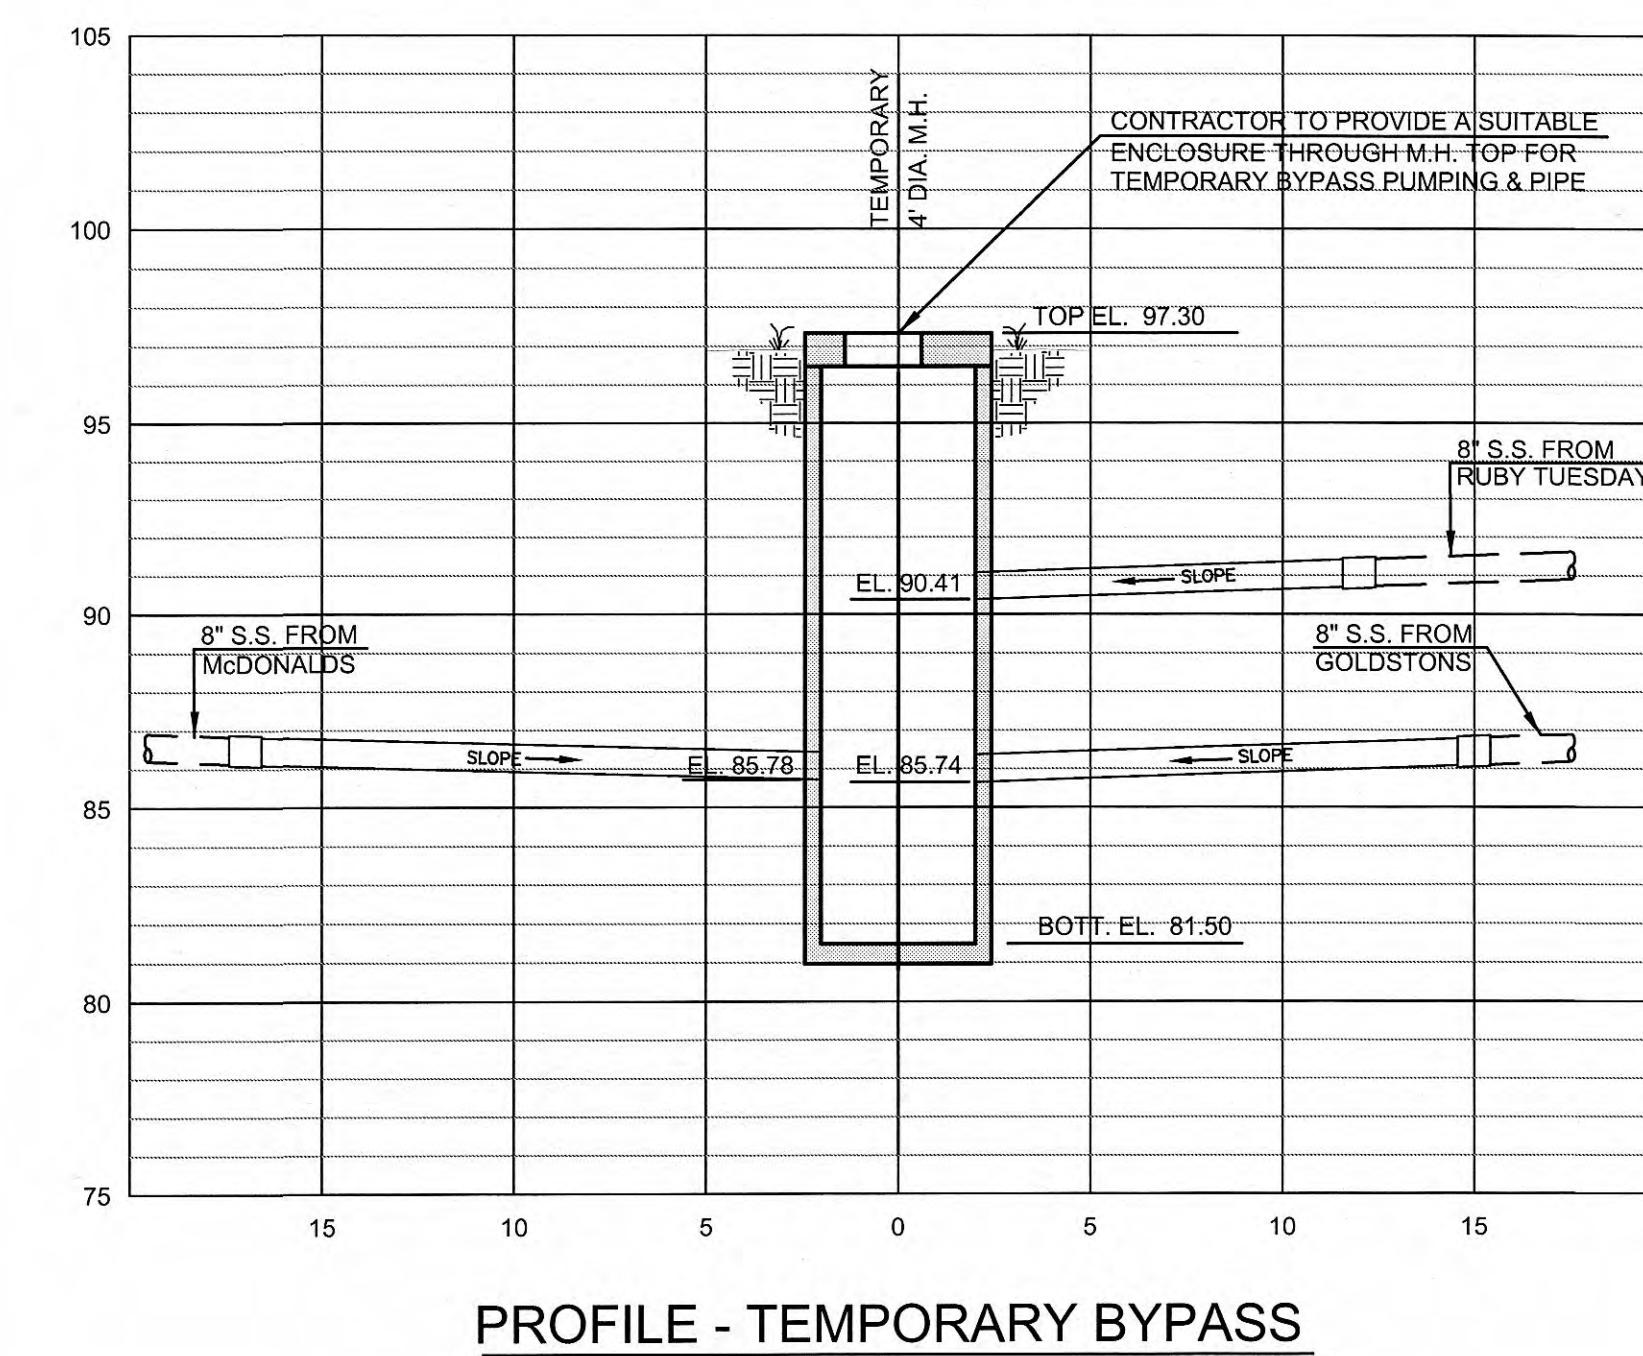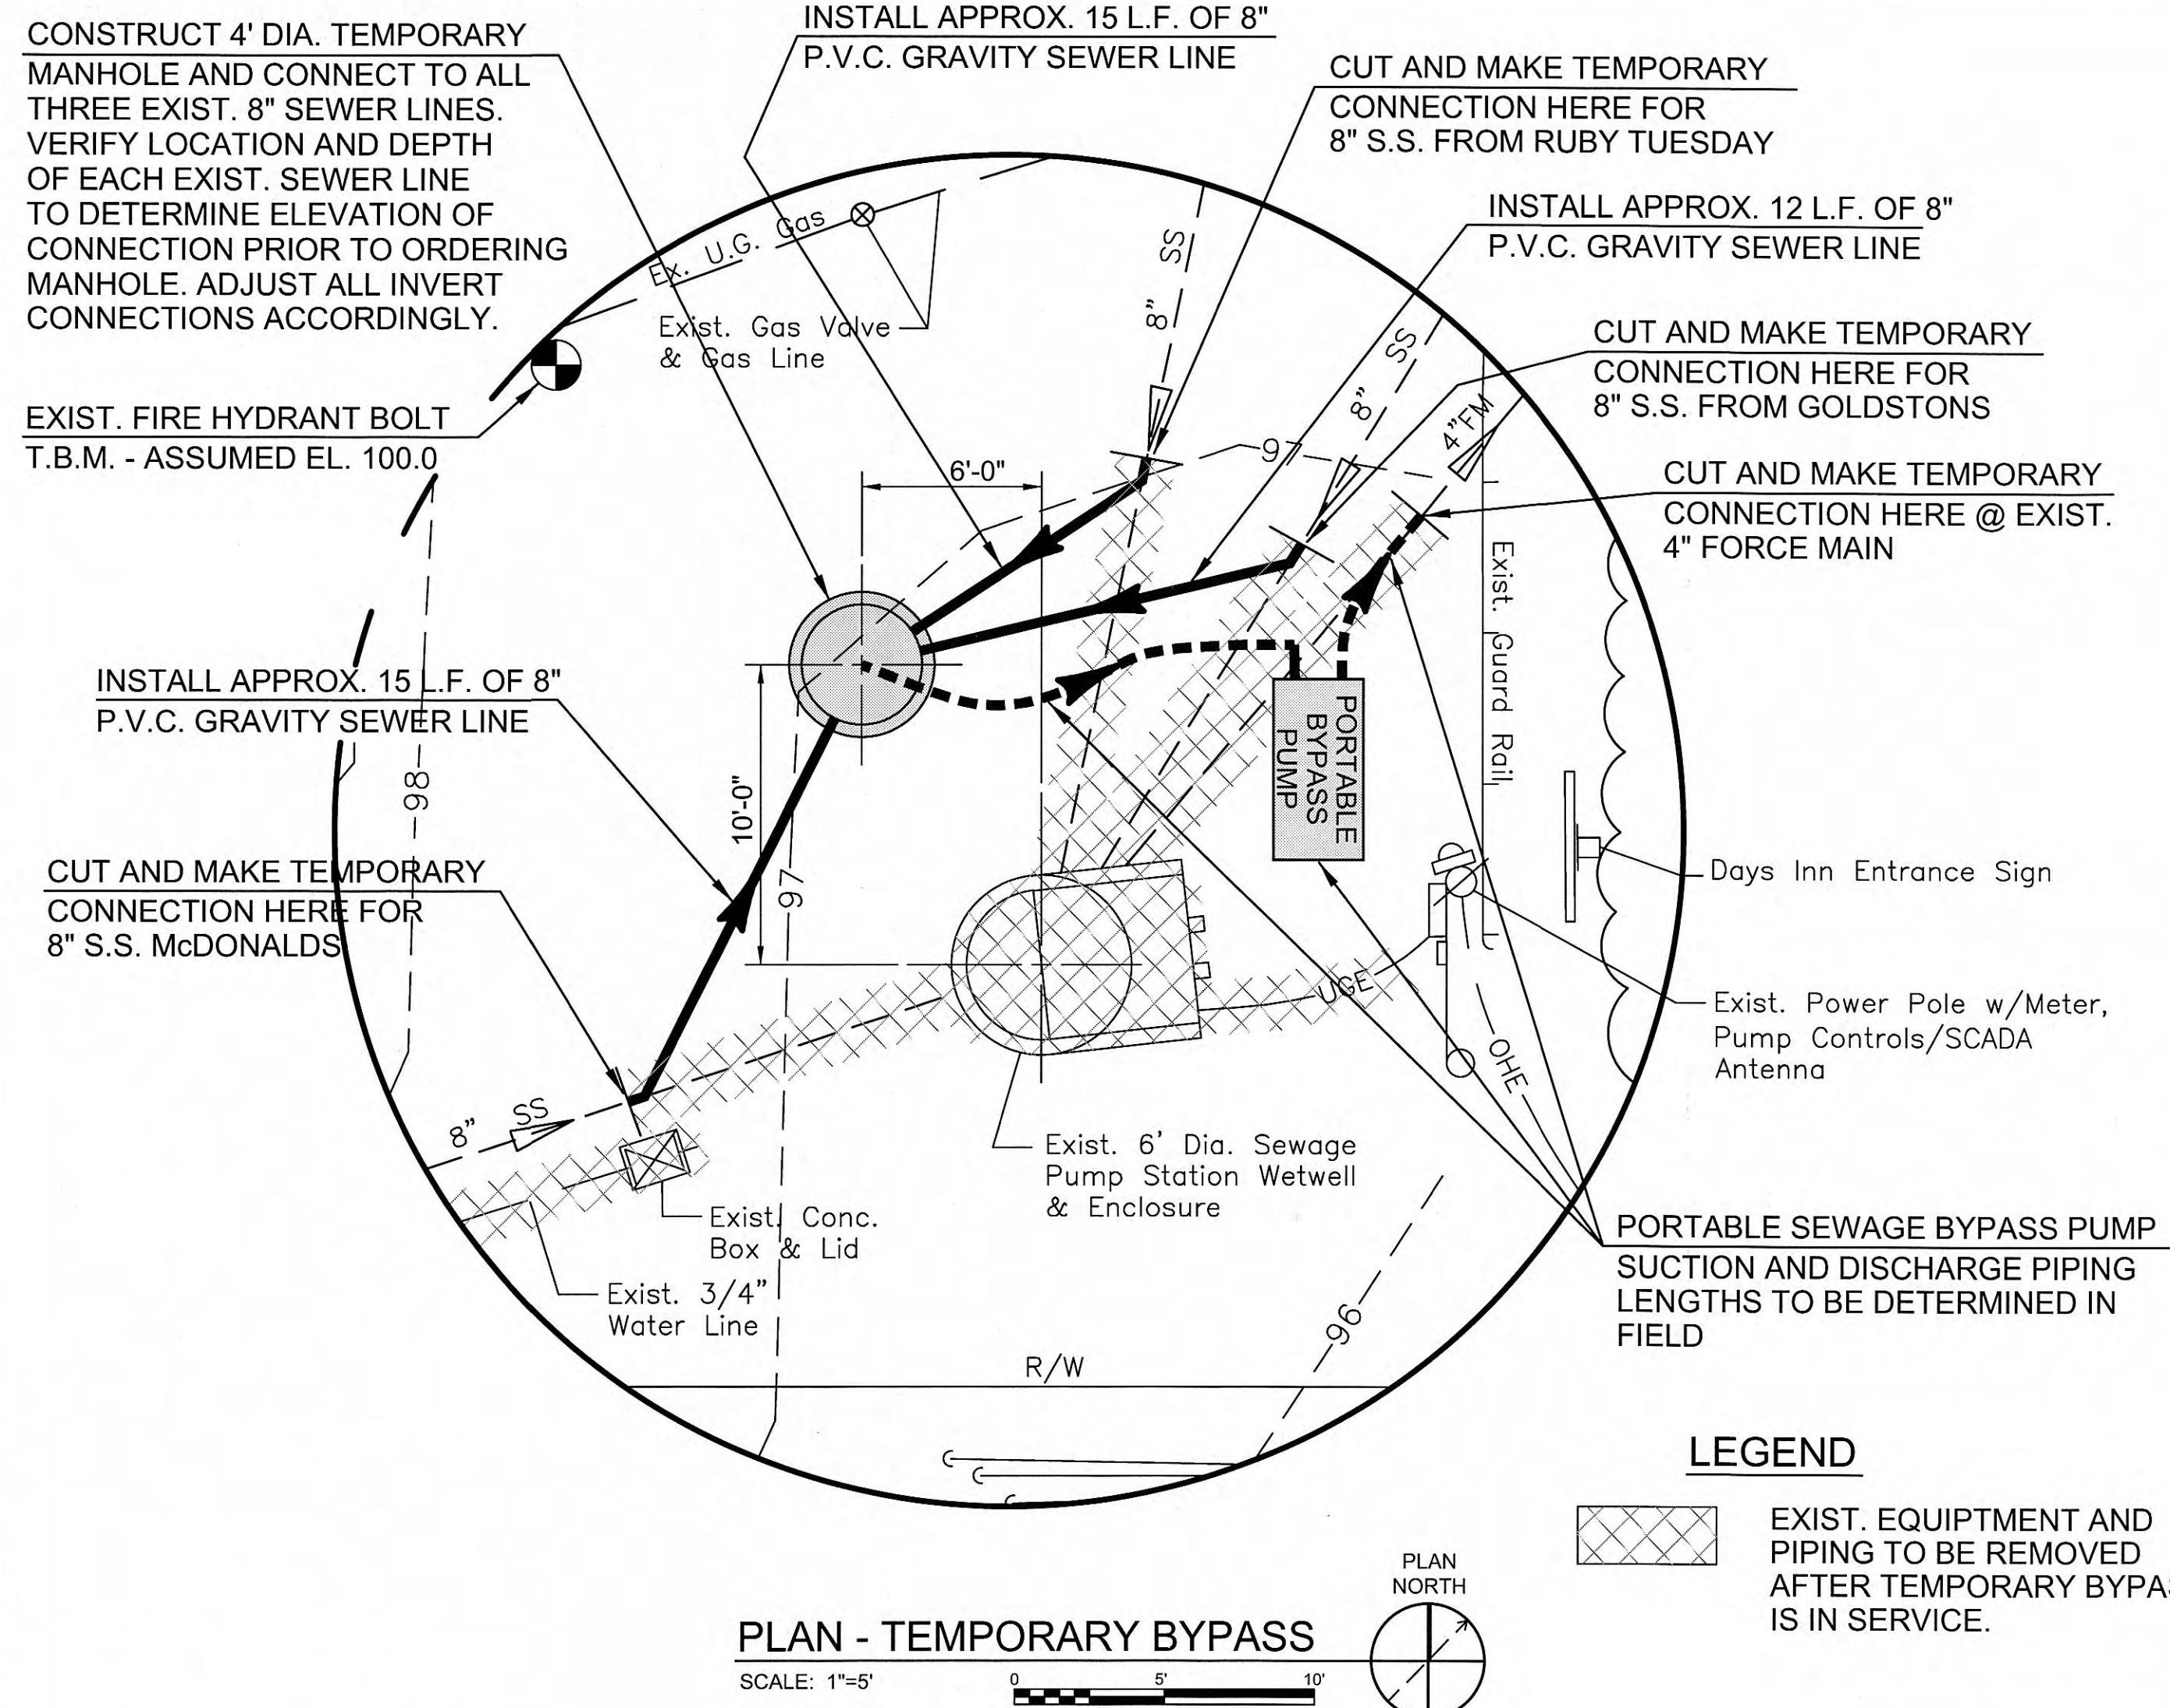
DIMENSIONS ARE IN INCHES






TEMPORARY 4' DIA. MANHOLE & CONNECTIONS w/BYPASS PUMPING @ McDONALDs PUMP STATION


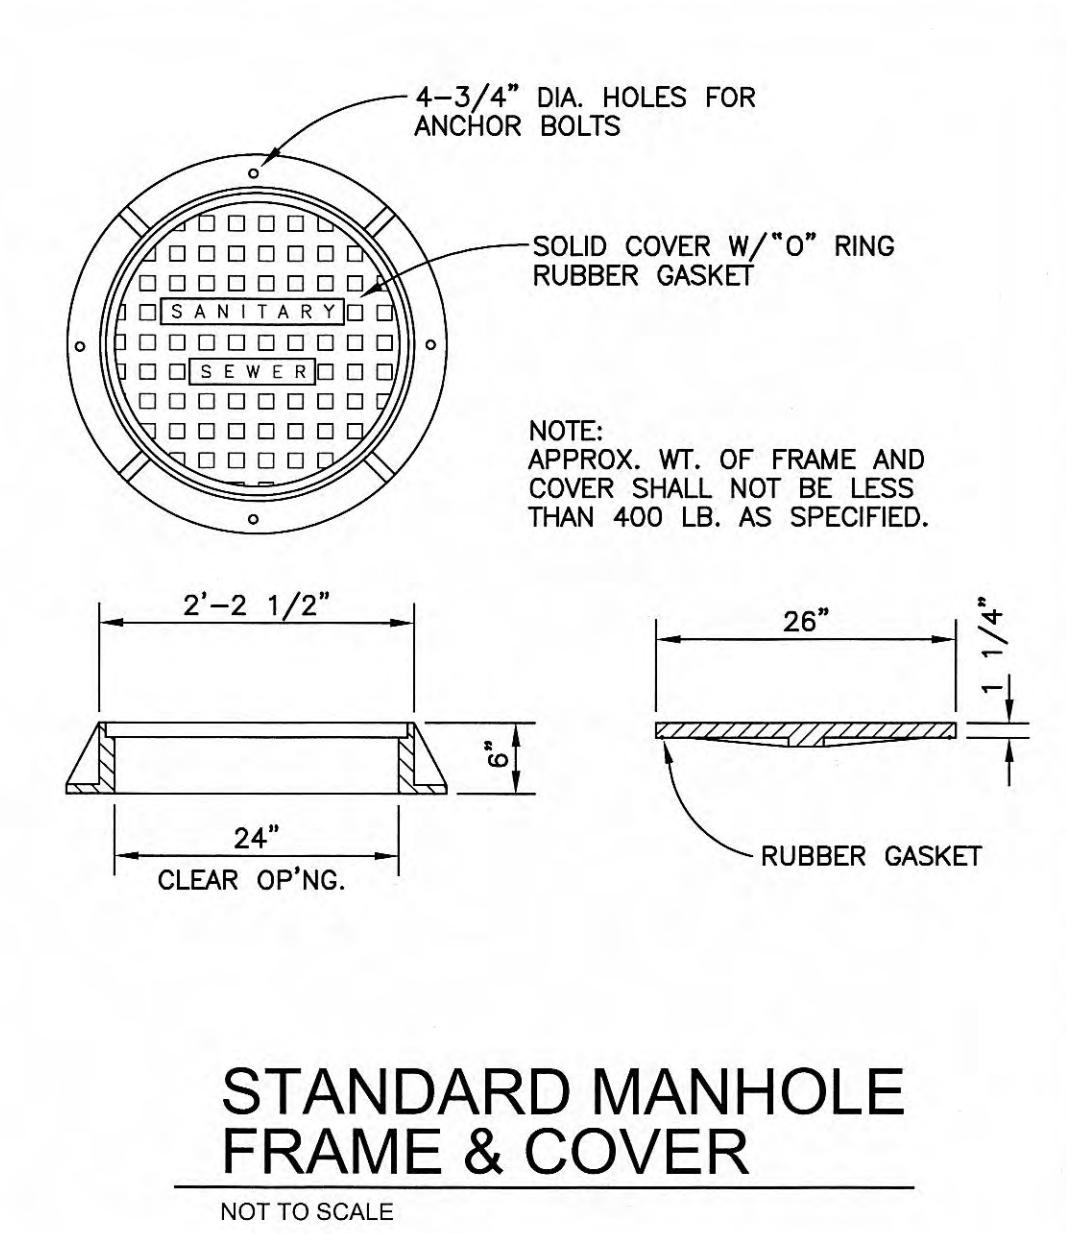
SCALE: 1"=5' VERT.
1"=5' HORIZ. 0' 5' 10'




STANDARD MANHOLE FRAME & COVER

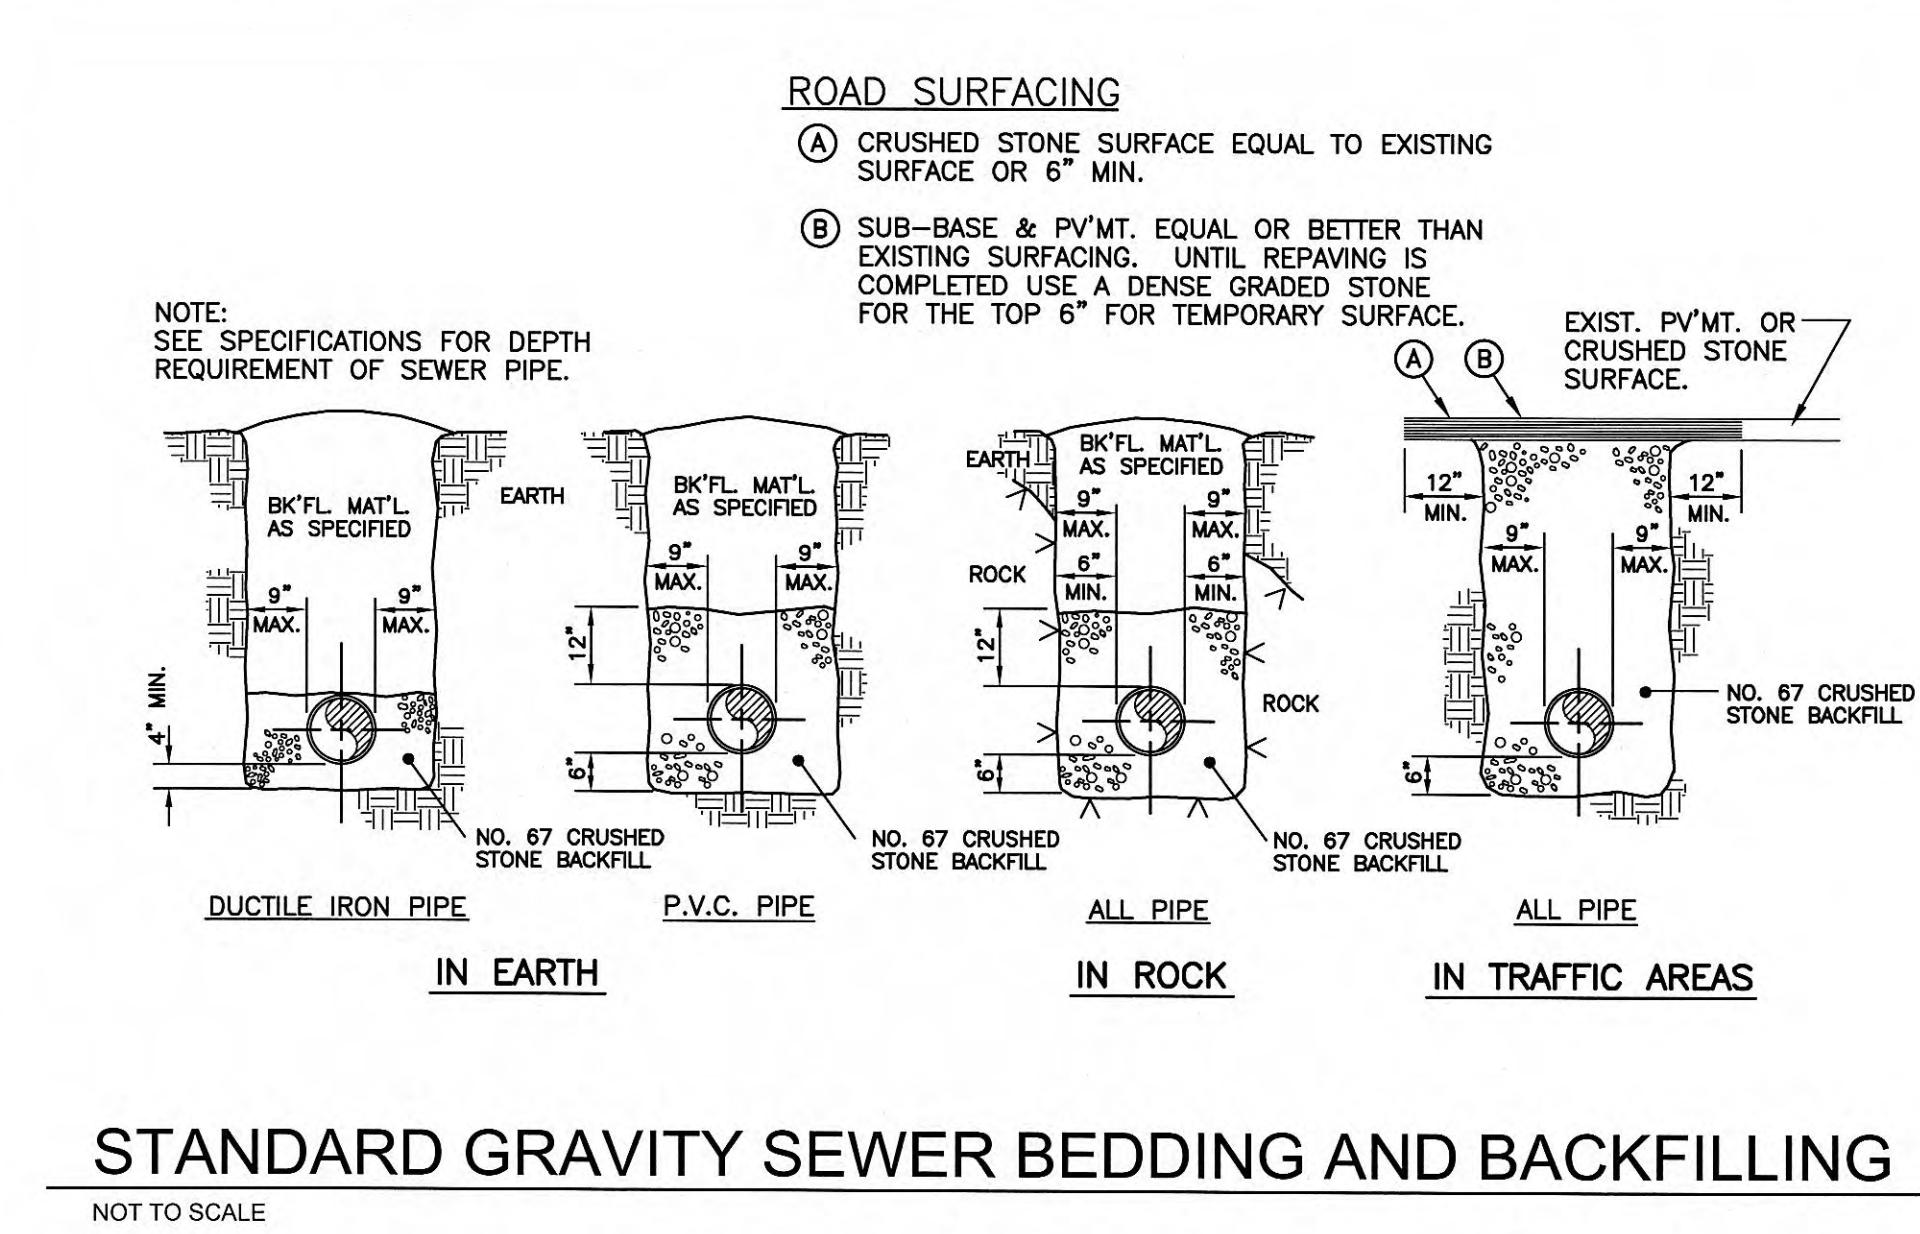

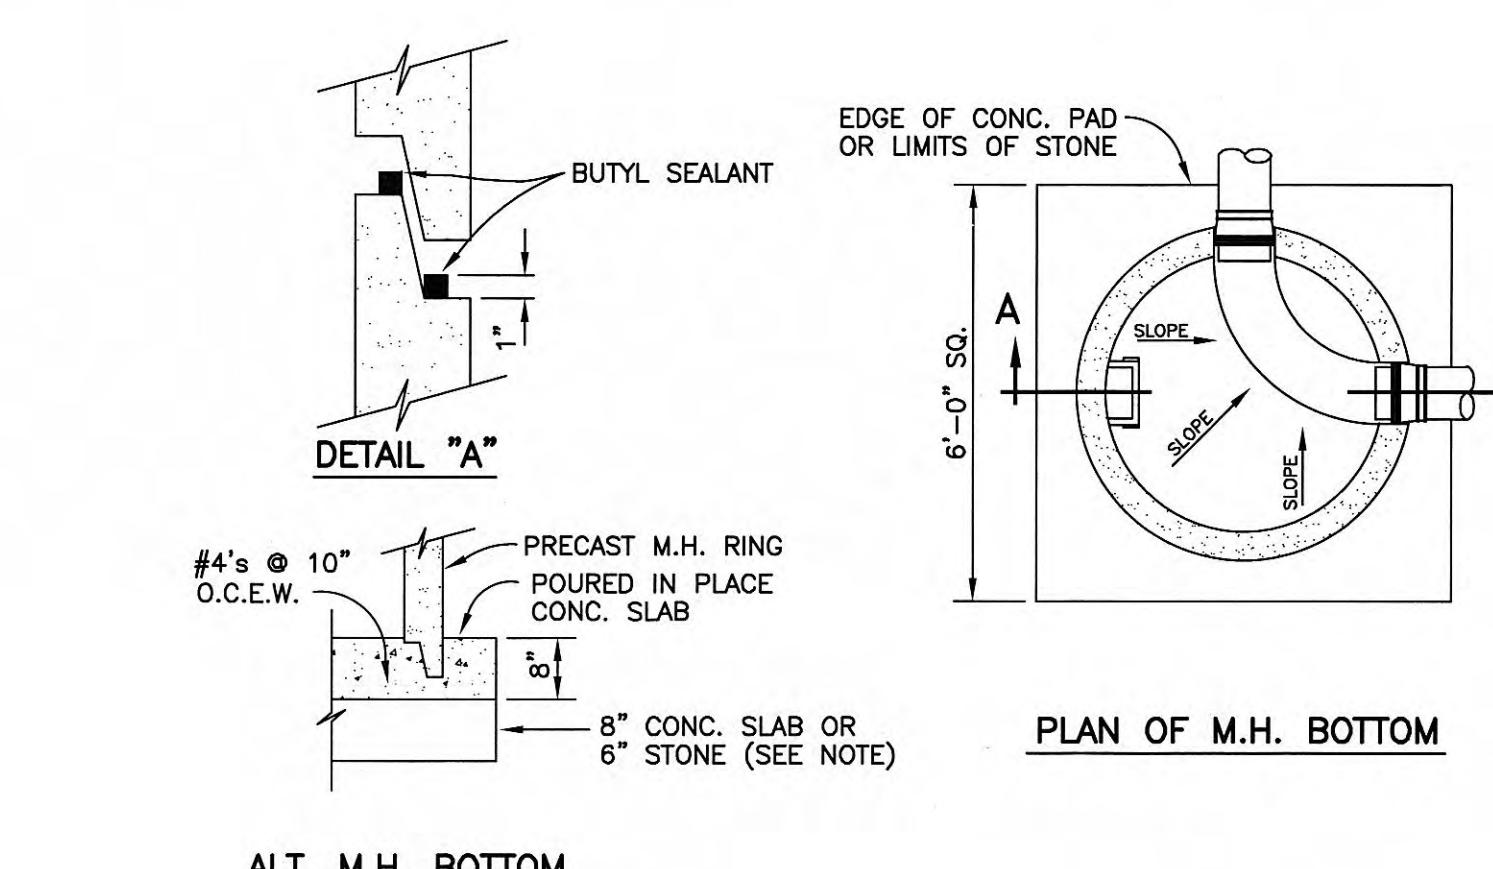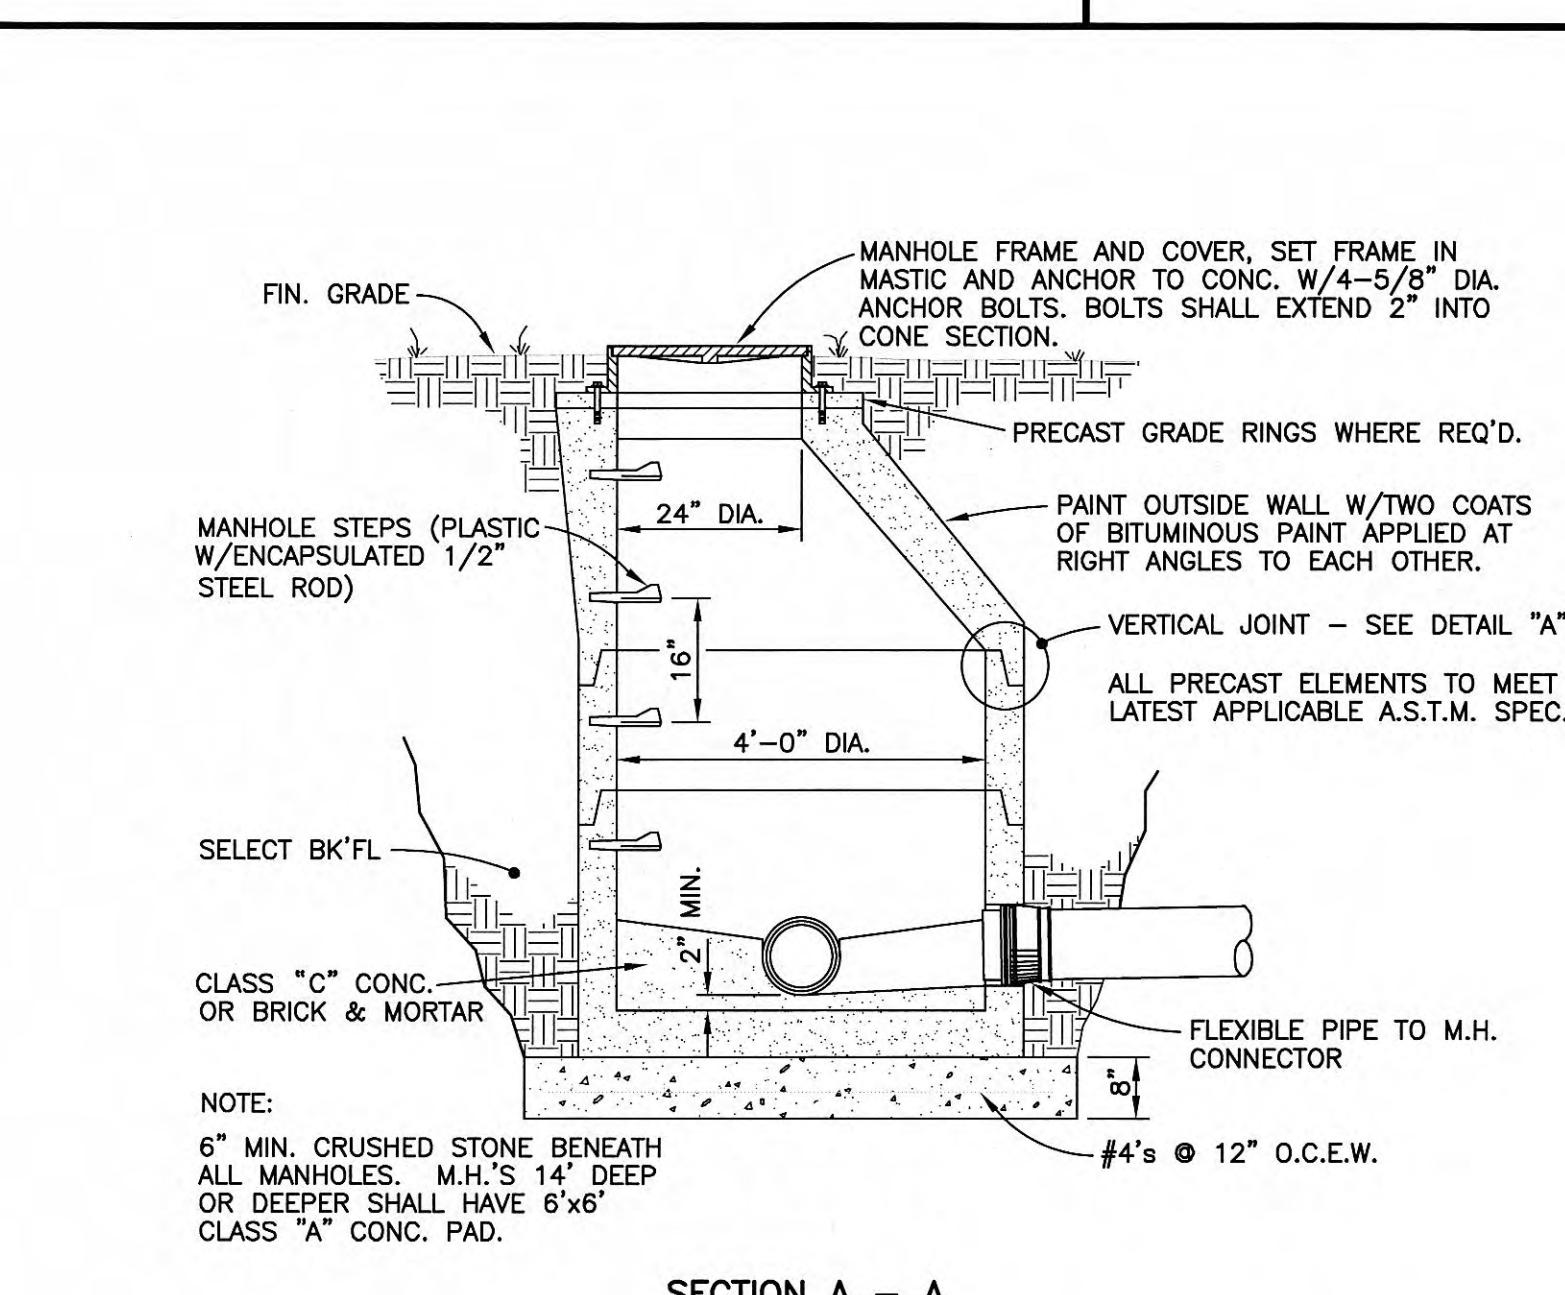
STANDARD GRAVITY SEWER BEDDING AND BACKFILLING




STANDARD MANHOLE

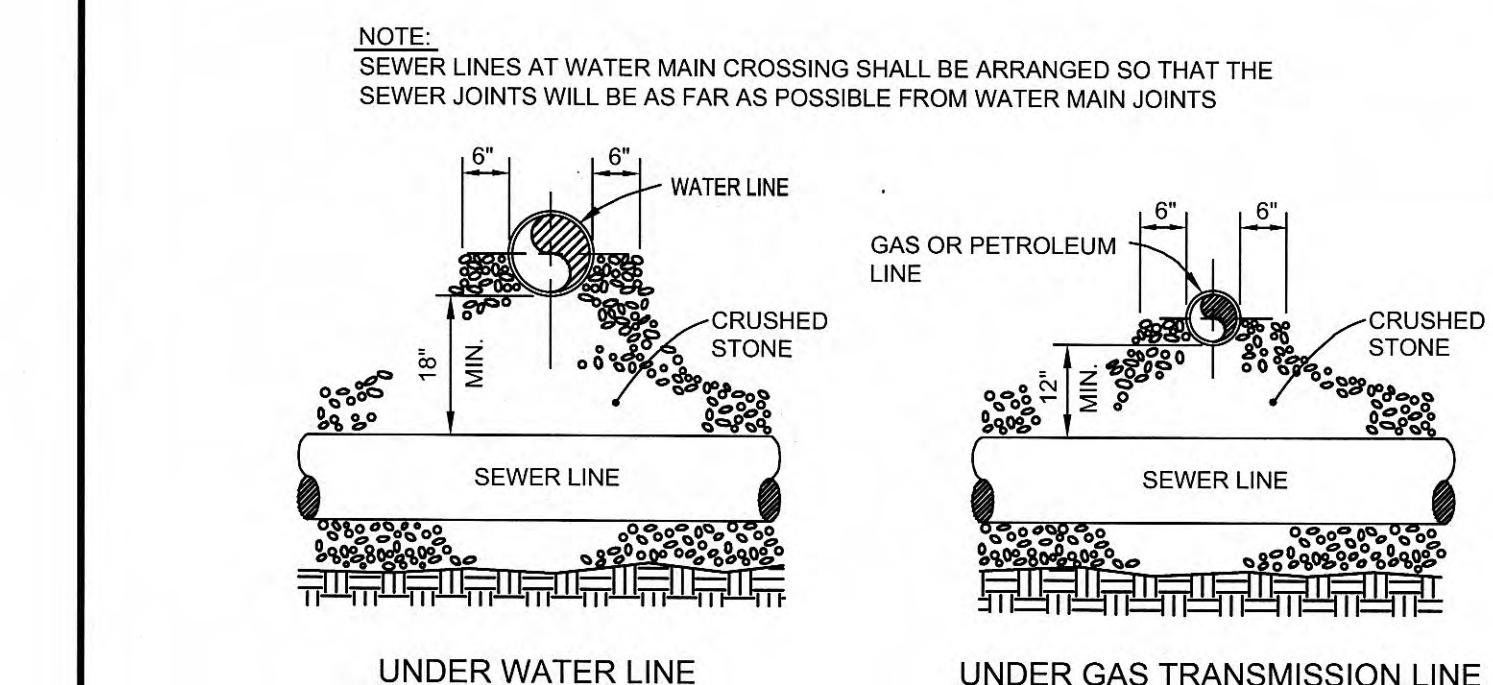

PIPE CROSSING FOR SEWER LINE

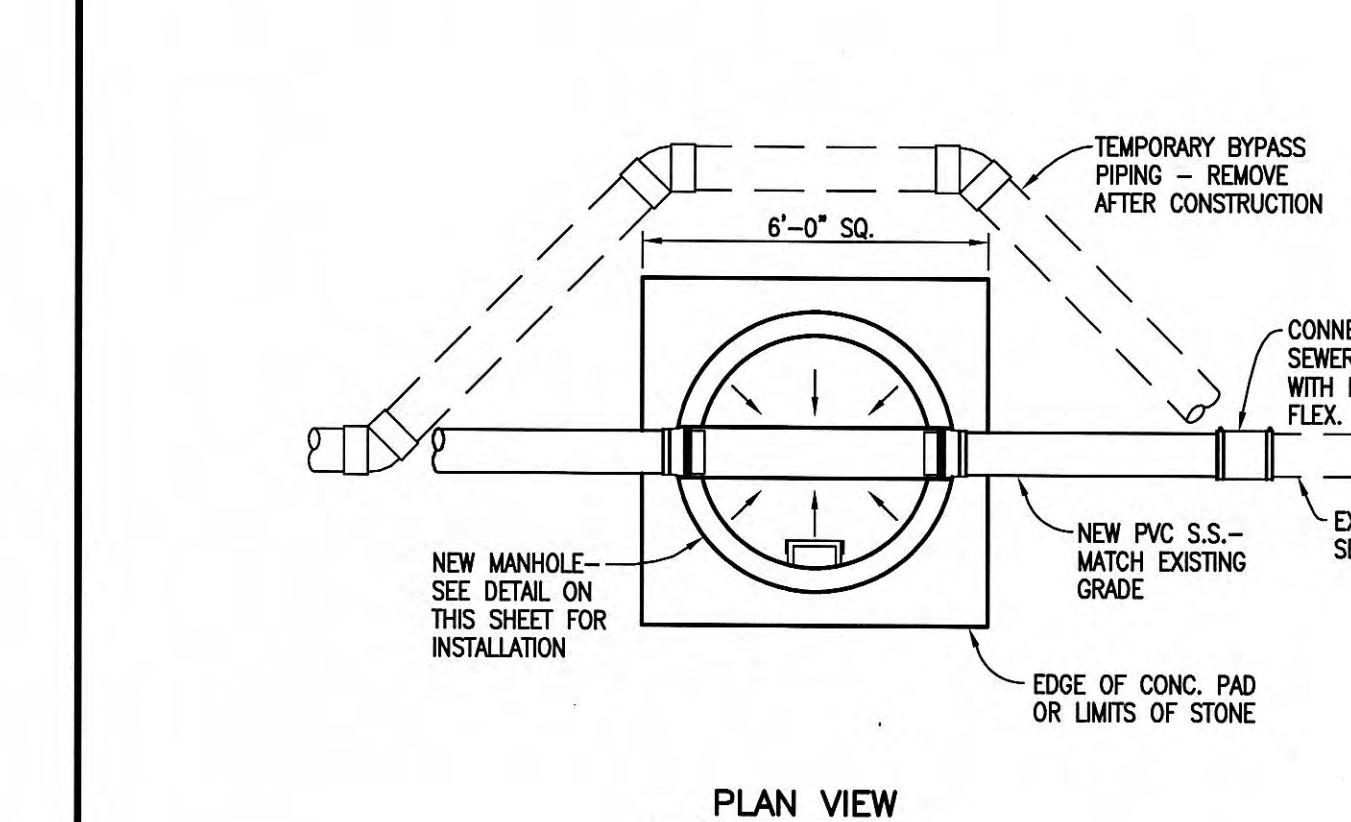

M.H. CONSTRUCTION OVER EXISTING LINE

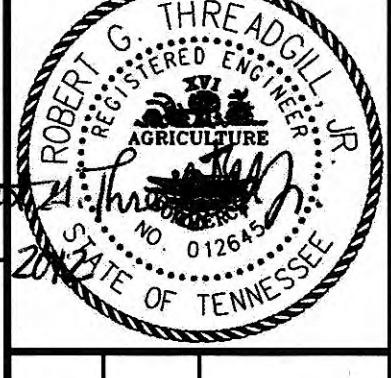

GRV PROJECT NO. 3947-01
CLIENT PROJECT NO.

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PUMP STATION REHABILITATION
CITY OF HARRIMAN, TENNESSEE

STANDARD GRAVITY SEWER DETAILS

REVISIONS	DESCRIPTION	DESIGNED	RGT	DRAWN	SH	REVIEWED	RGT	APPROVED	RGT

DATE: DECEMBER 2012
SCALE: AS NOTED
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THIS MARK SHOULD MEASURE EXACTLY 1' WHEN PLOTTED
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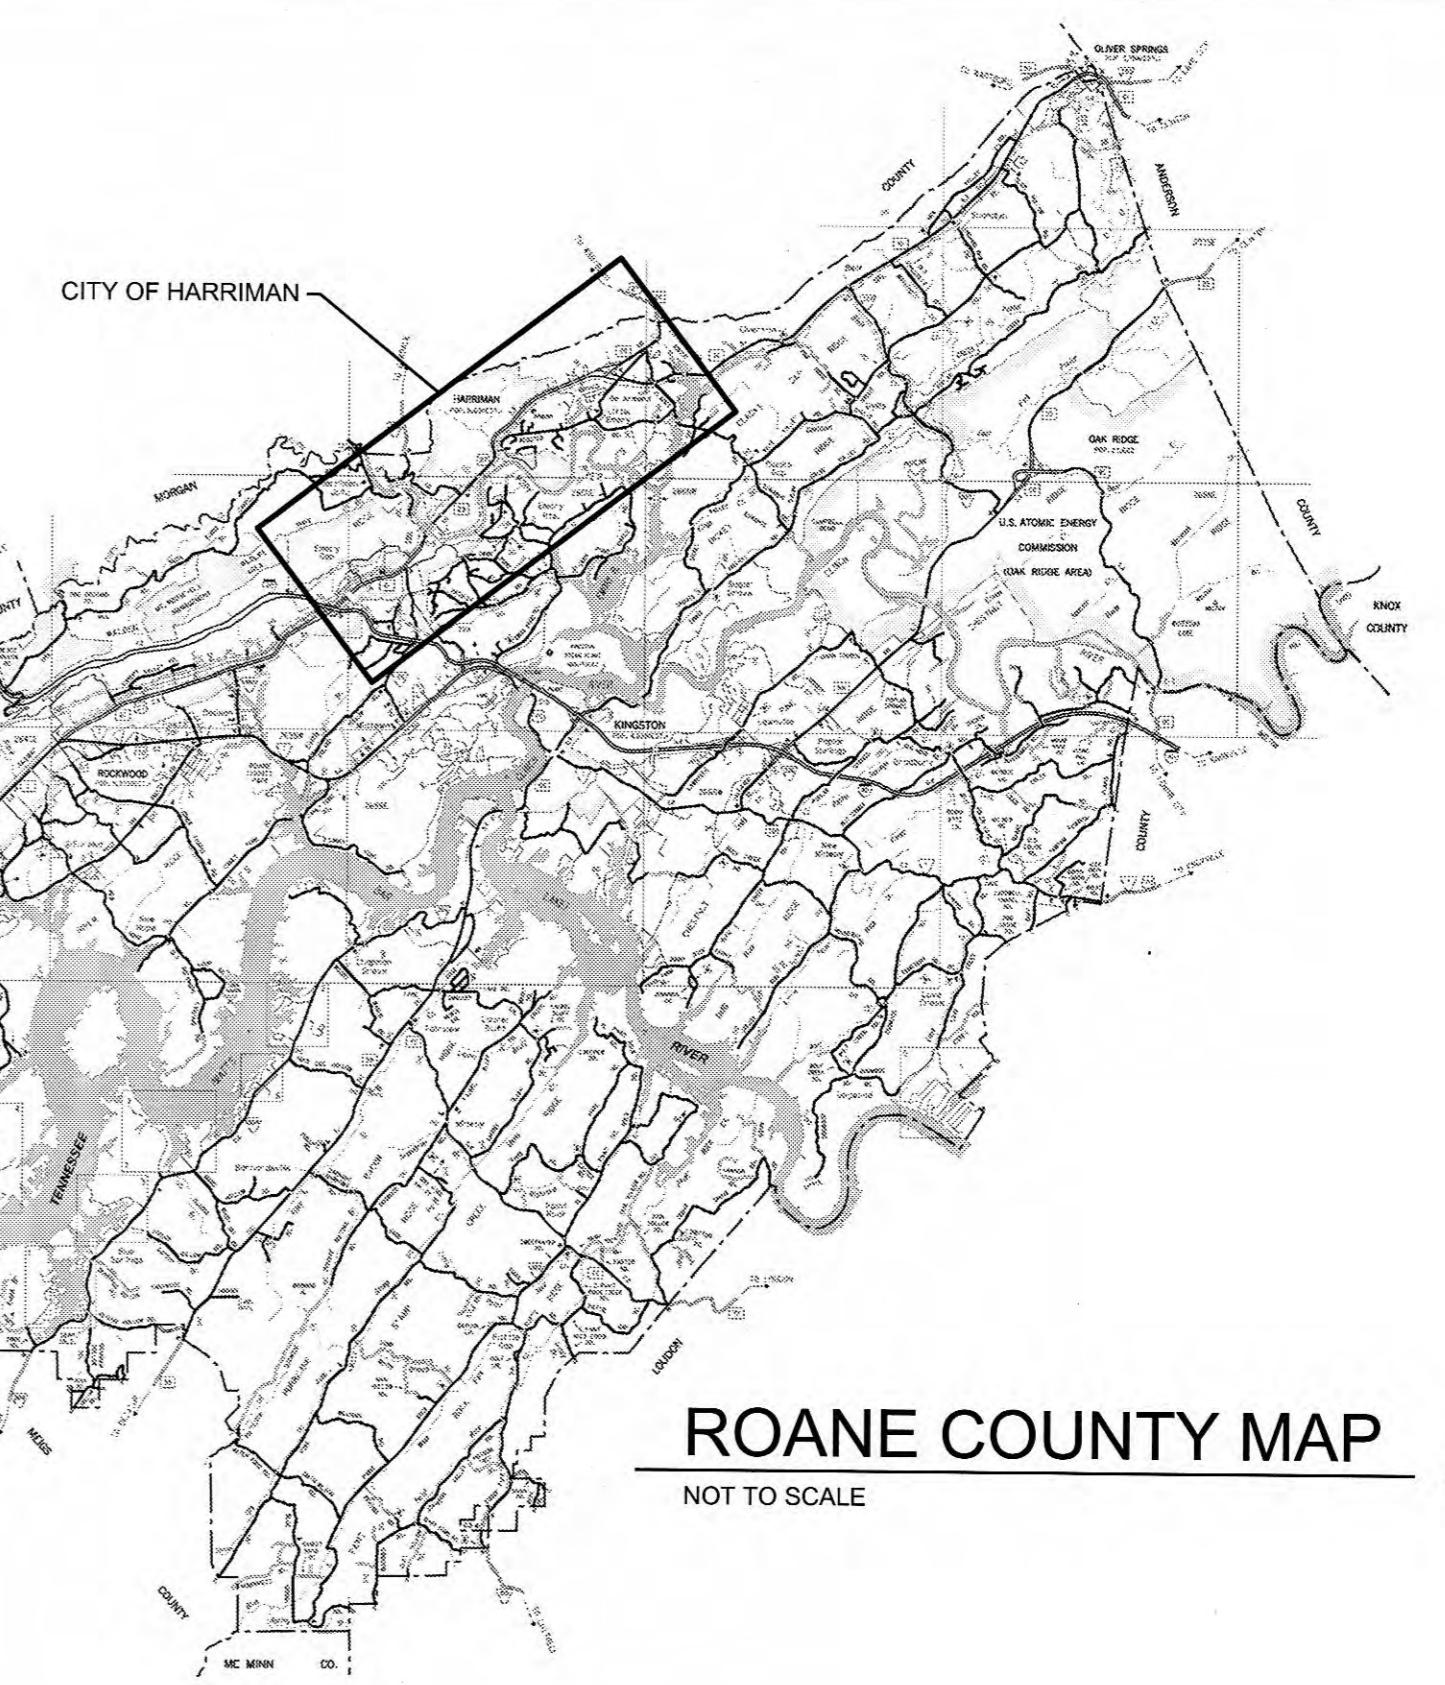
G-003

GENERAL NOTES:

1. THE GENERAL CONTRACTOR SHALL VERIFY THE DIMENSIONS AND SITE CONDITIONS BEFORE STARTING WORK ON THE EXISTING STRUCTURES AND CONCRETE. THE OWNER'S REPRESENTATIVE SHALL BE NOTIFIED OF ANY DISCREPANCY.
2. THE CONTRACTOR SHALL COORDINATE THE ARCHITECTURAL, MECHANICAL, ELECTRICAL, PLUMBING AND CIVIL WORKS WITH THE STRUCTURAL CONTRACT DOCUMENTS. THE OWNER'S REPRESENTATIVE SHALL BE NOTIFIED OF ANY DISCREPANCIES OR OMISSIONS.
3. THE CONTRACTOR SHALL RESTORE ALL CULVERTS, FENCES, WALLS, SMALL ORNAMENTAL TREES, CULTIVATED SHRUBS, FLOWERS, SIGNS, LIGHTS AND POWER POLES, STREET MARKERS, MAIL BOXES, WATER AND GAS LINES, WATER AND GAS METERS AND BOXES INCLUDING SHUT-OFFS, AND LAWNS DISTURBED BY CONSTRUCTION OPERATIONS TO THEIR ORIGINAL CONDITIONS. THE COST OF THIS WORK SHALL BE INCLUDED IN THE CONTRACT PRICE.
4. WHERE IN EASEMENTS THE CONTRACTOR SHALL PROTECT AND RESTORE SAID PROPERTY TO CONDITION SIMILAR OR EQUAL TO THAT EXISTING AT THE COMMENCEMENT OF CONSTRUCTION, EXCEPT AS NOTED.
5. THE LOCATION OF EXISTING UNDERGROUND UTILITIES ARE SHOWN IN AN APPROXIMATE WAY ONLY. THE CONTRACTOR SHALL DETERMINE THE EXACT LOCATION OF ALL EXISTING UTILITIES BEFORE COMMENCING WORK IN EACH AREA. HE/SHE AGREE TO BE FULLY RESPONSIBLE FOR ANY AND ALL DAMAGES WHICH MIGHT BE CAUSED BY HIS FAILURE TO EXACTLY LOCATE AND PRESERVE ANY AND ALL UTILITIES. BEFORE CONSTRUCTION, CONTRACTOR SHALL CONTACT:

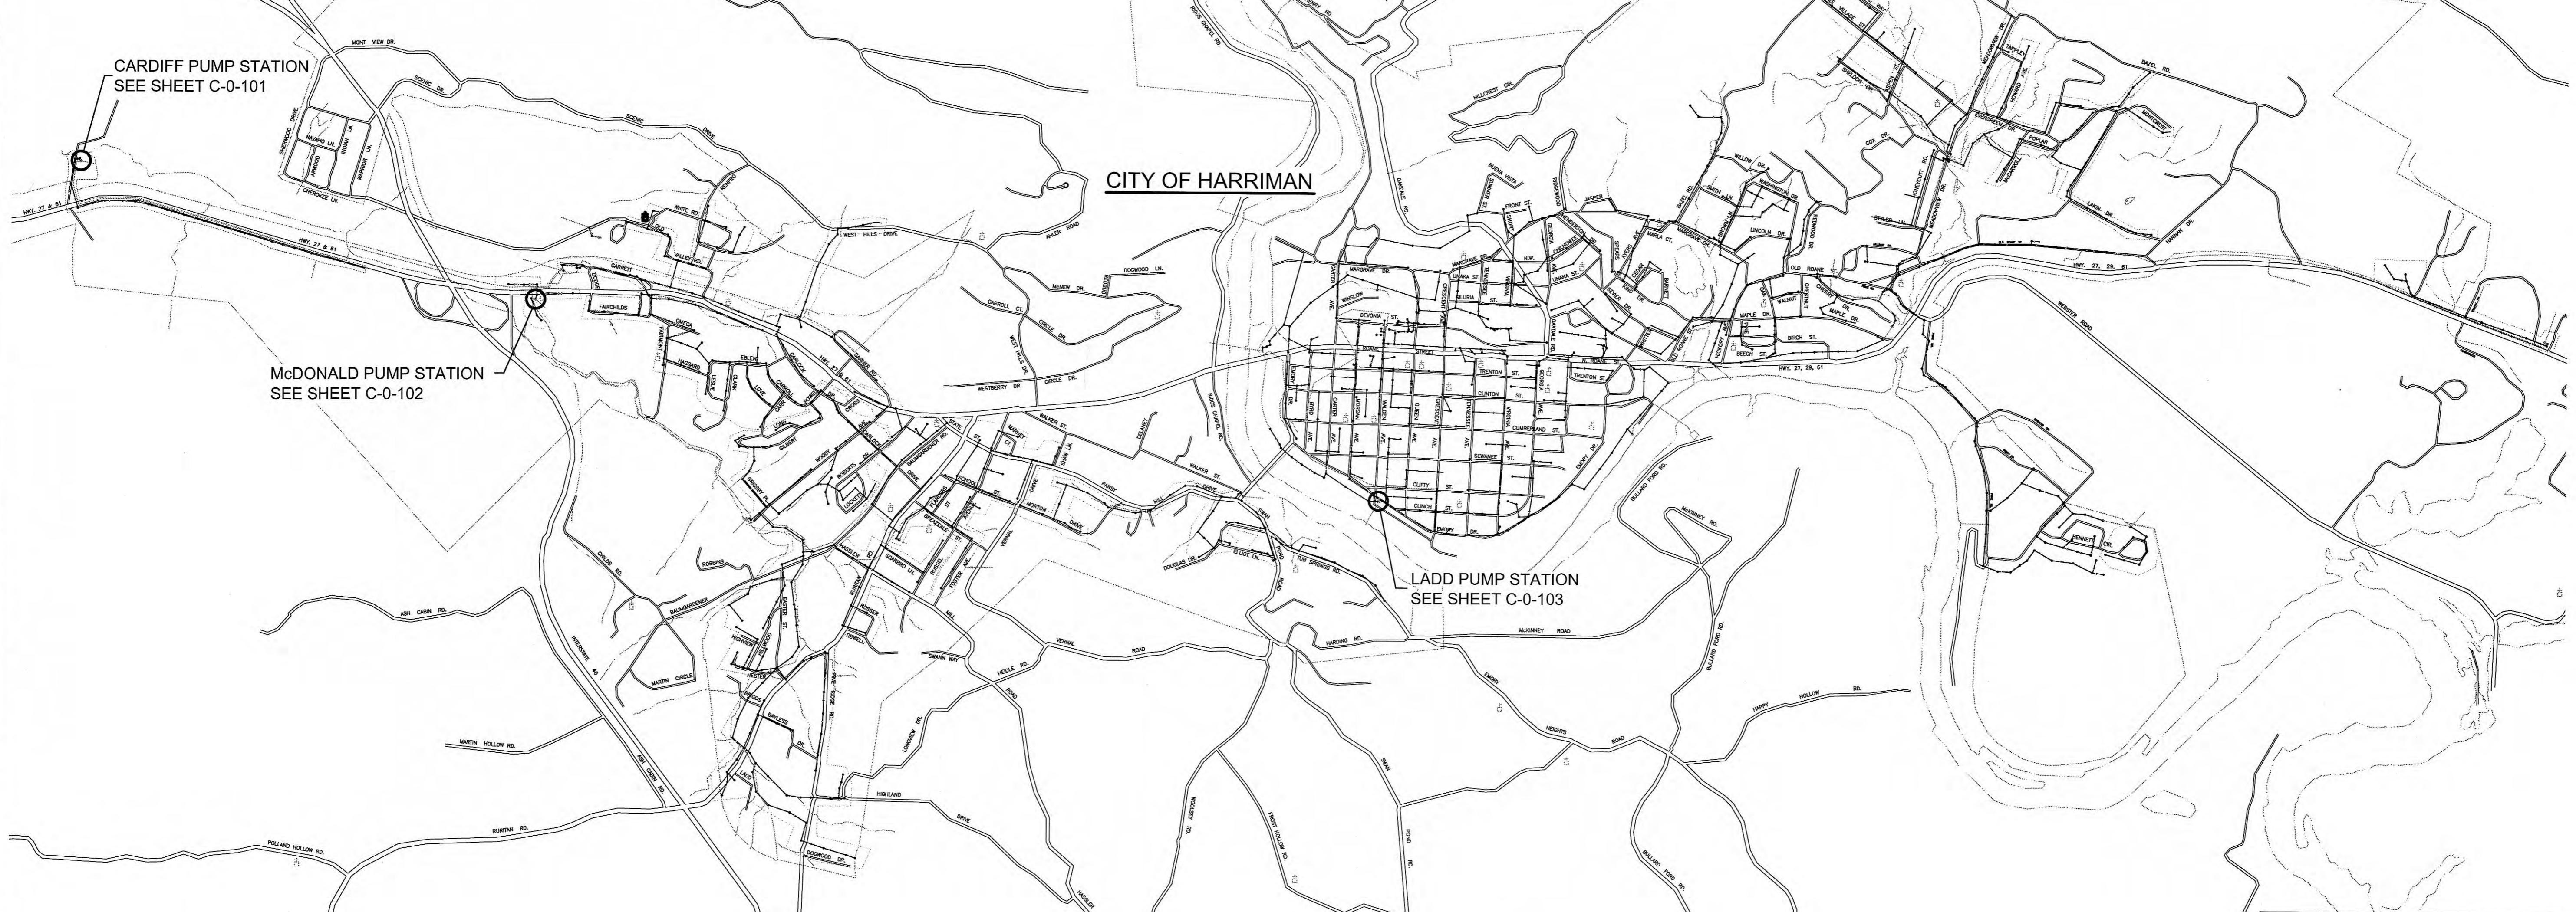
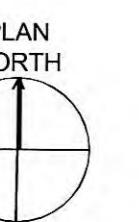
TENNESSEE ONE CALL SYSTEM
DIAL 811 OR 1-800-351-1111
THREE WORKING DAYS BEFORE YOU DIG

6. THE OWNER DOES NOT ASSUME RESPONSIBILITY FOR THE POSSIBILITY THAT DURING CONSTRUCTION, UTILITIES OTHER THAN THOSE SHOWN MAY BE ENCOUNTERED OR THAT ACTUAL LOCATION OF THOSE SHOWN MAY BE DIFFERENT FROM THE LOCATIONS DESIGNATED ON THE CONTRACT DRAWINGS. IN AREAS WHERE IT IS NECESSARY THAT EXACT LOCATIONS BE KNOWN OF UNDERGROUND FACILITIES, THE CONTRACTOR SHALL, AT HIS/HER OWN EXPENSE, FURNISH ALL LABOR AND TOOLS TO EITHER VERIFY AND SUBSTANTIATE OR DEFINITELY ESTABLISH THE POSITION OF UNDERGROUND UTILITY LINES. THIS INCLUDES STORM SEWERS, LOCATION OF EXISTING UTILITIES SHALL NOT BE CAUSE FOR CLAIM AGAINST THE OWNER.
7. IF ANY EXISTING STORM SEWERS ARE SUBSTANTIALLY DAMAGED AS DETERMINED BY THE DESIGNER AND OR OWNER, THE REPAIR SHALL BE MADE WITH R.C.P. PIPE FROM STRUCTURE-TO-STRUCTURE, PIPE SIZE SHALL BE EQUAL TO EXISTING.
8. SUFFICIENT PRECAUTIONS SHALL BE TAKEN DURING CONSTRUCTION TO MINIMIZE THE RUN-OFF OF POLLUTING SUBSTANCES SUCH AS SILT, CLAY, FUELS, OIL, BITUMENS, CALCIUM CHLORIDE, OR OTHER POLLUTING MATERIALS HARMFUL TO HUMANS, FISH OR OTHER LIFE, INTO THE SUPPLIES AND SURFACE WATERS OF THE STATE. CONTROL MEASURES MUST BE ADEQUATE TO ASSURE THAT LOCAL, STATE AND FEDERAL LAWS AND REGULATIONS ARE MET. THE CONTRACTOR IS SOLELY RESPONSIBLE FOR ENSURING THAT THE LAWS AND REGULATIONS ARE MET AND IS RESPONSIBLE FOR ENSURING THAT CONSTRUCTION DOES NOT HARM THE WATERS OF TENNESSEE. THE PROTECTION OF THE SITE SHALL CONTINUE THROUGH THE CONSTRUCTION PERIOD. SPECIAL PRECAUTIONS SHALL BE TAKEN IN THE USE OF CONSTRUCTION EQUIPMENT TO PREVENT OPERATIONS WHICH PROMOTE EROSION.
9. THE TEMPORARY POLLUTION CONTROL PROVISIONS SHALL BE COORDINATED WITH THE PERMANENT EROSION CONTROL MEASURES, TO ENSURE ECONOMICAL EFFECTIVE AND CONTINUOUS EROSION CONTROL THROUGH THE CONSTRUCTION AND POST - CONSTRUCTION PERIOD OF THE PROJECT. NATURAL COVER SHOULD BE MAINTAINED AS LONG AS POSSIBLE AND GRADED AREAS SHOULD BE STABILIZED AS SOON AS POSSIBLE.
10. THE CONTRACTOR SHALL OBTAIN ALL PERMITS FROM THE APPROPRIATE FEDERAL, STATE, COUNTY AND / OR LOCAL AGENCIES TO CROSS ALL HIGHWAYS, STREETS, STREAMS, EASEMENTS, ETC...



ROANE COUNTY MAP

NOT TO SCALE



LOCATION MAP

NOT TO SCALE



G-002

COUNTY MAP, LOCATION MAP AND
GENERAL NOTES
PUMP STATION REHABILITATION
CITY OF HARRIMAN, TENNESSEE


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DESIGNED	RGT	DRAWN	BY	DATE
REVISED	RGT	DRAWN	BY	DATE
APPROVED	RGT	DRAWN	BY	DATE

REVISIONS
DESCRIPTION
DATE
DRAWN
SH
REVIEWED
RGT
APPROVED
RGT

DATE: DECEMBER 2012
SCALE: AS NOTED
SHEET NO.





ENERGY RECOVERY VENTILATION SCHEDULE													
DRAWING SYMBOL	SUPPLY SIDE				EXHAUST SIDE				VOLT/PHASE	MCA	MOCP	WEIGHT	MANUFACTURER MODEL NUMBER
	CFM	E.S.P.	HP	WHEEL EFFICIENCY	CFM	E.S.P.	HP	WHEEL EFFICIENCY					
ERV 1	1,080	0.5	1/2	80.8%	1,080	0.5	1/2	80.8%	120/1	23.8	30.0	780	GREENHECK ERV-361S-15-A

LOUVER SCHEDULE						
DRAWING SYMBOL	LOUVER SIZE (WIDTH X HEIGHT)	CFM	MINIMUM SQ/FT FREE AREA	MAXIMUM PRESSURE DROP (IN. WG)	MANUFACTURER AND MODEL NUMBER	NOTES
	24x18	1,080	1.40	0.14	RUSKIN ELF 375DXH	SEE BELOW
	24x18	1,080	1.40	0.14	RUSKIN ELF 375DXH	SEE BELOW

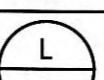MECHANICAL LEGEND

STANDARD ABBREVIATIONS AND NOTATIONS


FFE	FINISHED FLOOR ELEVATION	NIC	NOT IN CONTRACT
FA	FROM ABOVE	SU	SUPPLY DUCTWORK
DN	DOWN	RE	RETURN DUCTWORK
CD	CEILING DIFFUSER	EX	EXHAUST DUCTWORK
CR	CEILING RETURN	OA	OUTDOOR AIR DUCTWORK
CE	CEILING EXHAUST		
SR	SUPPLY REGISTER		
RR	RETURN REGISTER		
ER	EXHAUST REGISTER		

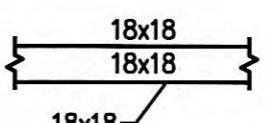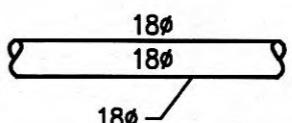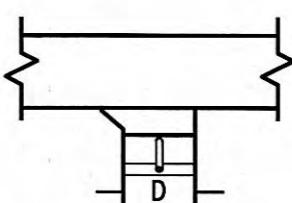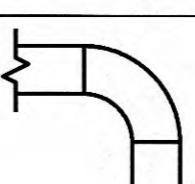SYMBOL	DESCRIPTION
	RECTANGULAR DUCT: MANUAL OPPOSED BLADE DAMPER WITH LOCKING QUADRANT. LEVER OPERATOR, OF STEEL CONSTRUCTION. LOUVERS & DAMPERS MODEL CD-400; KRUEGER MODEL OBD-DM TYPE 2 OPERATION FOR LESS THAN 10" WIDE.
	ROUND DUCT: ROUND BLADE CONTROL DAMPER OF STEEL CONSTRUCTION WITH MANUAL OPERATOR LOUVERS AND DAMPERS MODEL CD-600.
	SHEET METAL CONNECTORS, INC. HIGH EFFICIENCY TAKEOFF WITH DAMPER AND LOCKING QUADRANT FOR ROUND DUCT TAKEOFFS FROM RECTANGULAR DUCTWORK. INCREASE MAIN DUCT SIZE AT FITTING TO ACCOMODATE ITS INSTALLATION IF REQUIRED TO MEET SMACNA AND MANUFACTURER'S INSTRUCTIONS. ALL BRANCH TAKEOFFS SHALL HAVE BALANCING DAMPERS FOR BALANCING PURPOSES. DIMENSION: D = RUNOUT DIAMETER (6"-14")
	RECTANGULAR ELBOW WITH SINGLE THICKNESS TURNING VANES OF STEEL CONSTRUCTION.
	EQUIPMENT TAG
	ELECTRICAL PANEL - AVOID INSTALLING EQUIPMENT IN PANEL BOARD SPACE PER ARTICLE 110 OF THE NATIONAL ELECTRIC CODE.
(S) XX-1	WALL SWITCH - XXX-1




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SECTION 1 - HVAC

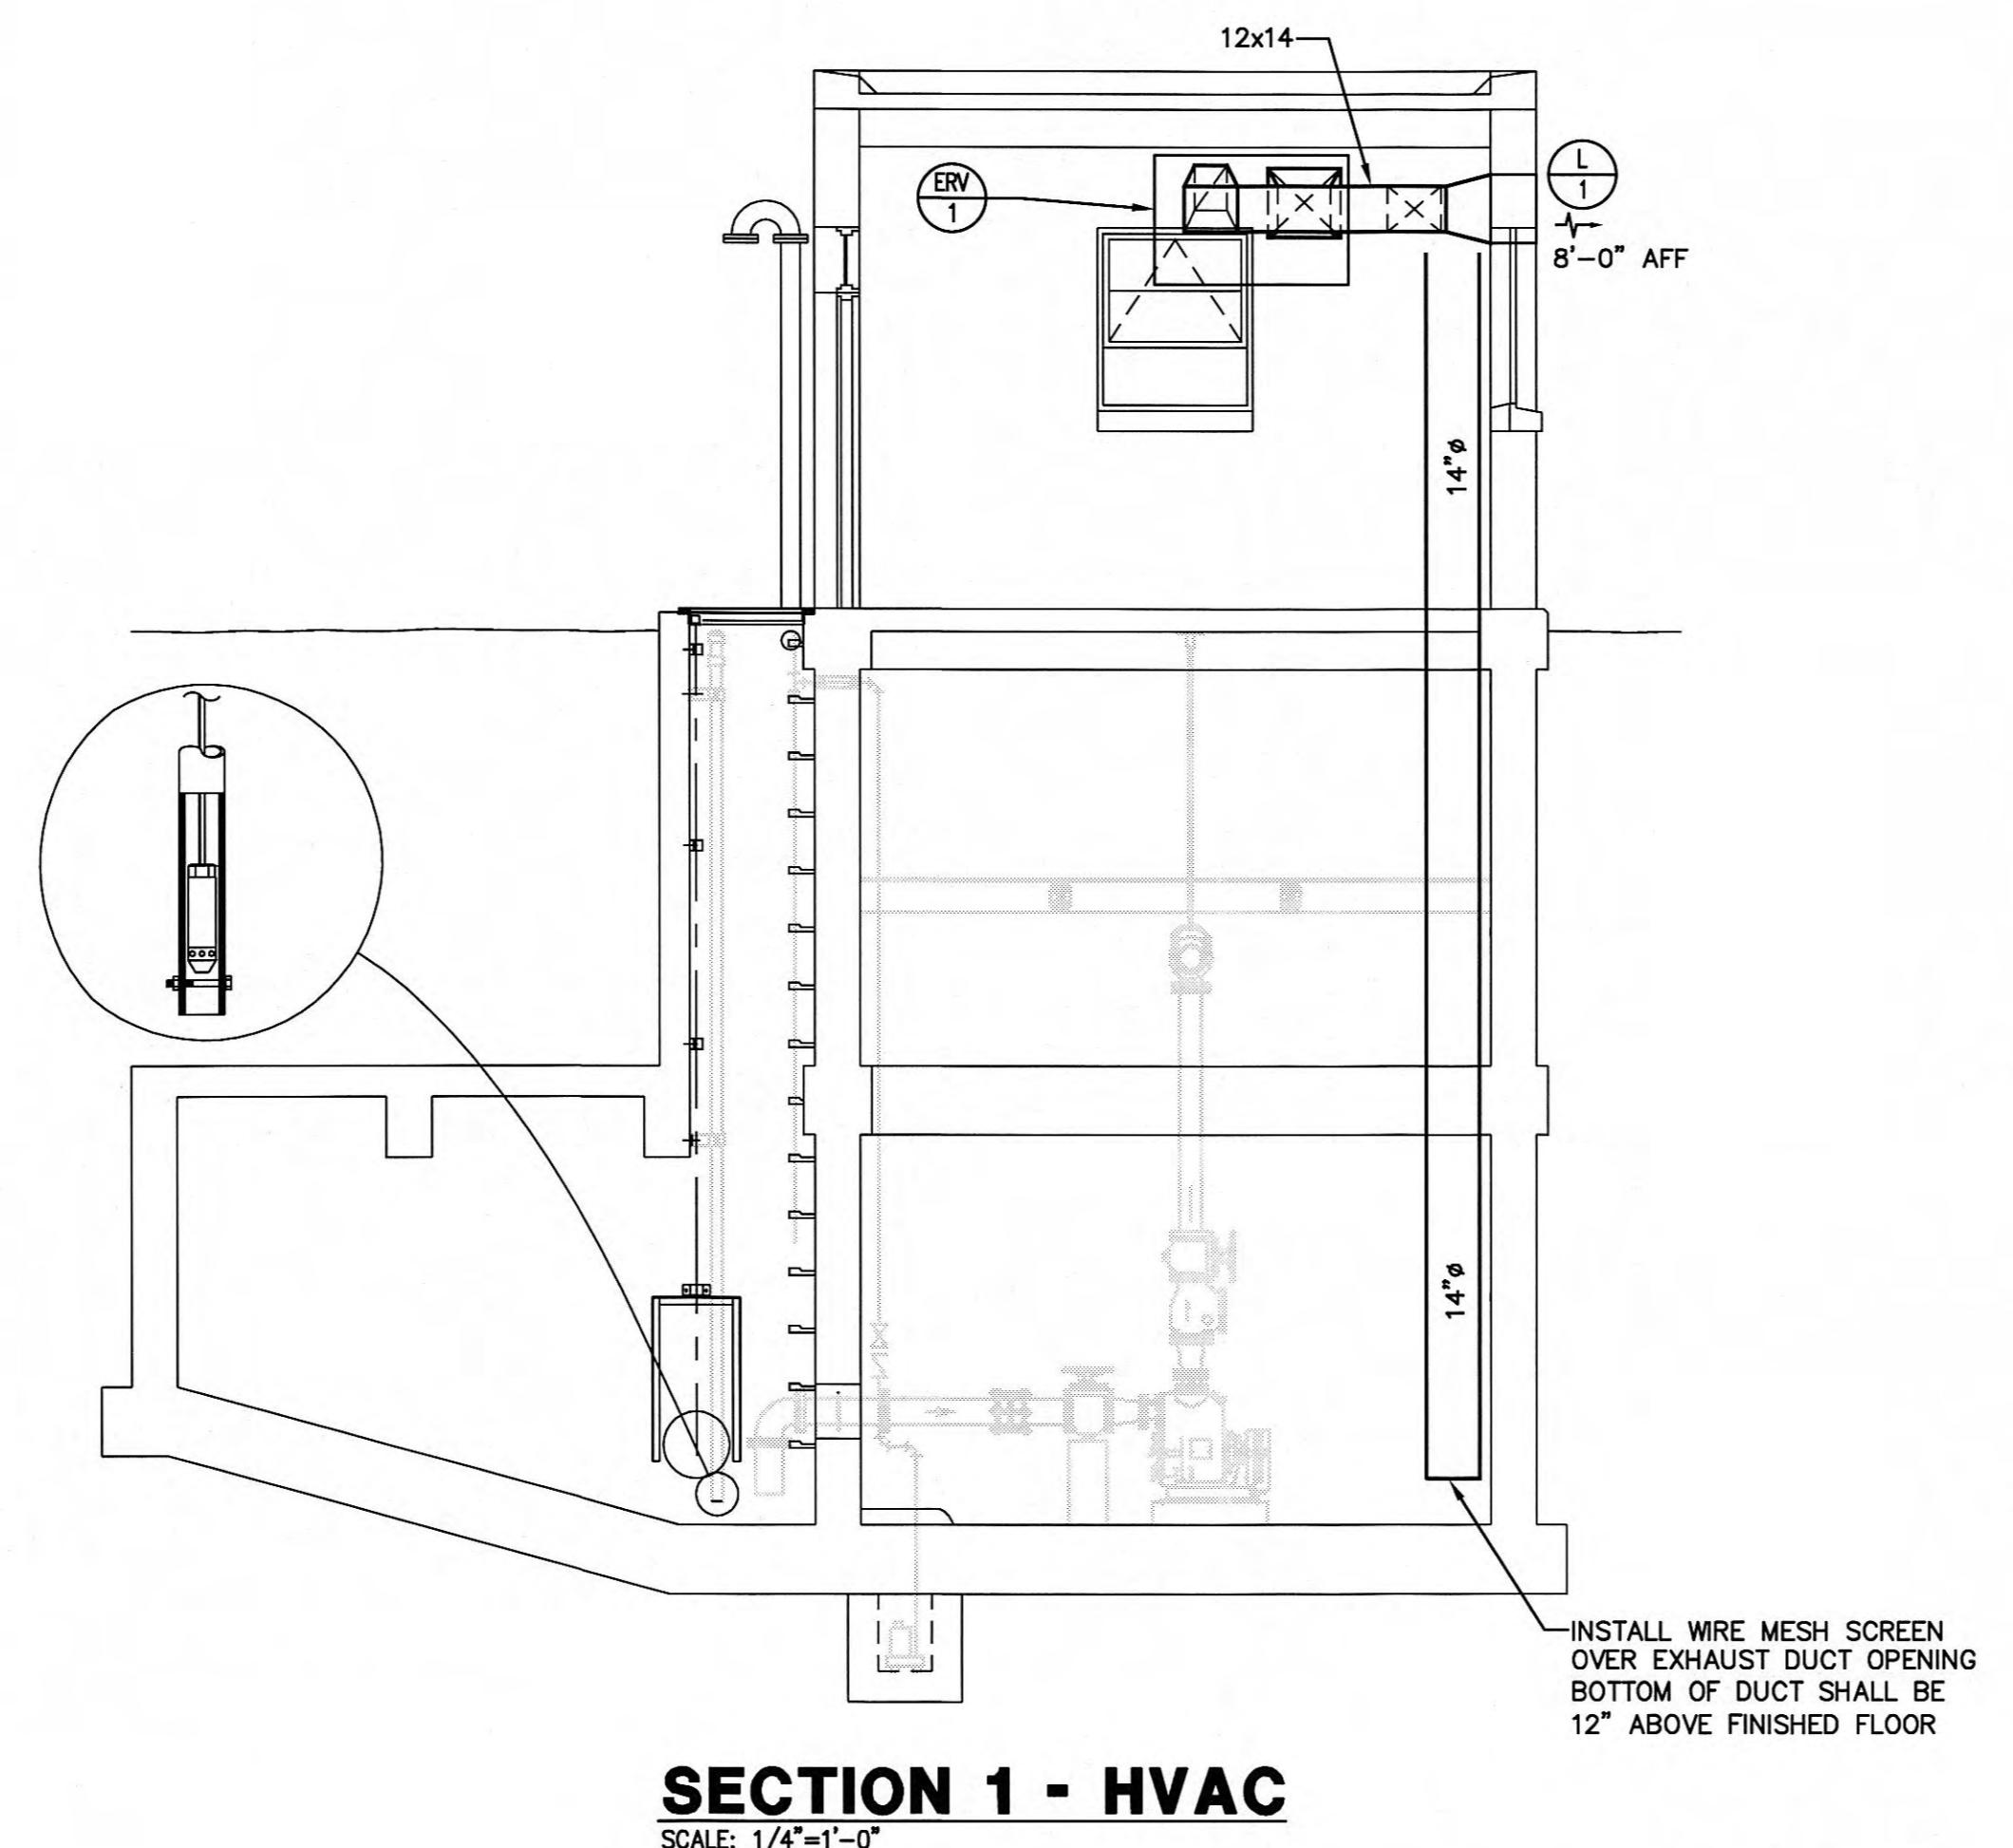SCALE: 1/4"=1'-0"



SECTION 2 - HVAC


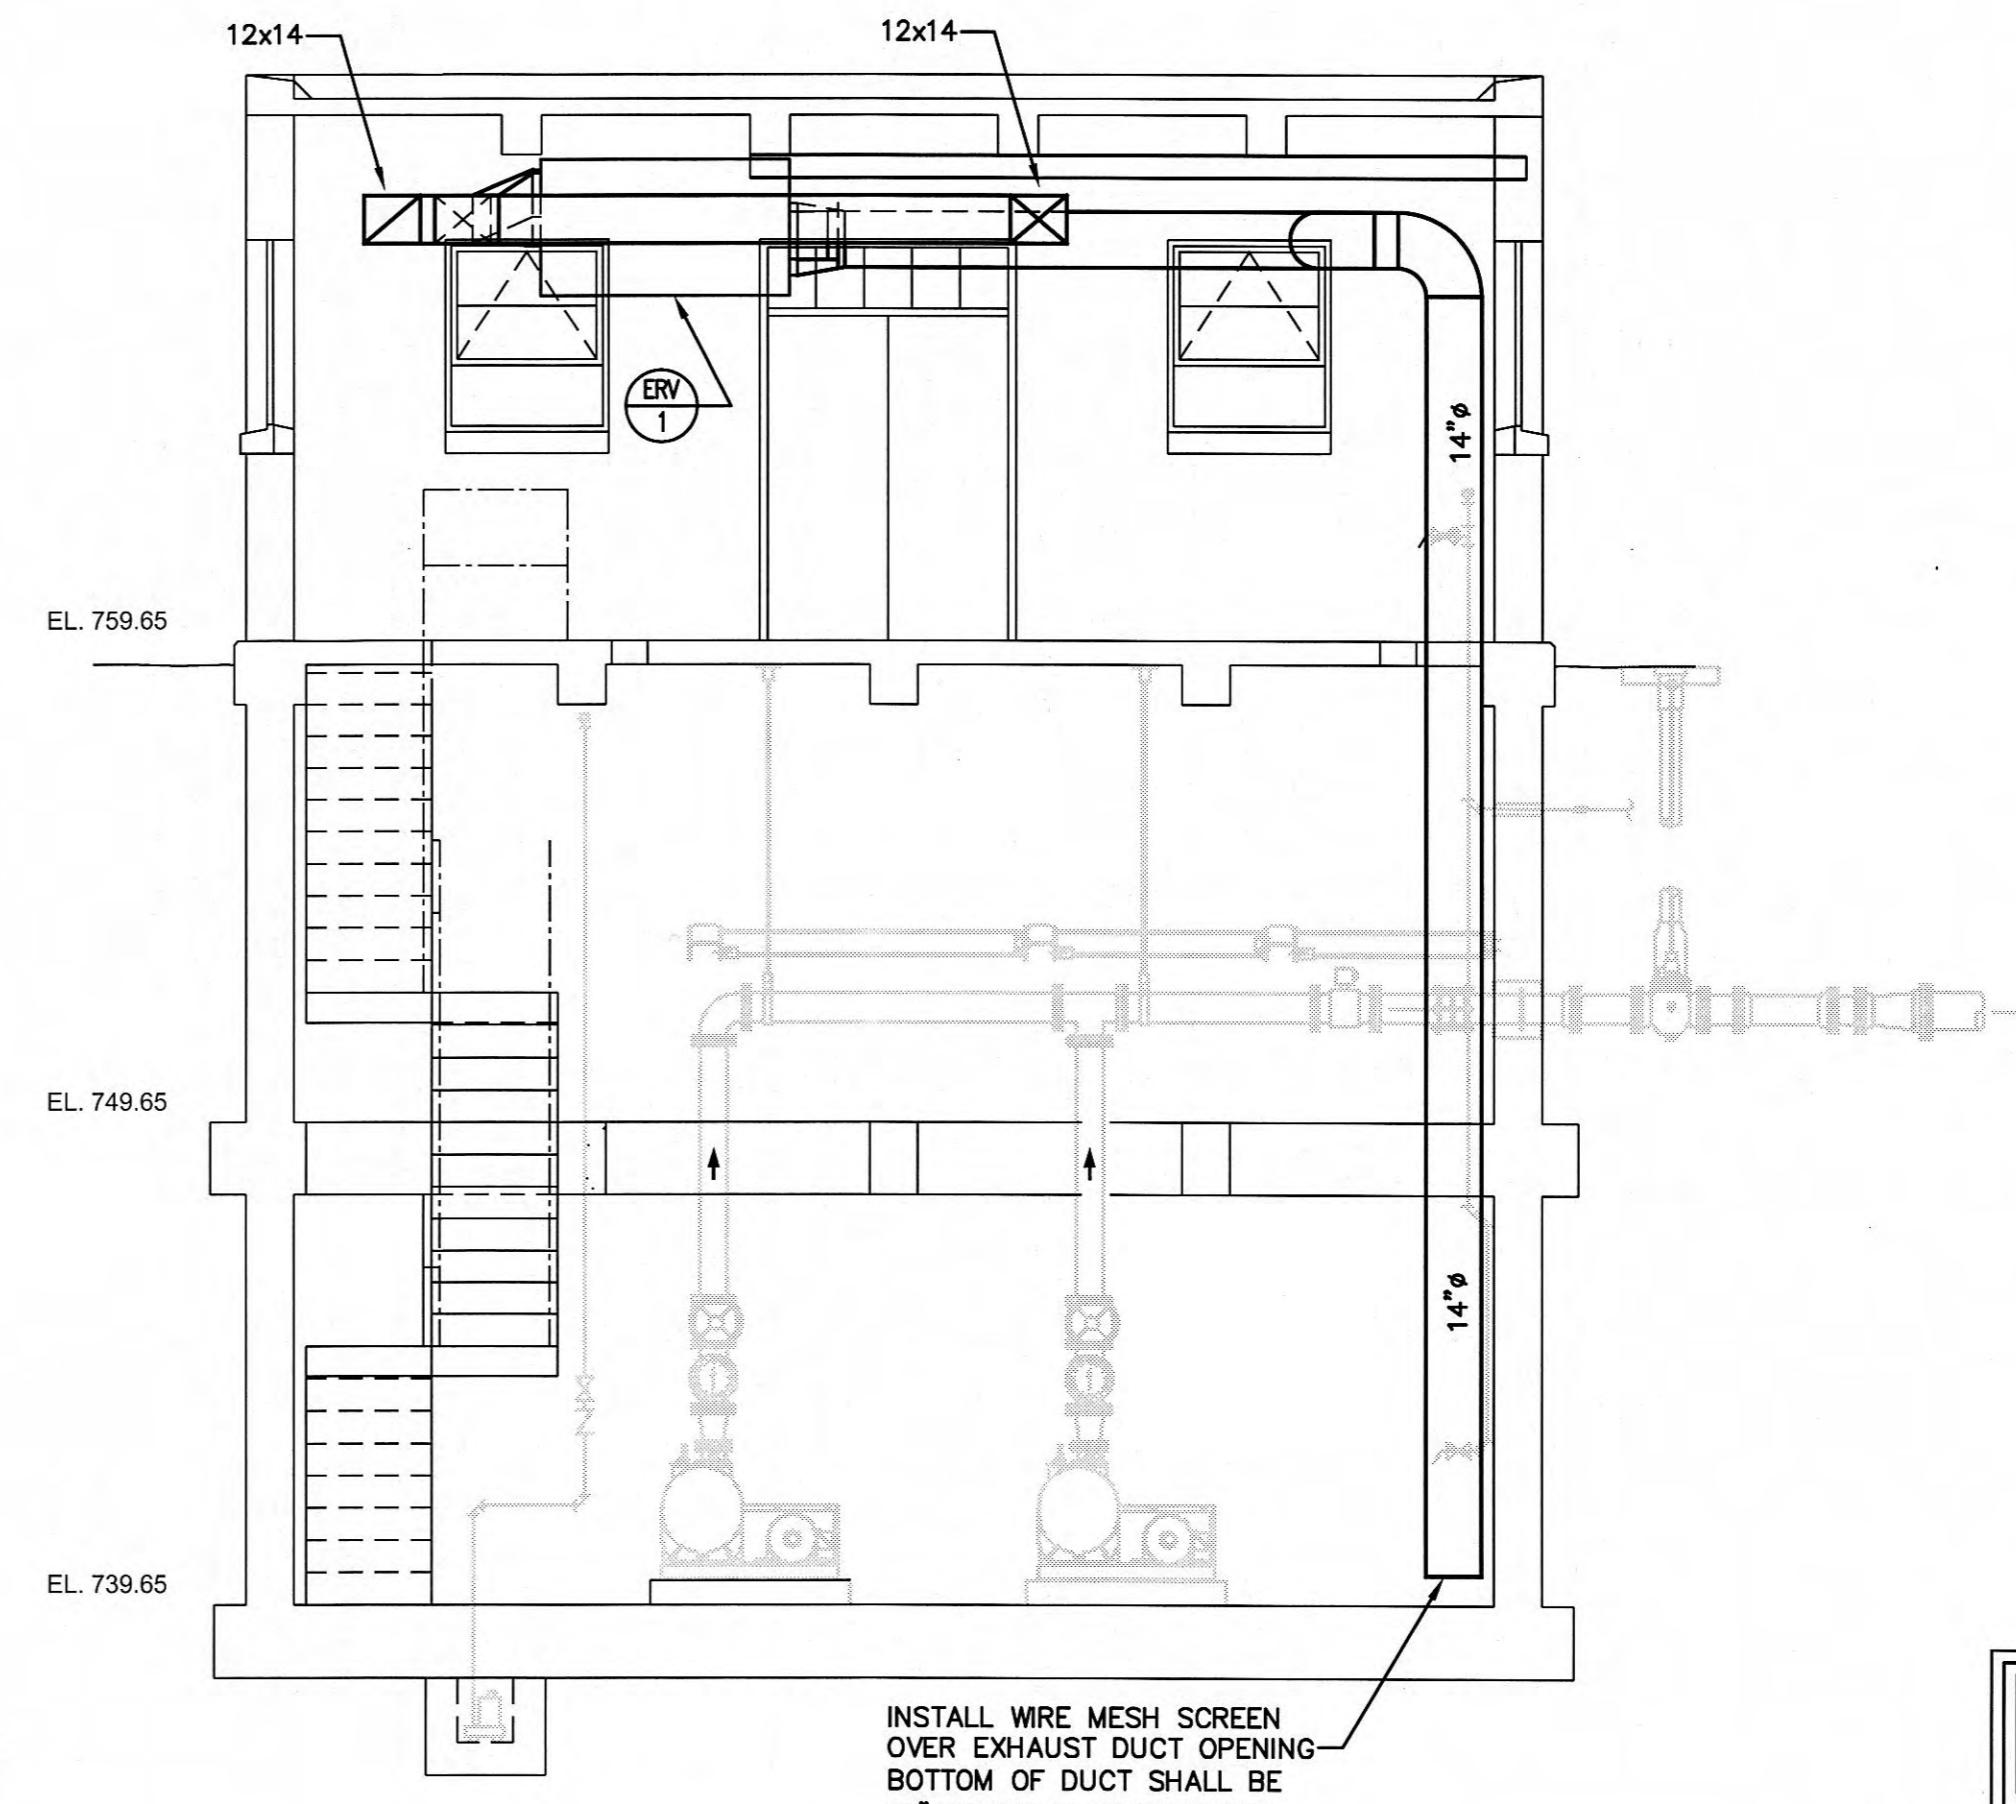
SCALE: 1/4"=1'-0"

WR INEERS INC 5417 Ball Camp Pike
Knoxville, Tn 37921
Phone: (865) 588-2431
Fax: (865) 588-2434
t, Welch, Reed Engineers, Inc.
PROJECT# 112025

RAWING IS GENERALLY DIAGRAMMATIC AND, EXCEPT SPECIFICALLY DIMENSIONED OR DETAILED, INDICATES GENERAL ARRANGEMENT OF THE WORK. THE CONTRACTOR INSTALL HIS WORK TO CONFORM AS NEARLY AS POSSIBLE LOCATIONS AND ARRANGEMENTS SHOWN, WITH ONLY MINOR ADJUSTMENTS AS NECESSARY TO COORDINATE WORK WITH ALL OTHER TRADES TO AVOID INTERFERENCES.

NO.				
DATE:	DECEMBER 2012			
SCALE:				
AS NOTED				
SHEET NO. _____				

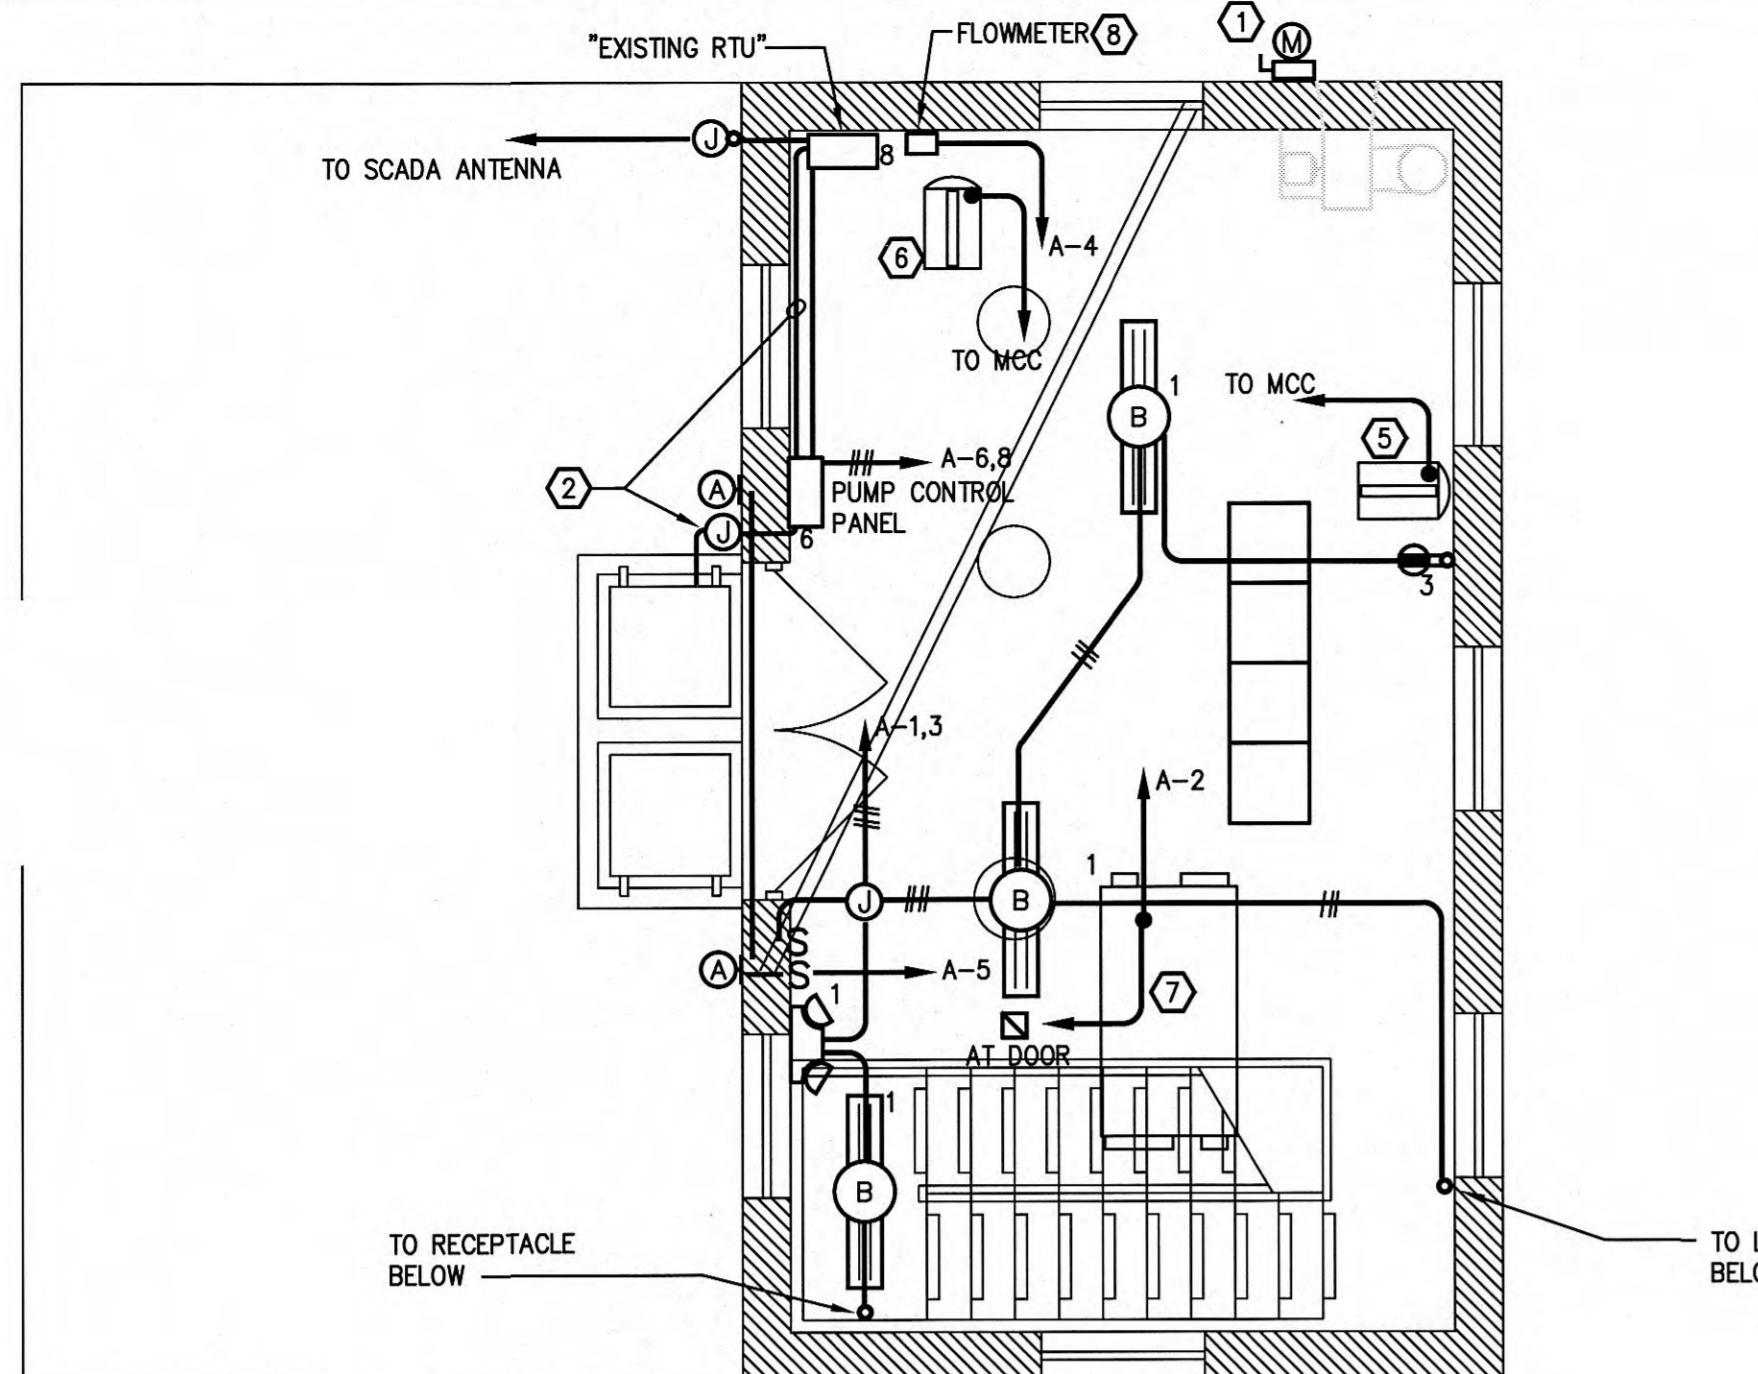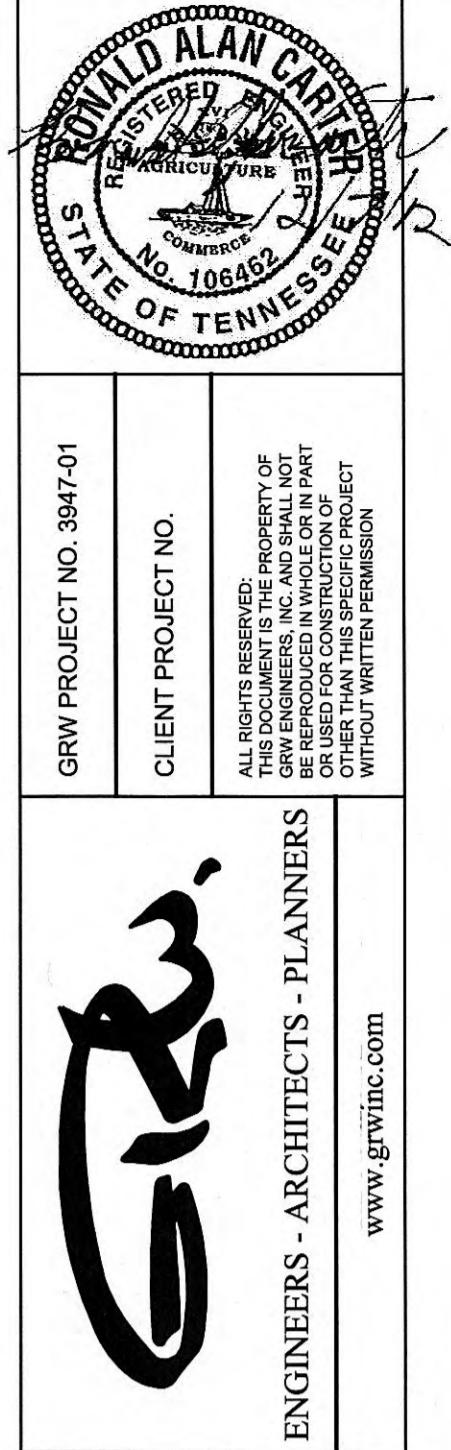M-1



NEW WORK FLOOR PLAN - ENTRANCE

SCALE: 1/4"=1'-0"

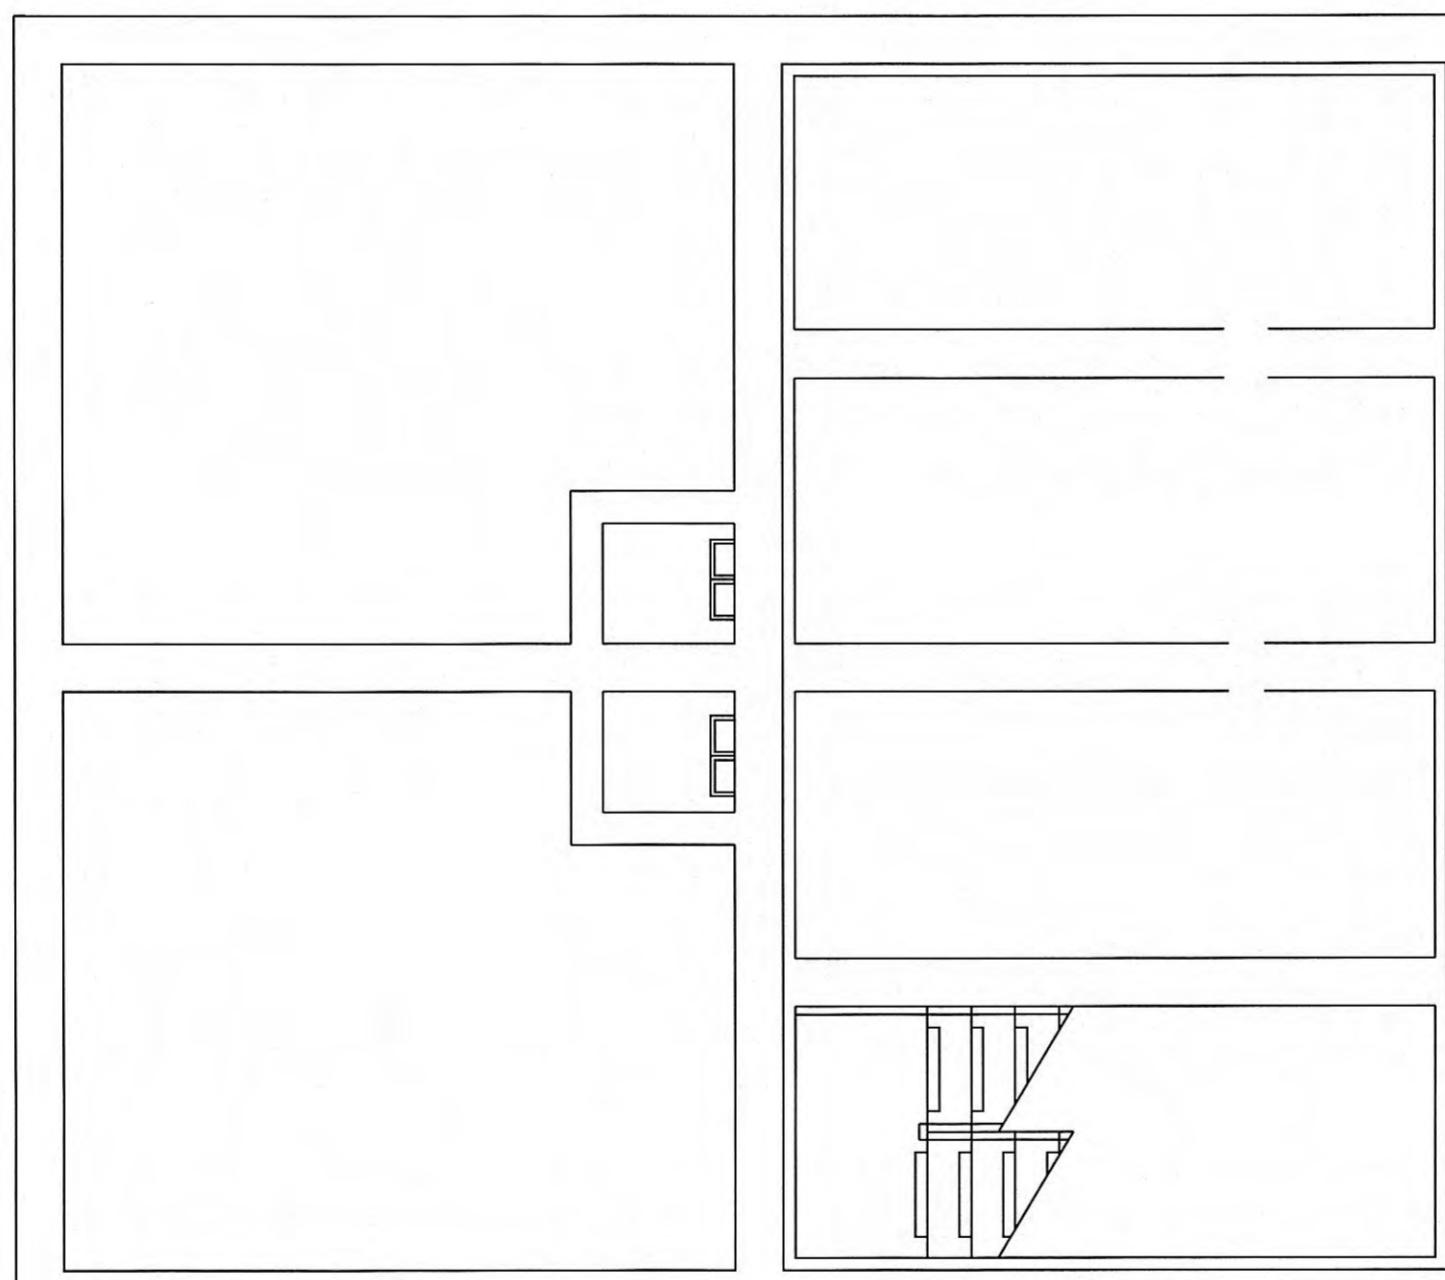
DRAWING NOTES:

- (1) LOCATION OF NEW ELECTRIC METER AND SERVICE DISCONNECT. SEE FEEDER DIAGRAM. MAINTAIN ELEVATION OF DISCONNECTS, CT CABINETS AND METER GREATER THAN 766 FEET.
- (2) 2'C, WITH FLOAT SWITCH AND PRESSURE TRANSDUCER. PROVIDE NEMA 4XSS JUNCTION BOX ON EXTERIOR OF BUILDING AND EXTEND UNDERGROUND TO WETWELL. PROVIDE BELL BUSHING ON CONDUIT PENETRATING WETWELL. SEAL OFF CONDUIT OUTSIDE OF WETWELL. INSTALL PEEL ARTICLE 500 OF NEC. PROVIDE STAINLESS STEEL SUPPORT BRACKET AND KELUM STRAIN RELIEF CABLE GRIPS FOR CABLES.
- (3) PUMP DISCONNECT 30/3 NEMA 4XSS NON FUSED. PROVIDE INTERLOCK KIT FOR VFD SHUTDOWN CONTACT.
- (4) SUMP PUMP WITH NEMA 4XSS STARTER AND DISCONNECT 208V, 1PH. SEE CONTROL DIAGRAM E5.
- (5) UNIT HEATER 10KW, 480V, 3Ø, 3/4"C, 3#12, #12GND.
- (6) UNIT HEATER 7.5KW, 480V, 3Ø, 3/4"C, 3#12, #12GND.
- (7) ERV, 2-1/2HP, 120V, 3/4"C, 2#10, #10GND. PROVIDE MANUAL MOTOR STARTER WITH OVERLOADS PER NAMEPLATE.
- (8) FLOWMETER RECEIVER, CONNECT TO 120V AS INDICATED. PROVIDE CONTROL WIRING AND CONDUIT TO RTU AS SHOWN ON SHEET E6. PROVIDE GROUNDING AT METER PER MANF. RECOMMENDATIONS.

NEW WORK FLOOR PLAN - INTERMEDIATE

SCALE: 1/4"=1'-0"

EXR



DEMOLITION FLOOR PLAN - INTERMEDIATE

SCALE: 1/4"=1'-0"

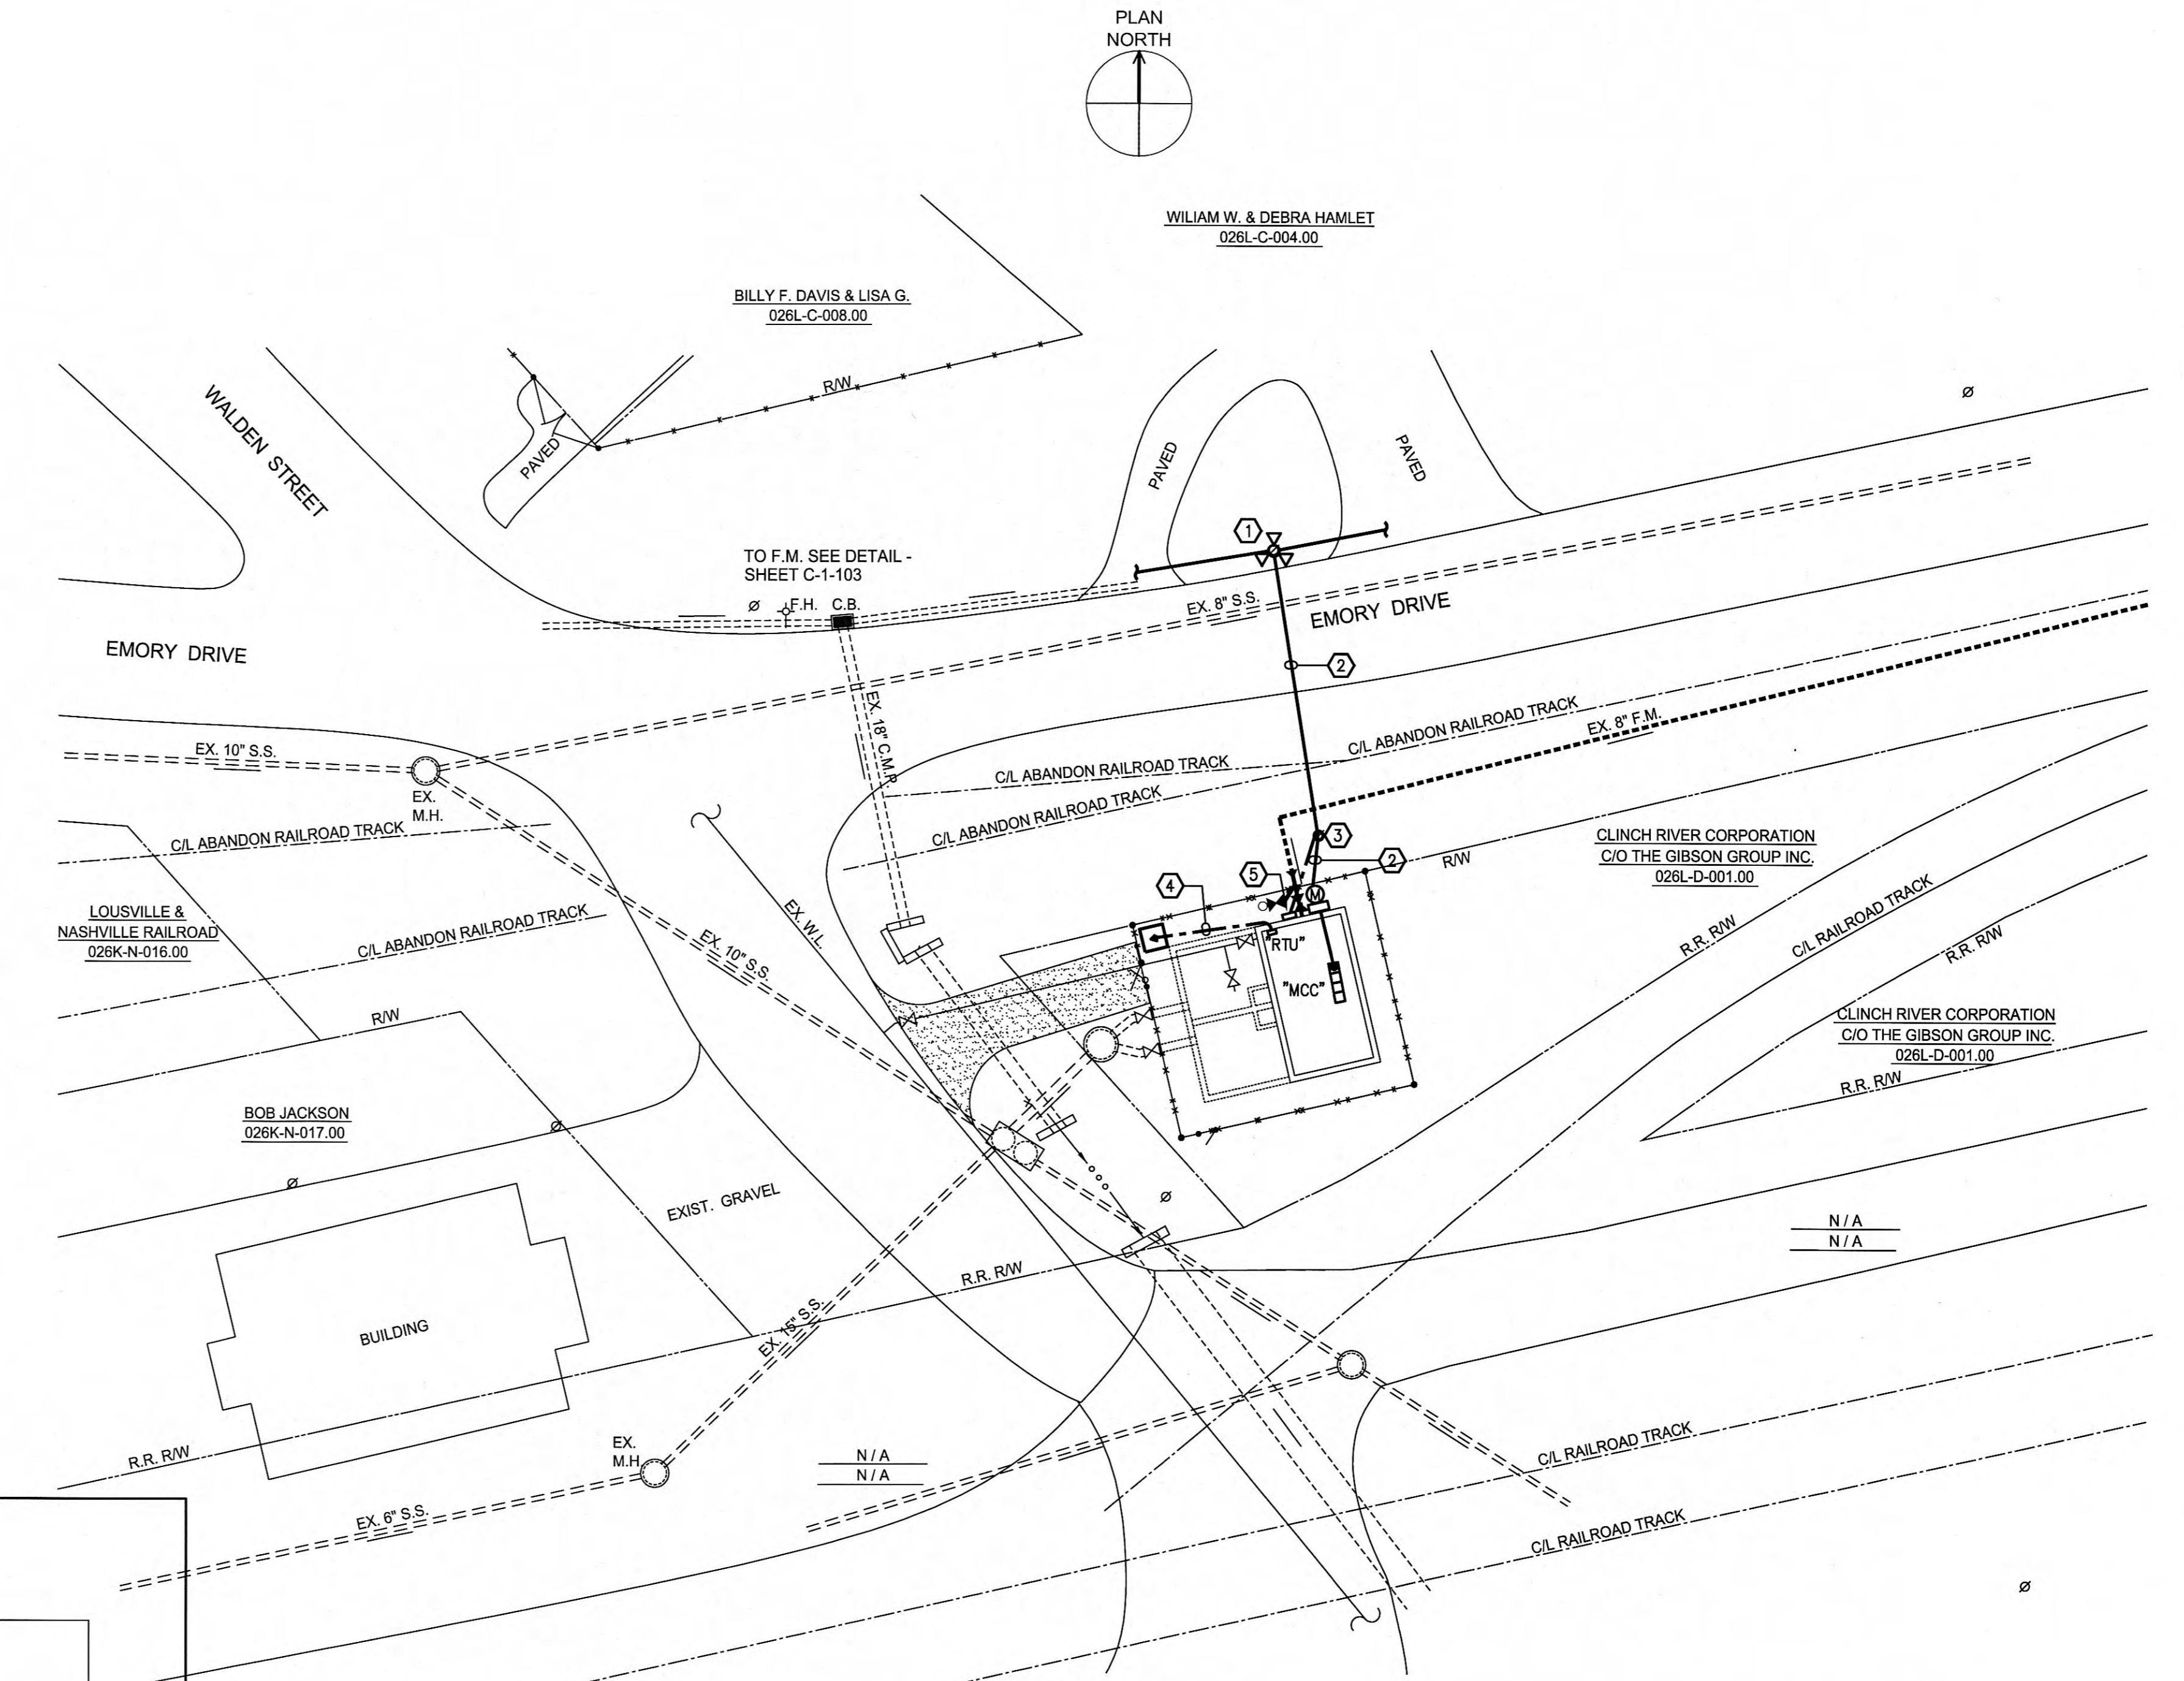
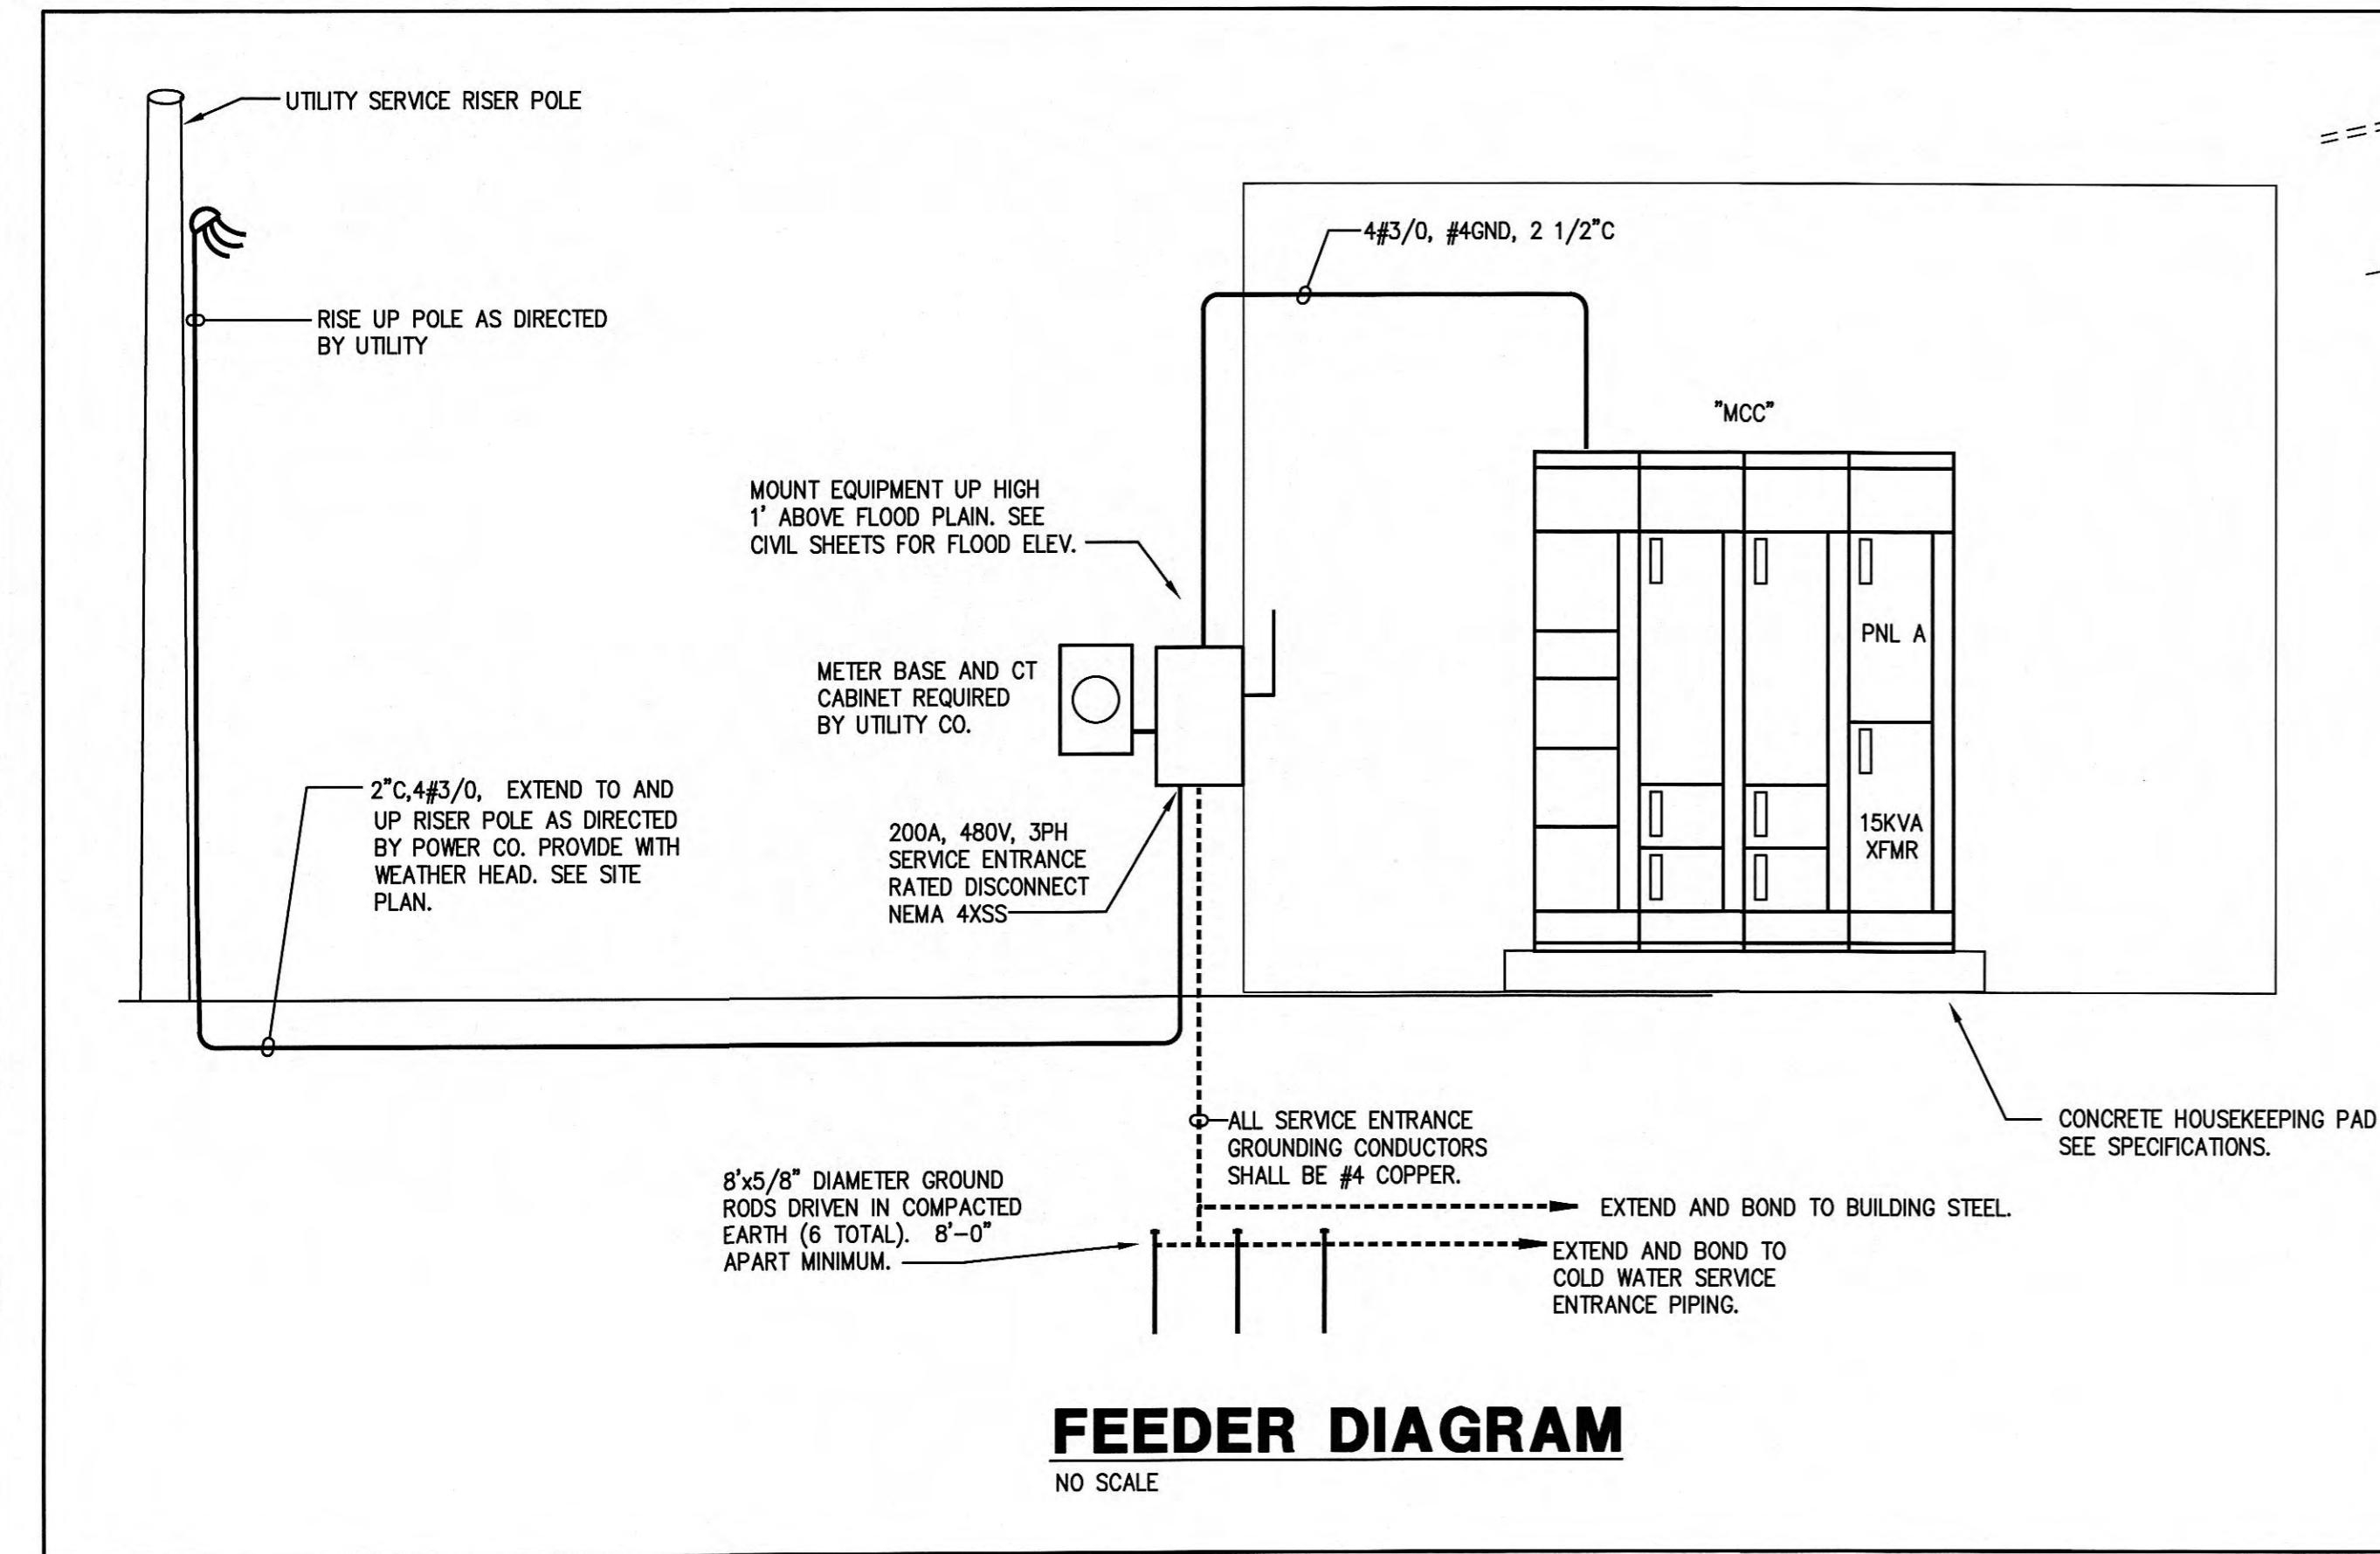
EXR

HOA

I


F

EXR



LADD PUMP STATION SITE PLAN - ELECTRICAL

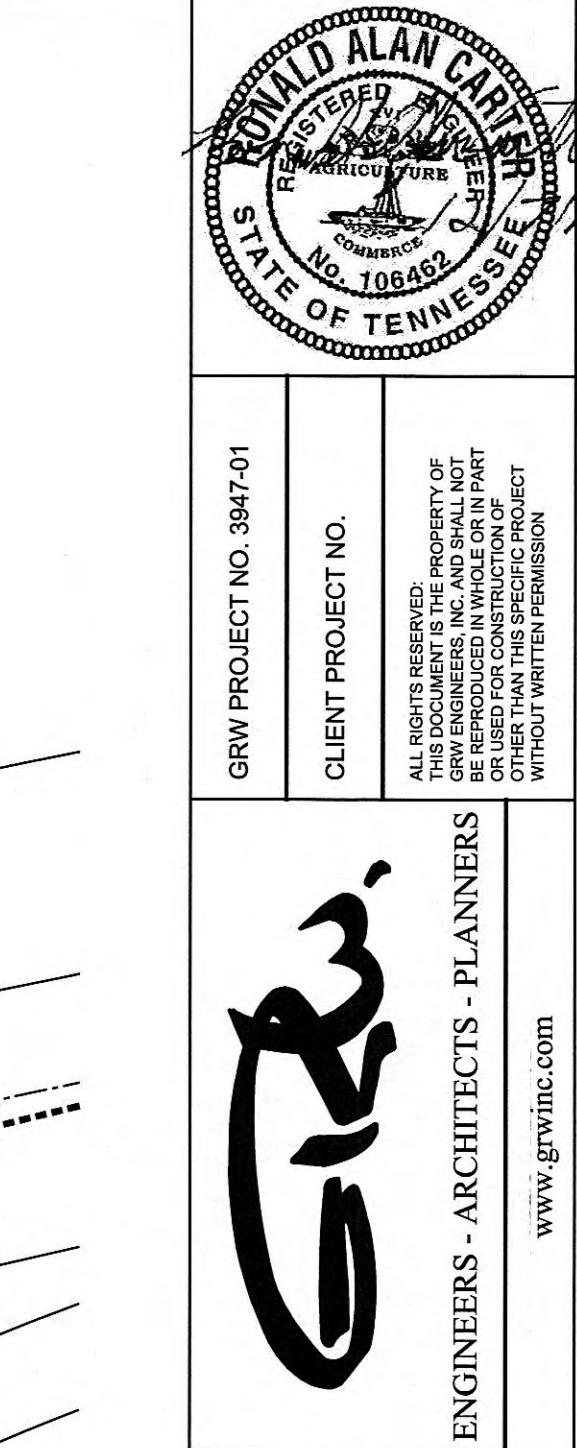SCALE: 1" = 2




LADD PUMP STATION SITE PLAN - ELECTRICAL

EEC RIC PUMP STATION REHABILITATION CITY OF HARRIMAN, TENNESSEE

SCALE CHECK: _____ THIS MARK SHOULD MEASURE EXACTLY 1" WHEN PLOTTED
APPROVED: _____ RAC





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MCDONALD PUMP STATION SITE PLAN - ELECTRICAL

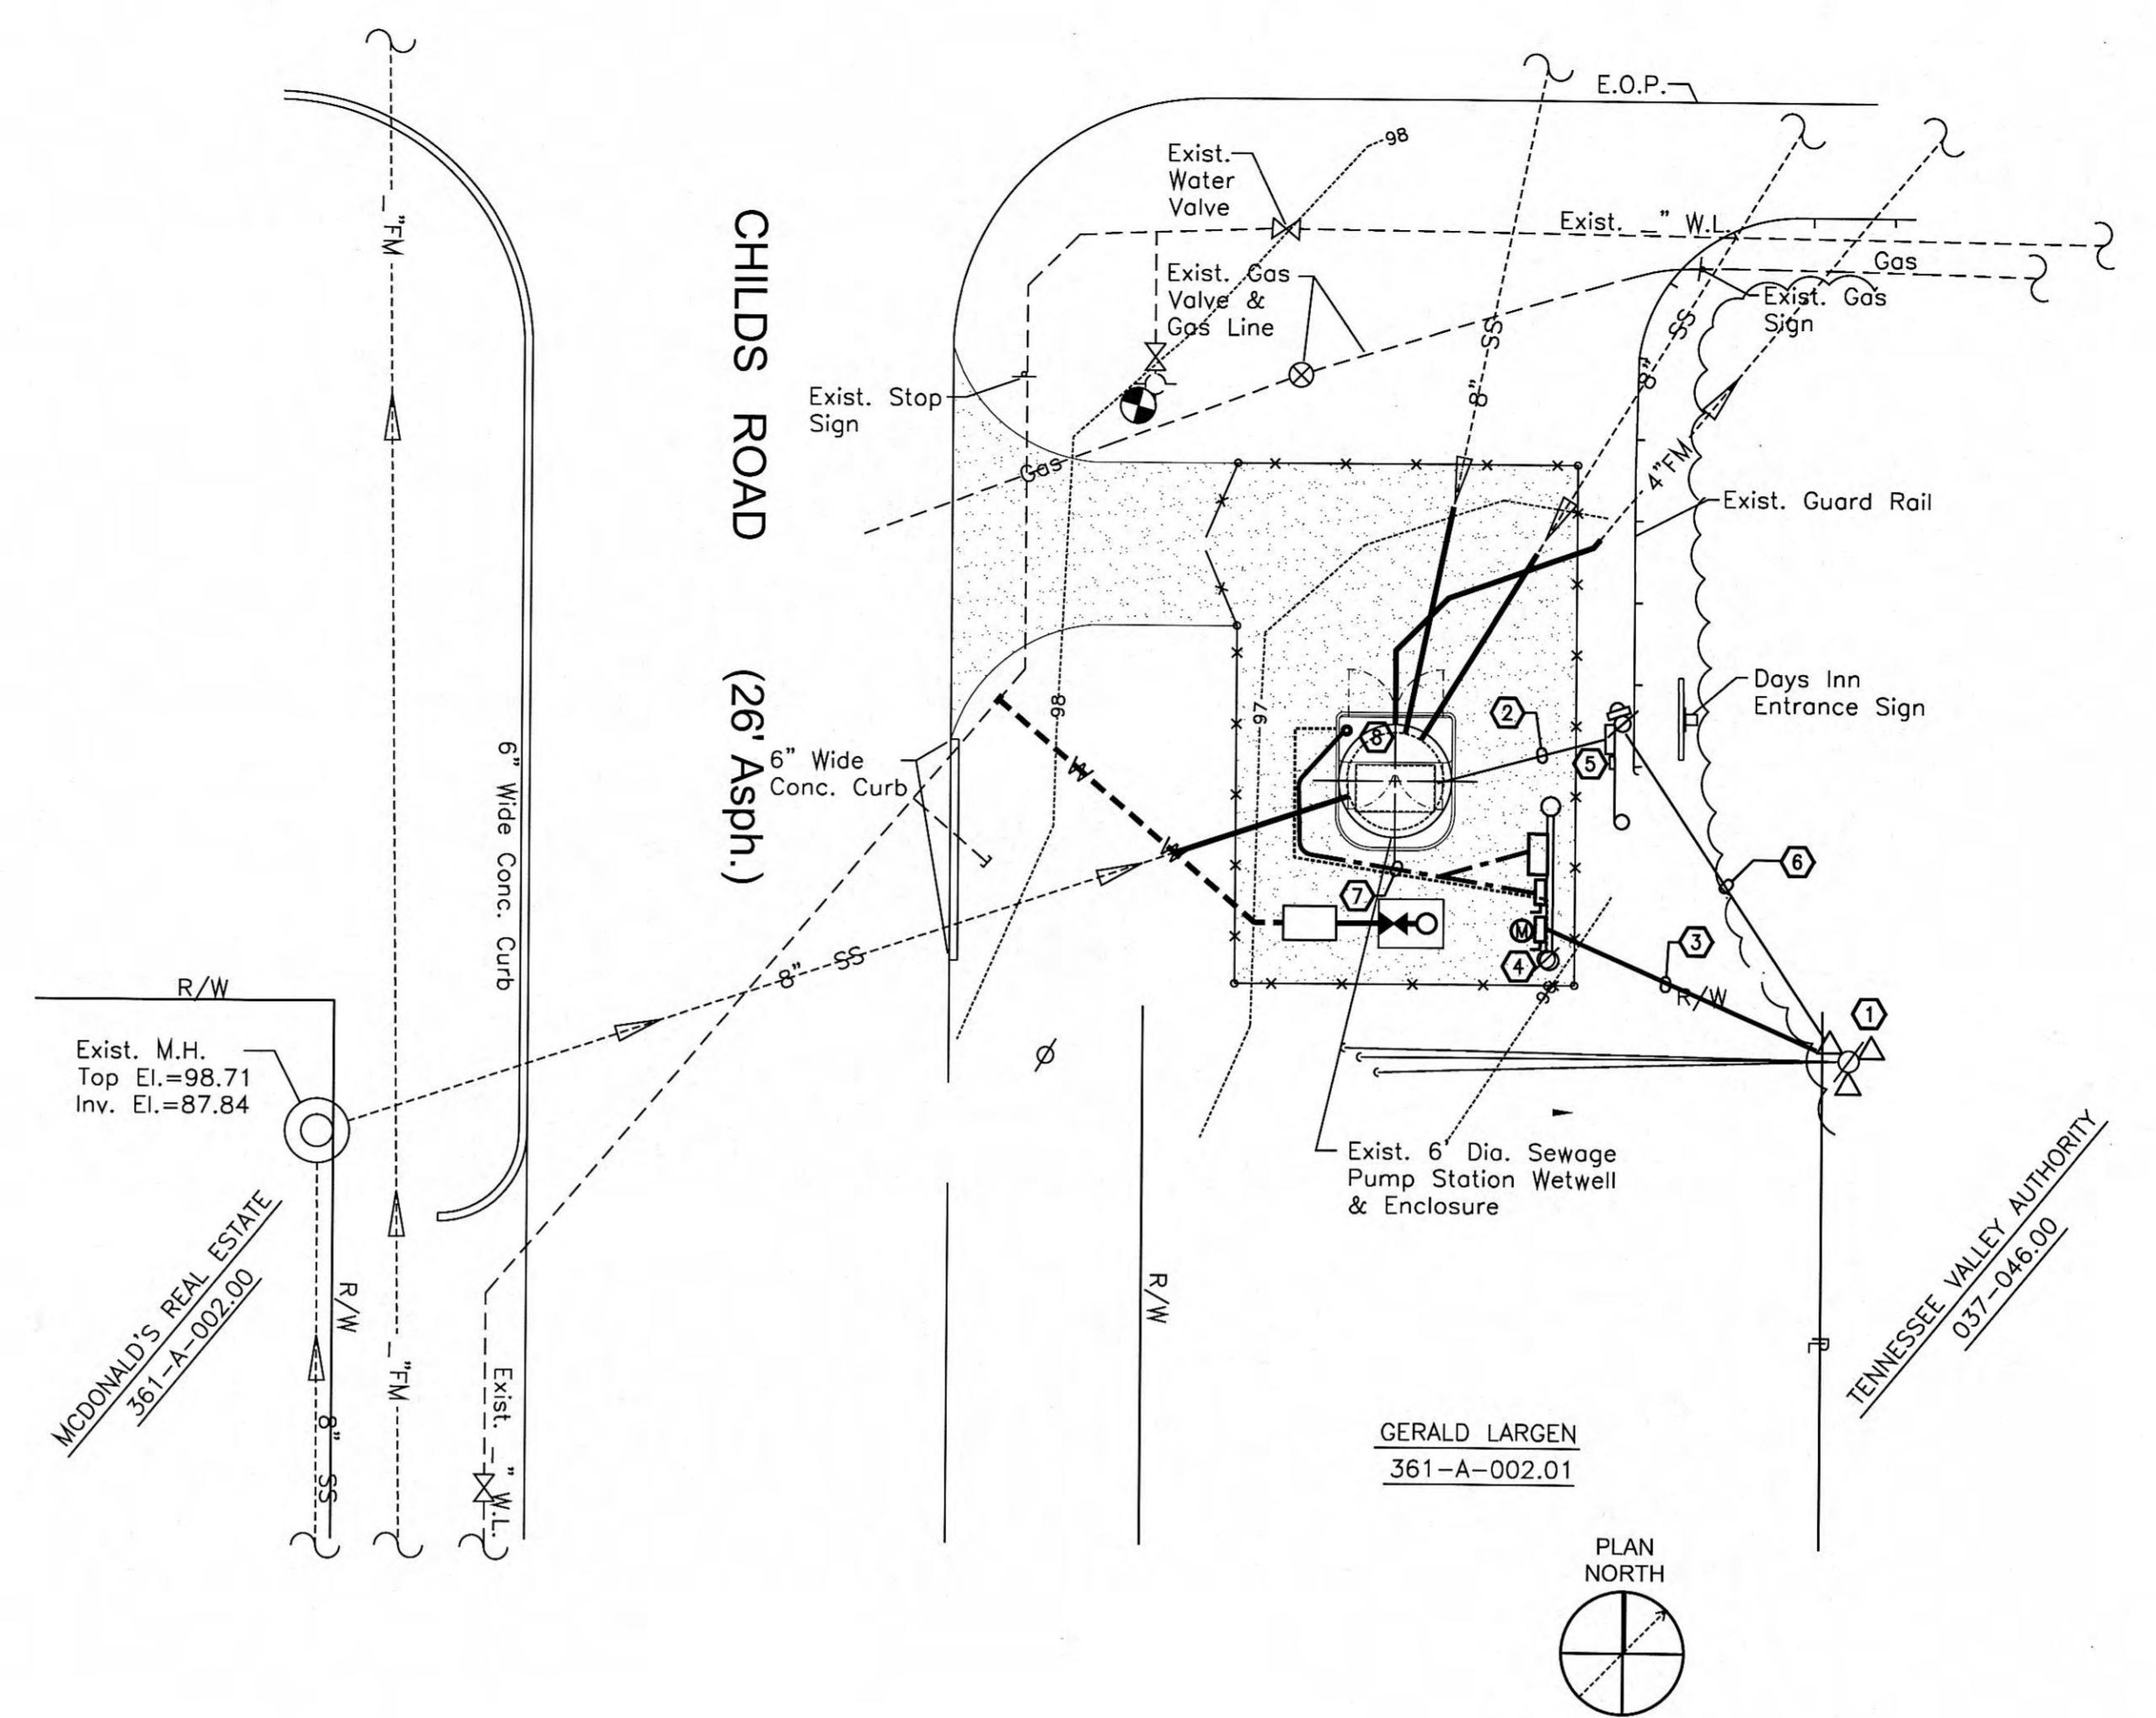SCALE: 1" = 10'



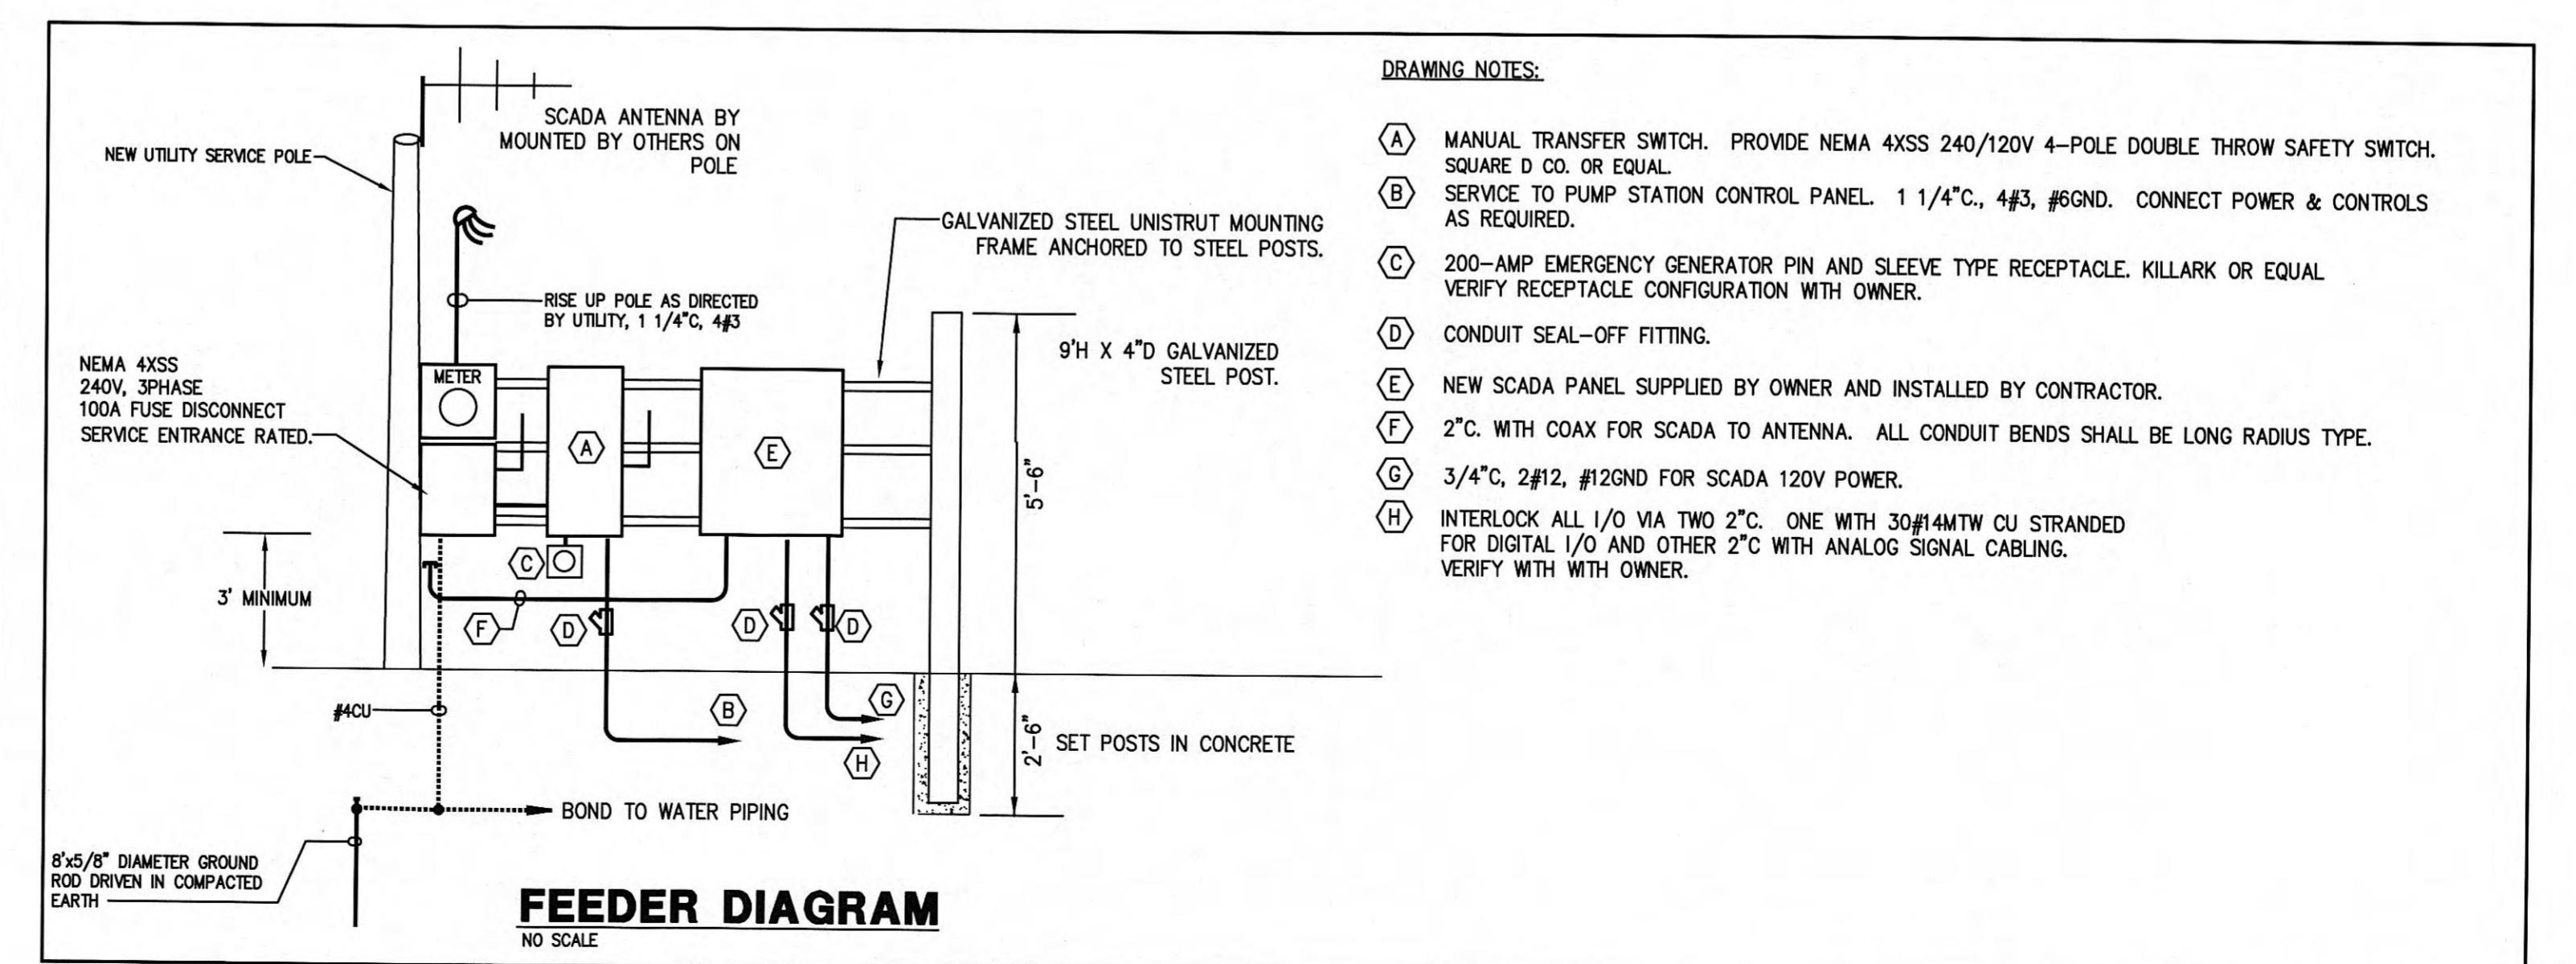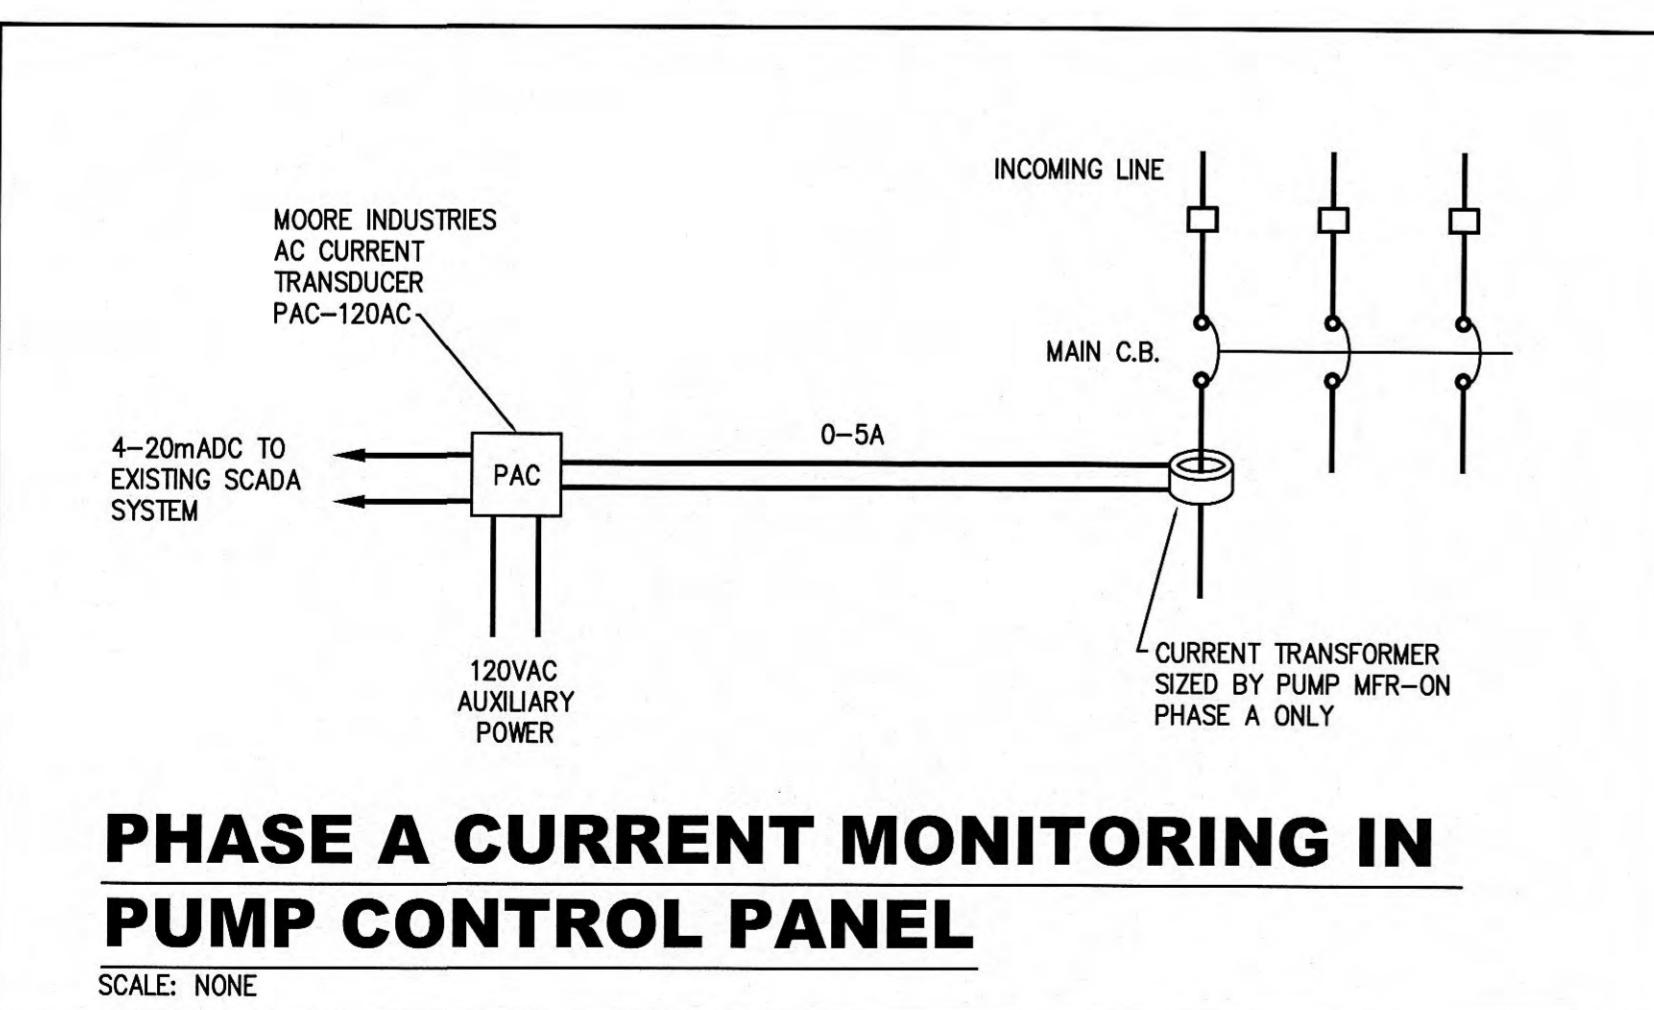SITE UTILITIES NOTE
PRIOR TO STARTING SERVICE ENTRANCE WORK, THE CONTRACTOR SHALL CONTACT THE LOCAL POWER COMPANY & SHALL DETERMINE ALL REQUIREMENTS FOR THE PROJECT. LABOR AND MATERIALS UNDER THE CONTRACT ARE TO BE PAID FOR EACH DAY THE PROJECT IS COMPLETE. CONTRACTOR SHALL PAY ALL FEES & CONTRIBUTIONS TO CONSTRUCTION REQUIRED BY THE LOCAL POWER COMPANY.

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West, Welch, Reed Engineers, Inc.
WWR PROJECT# 112025

SCALE: 1" = 10'
SHEET NO. DECEMBER 2012
SCALE CHECK

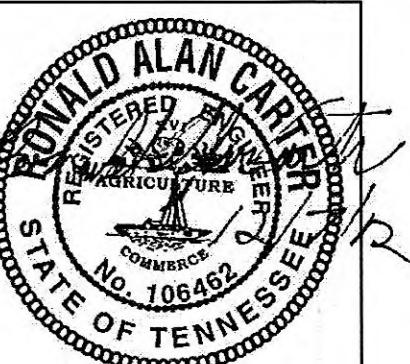
MCDONALD PUMP STATION SITE PLAN - ELECTRICAL

PUMP STATION REHABILITATION
CITY OF HARRIMAN, TENNESSEE

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